EFFECTS REPORT FOR THE US 41 INTERSECTION IMPROVEMENT PROJECT DES NO. 2000186 DHPA NO. 27933 EVANSVILLE, VANDERBURGH COUNTY, INDIANA

1) Project Location

The Indiana Department of Transportation (INDOT), with funding from the Federal Highway Administration (FHWA), proposes to proceed with a project involving the construction of a Reduced Conflict Intersection (RCI) at US 41 and Washington Avenue (Des. No. 2000186), approximately 1.00 mile south of the intersection of US 41 and SR 66/SR 62 (Lloyd Expressway) in the city of Evansville, Vanderburgh County, Indiana.

The proposed undertaking is located at the intersection of US 41 and Washington Avenue in the city of Evansville, Vanderburgh County, Indiana. It is within Knight Township, as shown on the Evansville, South, Indiana, USGS Topographic Quadrangle, in Sections 28 & 33, Township 6 South, Range 10 West (see Appendix A [maps]).

Given the nature of the proposed project, the APE was determined to include the proposed project area and a buffer zone based on topography and vegetation surrounding the proposed intersection improvement location. Visual impacts were the driving factor in the creation of the APE, as the project area is visible from surrounding commercial buildings and residences. The APE takes into account the potential direct and indirect effects of the proposed project within the immediate contextual setting, which is comprised of a heavily urbanized area with commercial and residential lots with scattered trees.

2) Project Description

The need for the project is based on the existing crash rates and safety concerns with this intersection. Based on the abbreviated engineer report for the project completed by HNTB, Corporation (HNTB) in January 2020, between 2016 and 2018, there were 15 Fatal and/or Incapacitating Crashes, 15 Non-Incapacitating and Possibly Injury Crash and 85 Property Damage Only Crashes making this intersection a "high crash" location. The purpose of this project is to improve the safety of the intersection.

Currently, the intersection of US 41 and Washington Avenue consists of two northbound and two southbound US 41 lanes with a left-turn lane for each direction separated by a grassy median. Washington Avenue consists of one westbound and one eastbound lane with a right-turn lane and a left-turn lane in each direction.

In order to meet the project purpose and need, a reduced conflict intersection will be constructed at the intersection of US 41 and Washington Avenue. The preferred option is the Boulevard Left intersection type. The Boulevard Left intersection relocates left turns from all legs of the main intersection to median U-turns located approximately 700 feet north and south of Washington Avenue. This intersection type retains the east-west connectivity on

Washington Avenue. The Boulevard Left intersection has fewer signal phases than other types of reduced conflict intersections and provides better mobility to eastbound-westbound traffic on Washington Avenue, which is a minor arterial. The project will also include directional signage, maintenance of drainage within the project extents, replacement of traffic signals at the main intersection, and the installation of new traffic signals at the median U-turn locations. There is no permanent or temporary right-of-way (ROW) acquisition anticipated for this project (see Appendix C [plans]).

Any median crossing work will be constructed prior to the closing of the intersection to allow for traffic movements to be open during construction. US 41 will be reduced to one lane in each direction during construction. Pedestrian maintenance of traffic will be required.

The proposed project area for the intersection improvement project, located at the intersection of US 41 and Washington Avenue, begins on US 41 approximately 560 feet (0.12 mile) south of its intersection with Bellemeade Avenue and extends south along US 41 for approximately 2,600 feet (0.5 mile). The project also begins along Washington Avenue approximately 430 feet (0.08 mile) west of its intersection with US 41 and extends approximately 1,010 feet (0.19 mile) east along Washington Avenue (see Appendix A [maps] and Appendix C [plans]).

3) Describe Affected Historic Properties

CRA did not identify any archaeological sites eligible for listing in the National Register of Historic Preservation (NRHP). The SHPO concurred in a letter dated January 7, 2022.

Lincolnshire Historic District (NR-0908) – The Lincolnshire Historic District was listed in the NRHP in 1989 under Criteria A and C for its significance relating to architecture, commerce, and community planning and development. The district contains 97 "Contributing" and 22 "Non-Contributing" resources that are a mix of Tudor and Colonial Revival commercial and residential properties from the early to mid-twentieth century, some of which were designed by Anderson & Veatch, an Evansville design firm (see Appendix A [maps] and Appendix B [photos]).

Akin Park Historic District (IHSSI No. 163-196-430[01-213]) — The Akin Park Historic District is an excellent example of community planning and development in Evansville during the early to mid-twentieth century. The architecturally diverse residences represent the desire to have a fashionable, well-planned residential neighborhood utilizing local architects. Approximately 190 previously surveyed resources range from "contributing" to "outstanding," and are set within an urban landscape dotted with mature trees. The district also contains approximately 21 non-contributing resources. The resources are a mix of single-family and multifamily dwellings along with Akin Park. The district features an array of architectural styles such as Craftsman Bungalows, Colonial Revival, Contemporary, Tudor Revival, and vernacular (see Appendix A [maps] and Appendix B [photos]).

Historically, a portion of the district was the location of the Tri-State Fairgrounds that closed in 1912. After the fairgrounds closed, the area was developed into the Akin Park

Neighborhood. The area today looks much the same as it did during the early twentieth century, situated within an urban area of Evansville.

The Akin Park Historic District is recommended eligible under Criterion A as it illustrates a planned and meticulously designed neighborhood in Evansville during the early to midtwentieth century. Evidence of a planned neighborhood include the boulevards and centrally located park of which the residential neighborhood is centered around.

The Akin Park Historic District is also recommended eligible under Criterion C. The district features a cohesive collection of representative structures that embody the distinctive characteristics of early and mid-twentieth century architectural styles with original materials and forms along with locally designed residences.

The Akin Park Historic District's recommended NRHP boundary is a follows: roughly bounded by the north side of Madison Avenue, west side of South Kentucky Avenue, Ravenswood Drive, south side of Covert Avenue, and Gilbert Avenue (see Appendix A [maps]).

4) Describe Effects to Historic Properties

There will be no physical effects to the Lincolnshire Historic District or to the Akin Park Historic District. There is no permanent or temporary ROW acquisition associated with this project.

The traffic signals and signage located at the intersection of Washington Avenue and US 41 will be replaced in-kind with modern materials of approximately the same height. Additionally, a Boulevard Left intersection will result in the construction of two U-turns with traffic signals, eliminating the left-turn lanes for northbound and southbound lanes of US 41, also near, but not within the historic districts (see Appendix A [maps] and Appendix C [plans]). The project is located adjacent to the Lincolnshire Historic District's and Akin Park Historic District's recommended NRHP boundaries.

5) Explain Application of Criteria of Adverse Effect

According to 36 CFR § 800.5(a)(1), an adverse effect is found in the Section 106 process "when an undertaking may alter, directly or indirectly, any of the characteristics of a historic property that qualify the property for inclusion in the NRHP in a manner that would diminish the integrity of the property's location, design, setting, materials, workmanship, feeling, or association. Adverse effects may include reasonably foreseeable effects caused by the undertaking that may occur later in time, be farther removed in distance or be cumulative." Per 36 CFR § 800.5(a)(2), examples of adverse effect include but are not limited to:

- (i) Physical destruction of or damage to all or part of a property;
- (ii) Alteration of a property, including restoration, rehabilitation, repair, maintenance, stabilization, hazardous material remediation, and provision of handicapped access not consistent with the Secretary's Standards for the Treatment of Historic Properties (36 CFR part 68) and applicable guidelines;

- (iii) Removal of the property from its historic location;
- (iv) Change of the character of the property's use or physical features within the property's setting that contribute to its historic significance;
- (v) Introduction of visual, atmospheric, or audible elements that diminish the integrity of the property's significant historic features;
- (vi) Neglect of a property which causes its deterioration, except where such neglect and deterioration are recognized qualities of a property of religious and cultural significance to an Indian tribe or Native Hawaiian organization; and
- (vii) Transfer, lease, or sale of a property out of Federal ownership or control without adequate and legally enforceable restrictions or conditions to ensure long-term preservation of the property's historic significance.

The discussion below considers the effects of the undertaking, using the examples given in 36 CFR 800.5(a)(2), on the historic resources within the area of potential effects (APE) for this undertaking: the Lincolnshire Historic District (NR-0908) and the Akin Park Historic District (IHSSI No. 163-196-430[01-213]).

Lincolnshire Historic District (NR-0908) – According to 36 CFR 800.5(a)(1) the criteria of adverse effect do not apply.

Per 36 CFR 800.5(a)(2)(i), the undertaking will not result in the "Physical destruction of or damage to all or part of the property." None of the NRHP-listed district resources will be damaged. No permanent or temporary ROW will be acquired from the historic district.

Per 36 CFR 800.5(a)2(ii), the undertaking will not cause "Alteration of a property, including restoration, rehabilitation, repair, maintenance, stabilization, hazardous material remediation and provision of handicapped access, that is not consistent with the Secretary's Standards for the Treatment of Historic Properties and/or other applicable guidelines."

Per 36 CFR 800.5(a)2(iii), the undertaking will not result in the "Removal of the property from its historic location."

Per 36 CFR 800.5(a)2(iv), the undertaking will not result in a "Change of the character of the property's uses or of physical features within the property setting that contribute to the historic significance" of the property. The proposed project will not alter the Lincolnshire Historic District's setting as none of the activities associated with the project occur within the district, only adjacent to it. The traffic signals and signage located at the intersection of Washington Avenue and US 41 will be replaced in-kind with modern materials of approximately the same height. Replacement in-kind of modern materials will not affect the district's setting as a form of these utilities has existed at the intersection for over 50 years. Additionally, a Boulevard Left intersection will result in the construction of two U-turns and the addition of traffic signals at each U-turn, eliminating the left-turn lanes for northbound and southbound lanes of US 41, also near, but not within the historic district.

Per 36 CFR 800.5(a)(2)(v), the undertaking will not result in the "Introduction of visual, atmospheric, or audible elements that diminish the integrity of the property's significant

historic features." The previously mentioned project activities are all located outside of the historic district. Work associated with the alteration of the intersection of Washington Avenue and US 41 will be minimally visible from the historic district, as the work will occur at or near surface grade or will involve the replacement of existing more visible items, such as traffic signals and signage. The traffic signals and signage will be replaced in-kind with modern materials of approximately the same height in approximately the same location. New traffic signals will be placed at each median U-turn and will be suspended from strain poles located within the grassed ROW between the edge of pavement and the ROW fence. However, the work will not alter the district's ability to convey its significance.

Per 36 CFR 800.5(a)2(vi), the undertaking will not cause the "Neglect of a property which causes its deterioration..." The project will have no effect that will result in neglect.

Per 36 CFR 800.5(a)2(vii), the undertaking will not cause the "Transfer, lease, or sale of property out of Federal ownership or control..." There are no federally owned properties within the proposed project area.

Akin Park Historic District (IHSSI No. 163-196-430[01-213]) – According to 36 CFR 800.5(a)(1) the criteria of adverse effect do not apply.

Per 36 CFR 800.5(a)(2)(i), the undertaking will not result in the "Physical destruction of or damage to all or part of the property." None of the resources within the proposed boundary for the Akin Park Historic District will be damaged. No permanent or temporary ROW will be acquired from the proposed historic district boundary.

Per 36 CFR 800.5(a)2(ii), the undertaking will not cause "Alteration of a property, including restoration, rehabilitation, repair, maintenance, stabilization, hazardous material remediation and provision of handicapped access, that is not consistent with the Secretary's Standards for the Treatment of Historic Properties and/or other applicable guidelines."

Per 36 CFR 800.5(a)2(iii), the undertaking will not result in the "Removal of the property from its historic location."

Per 36 CFR 800.5(a)2(iv), the undertaking will not result in a "Change of the character of the property's uses or of physical features within the property setting that contribute to the historic significance" of the property. The proposed project will not alter the Akin Park Historic District's setting as none of the activities associated with the project occur within the district. The traffic signals and signage located at the intersection of Washington Avenue and US 41 will be replaced in-kind with modern materials of approximately the same height. Replacement in-kind of modern materials will not affect the district's setting as a form of these utilities has existed at the intersection for over 50 years. Additionally, a Boulevard Left intersection will result in the construction of two U-turns and the addition of traffic signals at each U-turn, eliminating the left-turn lanes for northbound and southbound lanes of US 41, also near, but not within the historic district.

Per 36 CFR 800.5(a)(2)(v), the undertaking will not result in the "Introduction of visual, atmospheric, or audible elements that diminish the integrity of the property's significant historic features." The previously mentioned project activities are all located outside of the historic district. Work associated with the alteration of the intersection of Washington Avenue and US 41 will be minimally visible from the historic district, as the work will occur at or near surface grade or will involve the replacement of existing more visible items, such as traffic signals and signage. The traffic signals and signage will be replaced in-kind with modern materials of approximately the same height in approximately the same location. New traffic signals will be placed at each median U-turn and will be suspended from strain poles located within the grassed ROW between the edge of pavement and the ROW fence. However, the work will not alter the district's ability to convey its significance.

Per 36 CFR 800.5(a)2(vi), the undertaking will not cause the "Neglect of a property which causes its deterioration..." The project will have no effect that will result in neglect.

Per 36 CFR 800.5(a)2(vii), the undertaking will not cause the "Transfer, lease, or sale of property out of Federal ownership or control..." There are no federally owned properties within the proposed project area.

Conclusions:

In accordance with Section 106 of the National Historic Preservation Act of 1966, as amended (16 .S.C. 470f), the project historians examined this project and assessed its potential to adversely affect historic properties in the APE. As noted above, historians believe that this project would have no adverse effect on the Lincolnshire Historic District or the Akin Park Historic District. The overall historic integrity of the districts will remain. The Akin Park Historic District will still be able to maintain its association with architecture and community planning and development in Evansville during the early to mid-twentieth century. The Lincolnshire Historic District will maintain its ability to convey its significance relating to architecture, commerce, and community planning and development. Work associated with the project will be located at or near surface grade or will involve the replacement of existing more visible items, such as traffic signals, but will not alter either districts ability to convey their previously mentioned areas of significance. Therefore, it is the professional opinion of the historians that the appropriate overall finding for this undertaking is "No Adverse Effect."

APPENDIX A: MAPS

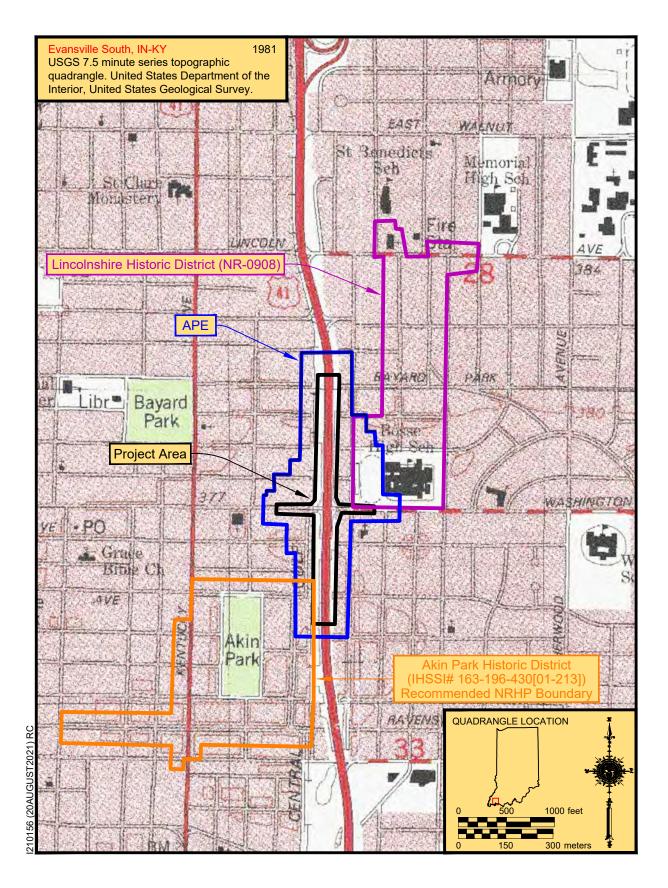


Figure 1. Topographic map showing the location of the proposed project, APE, and survey sites.

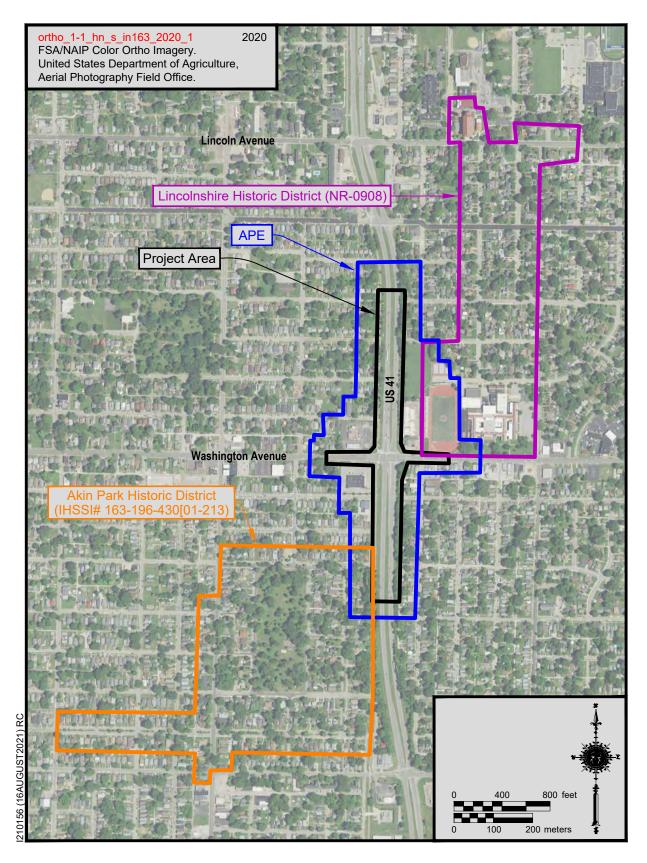


Figure 2. Aerial map showing the location of the proposed project, APE, and survey sites.

APPENDIX B. PHOTOS

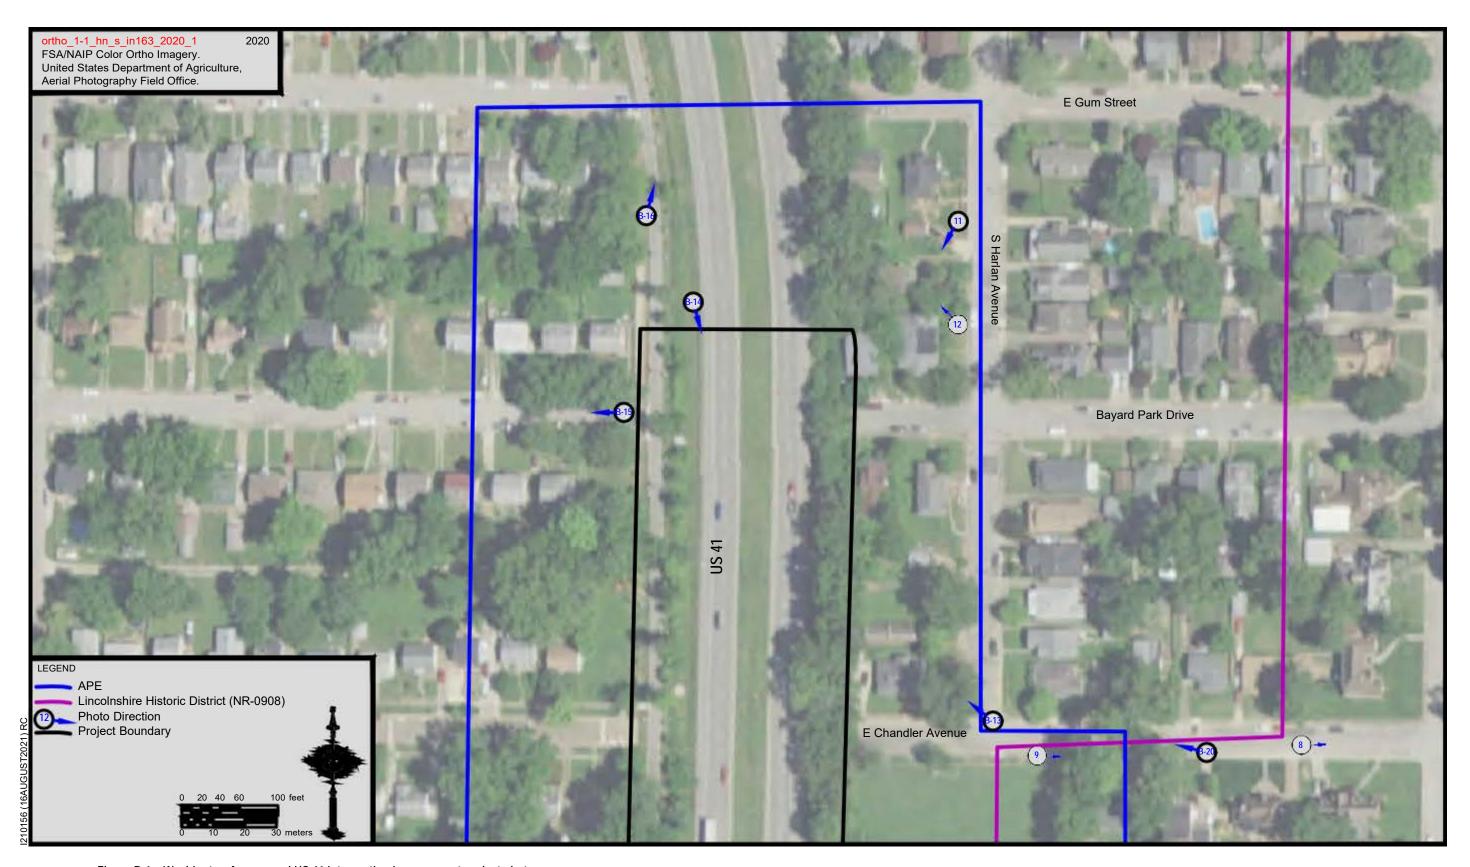


Figure B-1a. Washington Avenue and US 41 intersection improvement project photomap.

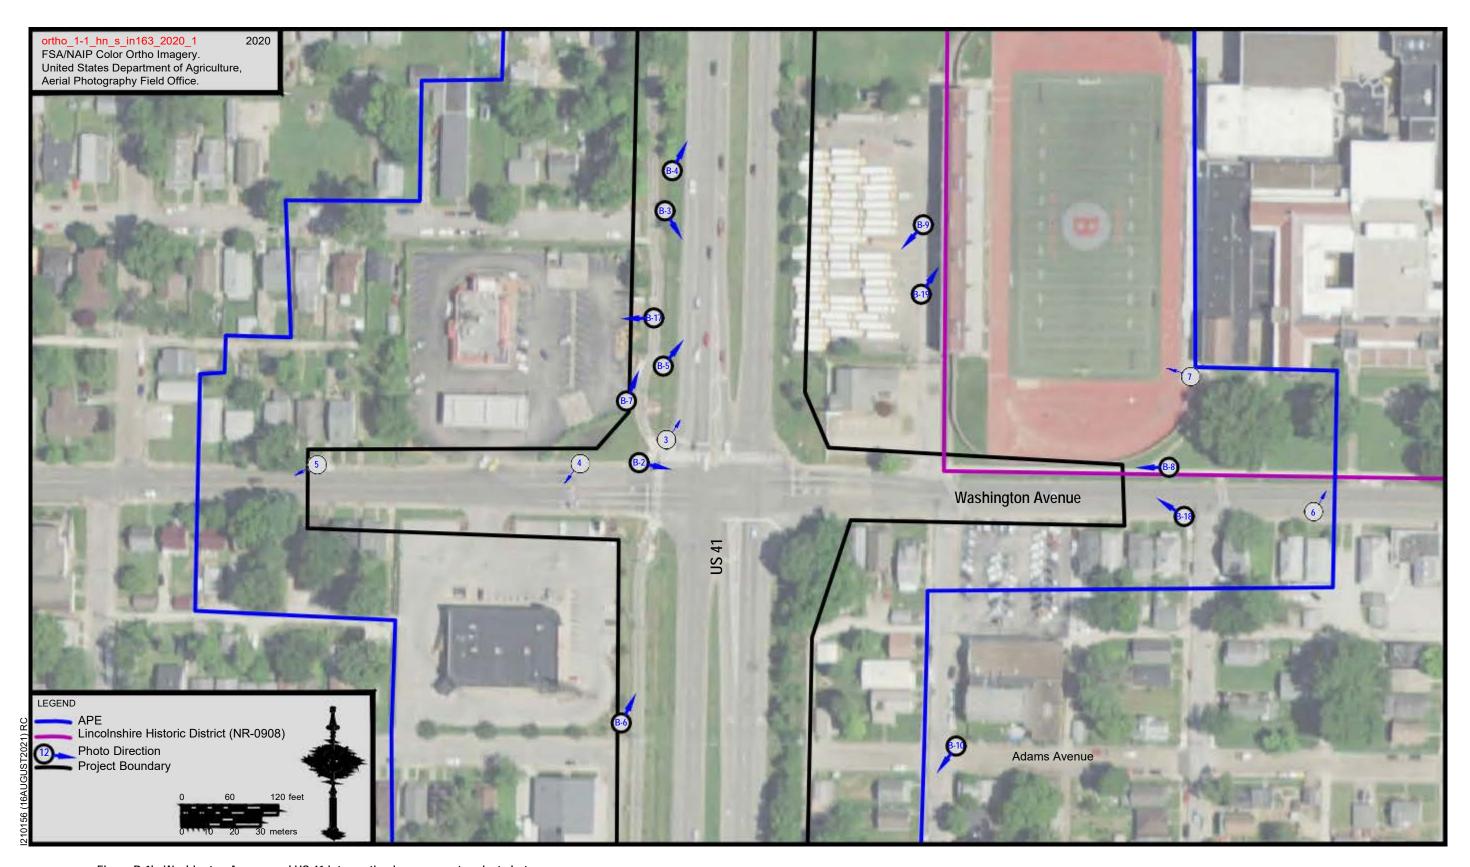


Figure B-1b. Washington Avenue and US 41 intersection improvement project photomap.

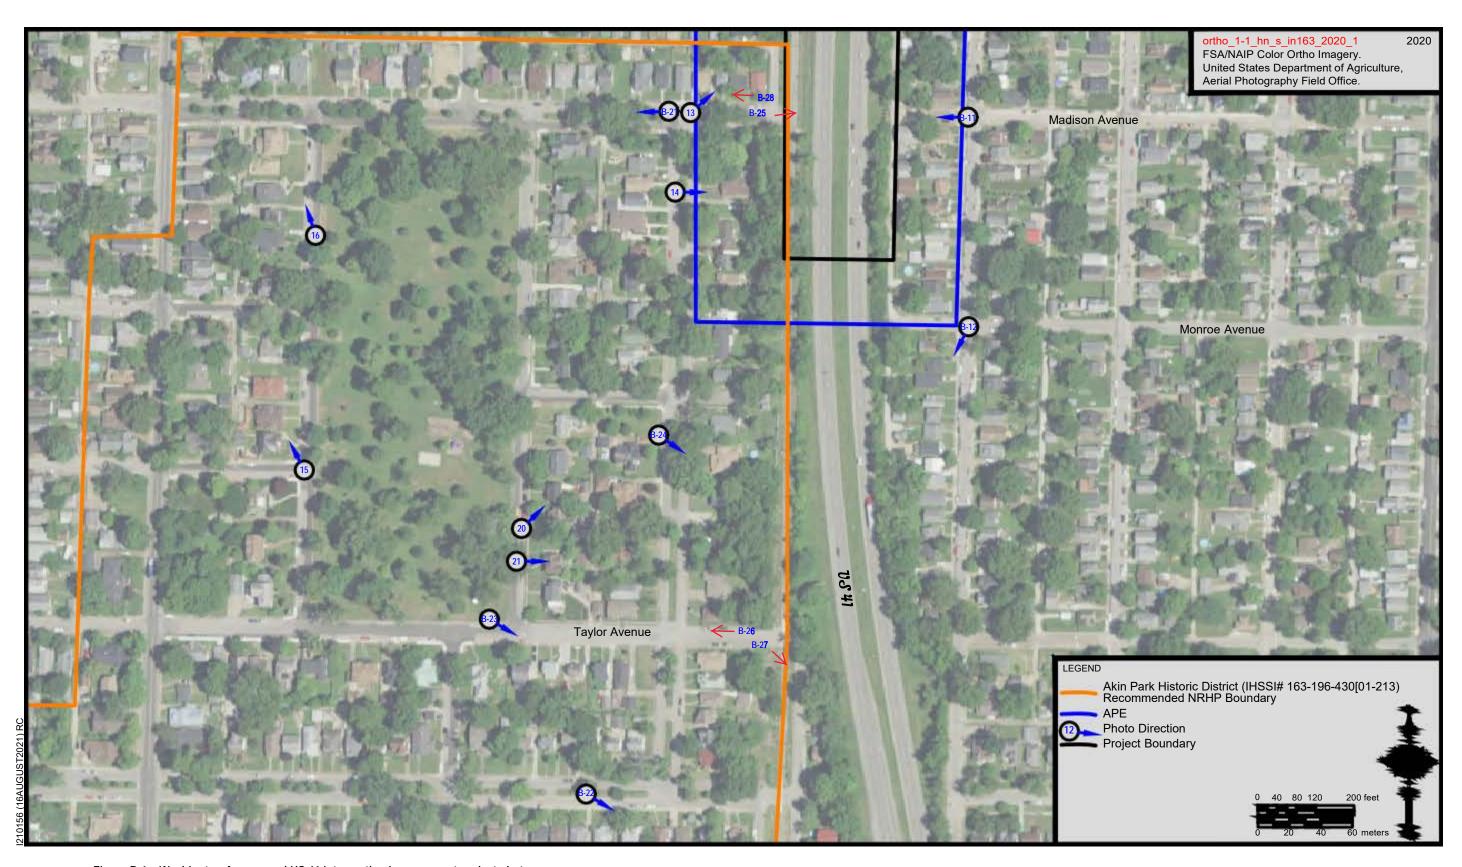


Figure B-1c. Washington Avenue and US 41 intersection improvement project photomap.



Figure B-1d. Washington Avenue and US 41 intersection improvement project photomap.



Figure 1. Overview of project area at the intersection of Washington Avenue and US 41, looking northeast



Figure 2. Benjamin Bosse High School (IHSSI No. 163-196-41045), "Outstanding," located within the Lincolnshire Historic District (NR-0908), façade (south) elevation, facing northeast.



Figure 3. Overview of the interior of Enlow Field (IHSSI No. 163-196-41044), "Outstanding," located within the Lincolnshire Historic District (NR-0908), facing northwest.



Figure 4. Overview of the Akin Park Historic District at the intersection of Jackson Street and Park Drive, facing northwest.



Figure 5. Overview of the Akin Park Historic District along Park Drive, facing northwest.



Figure 6. Overview of the Akin Park Historic District at the intersection of South Bedford Avenue and Ravenswood Drive, facing northwest.



Figure 7. Overview of the Akin Park Historic District at the intersection of South Bedford Avenue and Ravenswood Drive, facing southwest.



Figure 8. Overview of the Akin Park Historic District at the intersection of South Bedford Avenue and Ravenswood Drive, facing southeast, showing the boulevard.



Figure 9. Façade (west) and south elevation of the Irma Schmidt House (IHSSI No. 163-196-430[168]; "Notable," designed by Alfred Neucks, facing northeast, outside of the APE.



Figure 10. Façade (west) elevation of the Dr. C. Gardner Johnson House (IHSSI No. 163-196-430[166]; "Notable"), designed by Walter K. Stuart, facing east, outside of the APE.



Figure 11. Overview of project area at the intersection of US 41 and Washington Avenue, facing southeast.



Figure 12. Overview of APE along the west side of US 41, facing southeast.



Figure 13. View of project area toward the Lincolnshire Historic District (NR-0908) with Enlow Field (IHSSI No. 163- 196-41044), "Outstanding," in the foreground, facing northeast.



Figure 14. Overview of APE along US 41, facing northeast.



Figure 15. Overview of APE along Washington Avenue, facing west.



Figure 16. Overview of project area from the Enlow Field parking lot, facing southwest.



Figure 17. Overview of the project area along US 41, facing southeast near the Akin Park Historic District.



Figure 18. Exterior of Enlow Field (IHSSI No. 163-196-41044), part of the Lincolnshire Historic District (NR-0908) along Washington Avenue, facing northwest.



Figure 19. Exterior of Enlow Field (IHSSI No. 163-196-41044), part of the Lincolnshire Historic District (NR-0908) from the parking lot, facing northeast.



Figure 20. Overview of the Akin Park Historic District (IHSSI No. 163-196-430[01-213]) at the intersection of Akin Drive and Madison Avenue, facing west.



Figure 21. Overview of the Akin Park Historic District (IHSSI No. 163-196-430[01-213]) along Ravenswood Drive, facing southeast.



Figure 22. Overview of Akin Park Historic District (IHSSI No. 163-196-430[01-213]) along Taylor Avenue, facing southeast.

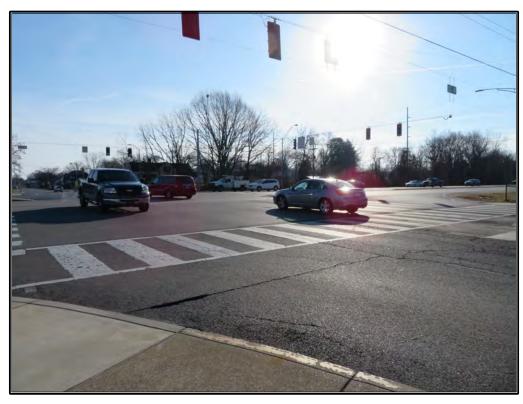


Figure B-2. Overview of project area at the intersection of US 41 and Washington Avenue, facing southeast.



Figure B-3. Overview of APE along the west side of US 41, facing southeast.



Figure B-4. Overview of APE along the west side of US 41, facing northeast.



Figure B-5. View of project area toward the Lincolnshire Historic District (NR-0908) with Enlow Field (IHSSI No. 163-196-41044), "Outstanding," in the foreground, facing northeast.



Figure B-6. Overview of APE along US 41, facing northeast.

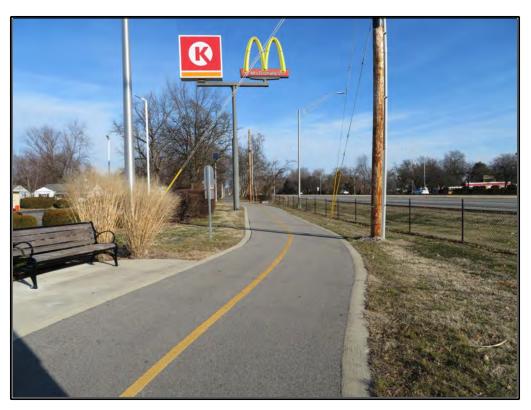


Figure B-7. Overview of project area along west side of US 41, facing northeast.



Figure B-8. Overview of APE along Washington Avenue, facing west.



Figure B-9. Overview of project area from the Enlow Field parking lot, facing southwest.



Figure B-10. Overview of the APE at the intersection of Adams Avenue and South Harlan Avenue, facing southwest.



Figure B-11. Overview of the project area from the intersection of South Harlan Avenue and Madison Avenue, facing west.



Figure B-12. Overview of resources located just outside of the APE at the intersection of South Harlan Avenue and Monroe Avenue, facing southwest.



Figure B-13. Overview of the APE at the intersection of South Harlan Avenue and East Chandler Avenue, facing northwest.



Figure B-14. Overview of the project area along US 41, facing southeast.



Figure B-15. Overview of the APE along Bayard Park Drive, facing west.



Figure B-16. Overview of the APE along US 41, facing northeast.



Figure B-17. Example of a property constructed during the early twenty-first century at the intersection of US 41 and Washington Avenue, facing northwest.



Figure B-18. Exterior of Enlow Field (IHSSI No. 163-196-41044), part of the Lincolnshire Historic District (NR-0908) along Washington Avenue, facing northwest.



Figure B-19. Exterior of Enlow Field (IHSSI No. 163-196-41044), part of the Lincolnshire Historic District (NR-0908) from the parking lot, facing northeast.



Figure B-20. Overview of a portion of the Lincolnshire Historic District (NR-0908) located within and just outside of the APE along East Powell Avenue, facing northwest.



Figure B-21. Overview of the Akin Park Historic District (IHSSI No. 163-196-430[01-213]) at the intersection of Akin Drive and Madison Avenue, facing west.



Figure B-22. Overview of the Akin Park Historic District (IHSSI No. 163-196-430[01-213]) along Ravenswood Drive, facing southeast.



Figure B-23. Overview of Akin Park Historic District (IHSSI No. 163-196-430[01-213]) along Taylor Avenue, facing southeast.



Figure B-24. Overview of Akin Park Historic District (IHSSI No. 163-196-430[01-213]) along Akin Drive, facing southeast.



Figure B-25. Overview of project area at the eastern end of Madison Avenue near the Akin Park Historic District looking toward the project area along US 41, facing east.



Figure B-26. Overview of the Akin Park Historic District **on Taylor Avenue** near the **eastern** edge of the project area along US 41, facing west.



Figure B-27. Overview of the project area from **Taylor** Avenue near the Akin Park Historic District, facing southeast.

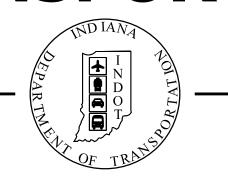


Figure B-28. Overview of the Akin Park Historic District from the eastern end of **Madison** Avenue near the project area along US 41, facing southwest.

APPENDIXC: PLANS

PROJECT	DESIGNATION
2000186	2000186
CONTRACT	
D 42076	

INDIANA DEPARTMENT OF TRANSPORTATION



TRAFFIC DATA	A	U.S. 41	WASHINGTON AVE.
A.A.D.T.	2023)	30,200 V.P.D.	12,900 V.P.D.
A.A.D.T.	2044)	37,100 V.P.D.	13,100 V.P.D.
D.H.V. (7	2044)	2,970 V.P.H.	1,180 V.P.H.
DIRECTIONAL DISTRIBUTION		59.00%	57.00%
TRUCKS		11.00% OF AADT	2.00% OF AADT
		1.00% OF DHV	1.00% OF DHV
DESIGN DATA			
DESIGN DATA		U.S. 41	WASHINGTON AVE.
DESIGN DATA DESIGN SPEED		U.S. 41	WASHINGTON AVE.
DESIGN SPEED		40 MPH	30 MPH
DESIGN SPEED PROJECT DESIGN CRITERIA		40 MPH 3R NON-FREEWAY	30 MPH 3R NON-FREEWAY
DESIGN SPEED PROJECT DESIGN CRITERIA FUNCTIONAL CLASSIFICATION		40 MPH 3R NON-FREEWAY PRINCIPAL ARTERIAL	30 MPH 3R NON-FREEWAY MINOR ARTERIAL

ROAD PLANS US 41 AND WASHINGTON AVENUE INTERSECTION IMPROVEMENT

ROUTE: U.S. 41 FROM: RP 2+82 TO: RP 2+89

PROJECT NO. 2000186 P.E.


2000186 CONST.

KIN PROJECT INFORMATION		
DESIGNATION	PROJECT DESCRIPTION	
1902709	PEDESTRIAN BRIDGE OVER US 41	LEAD DES
2000186	US 41 AND WASHINGTON AVENUE INTERSECTION IMPROVEMENT	

STAGE 2 REVIEW PLANS

STAGE APRIL 1, 2022

BEGIN PROJECT
PROJECT NO. 2000186
P.O.C. STA. 273+00.00
LINE "B"

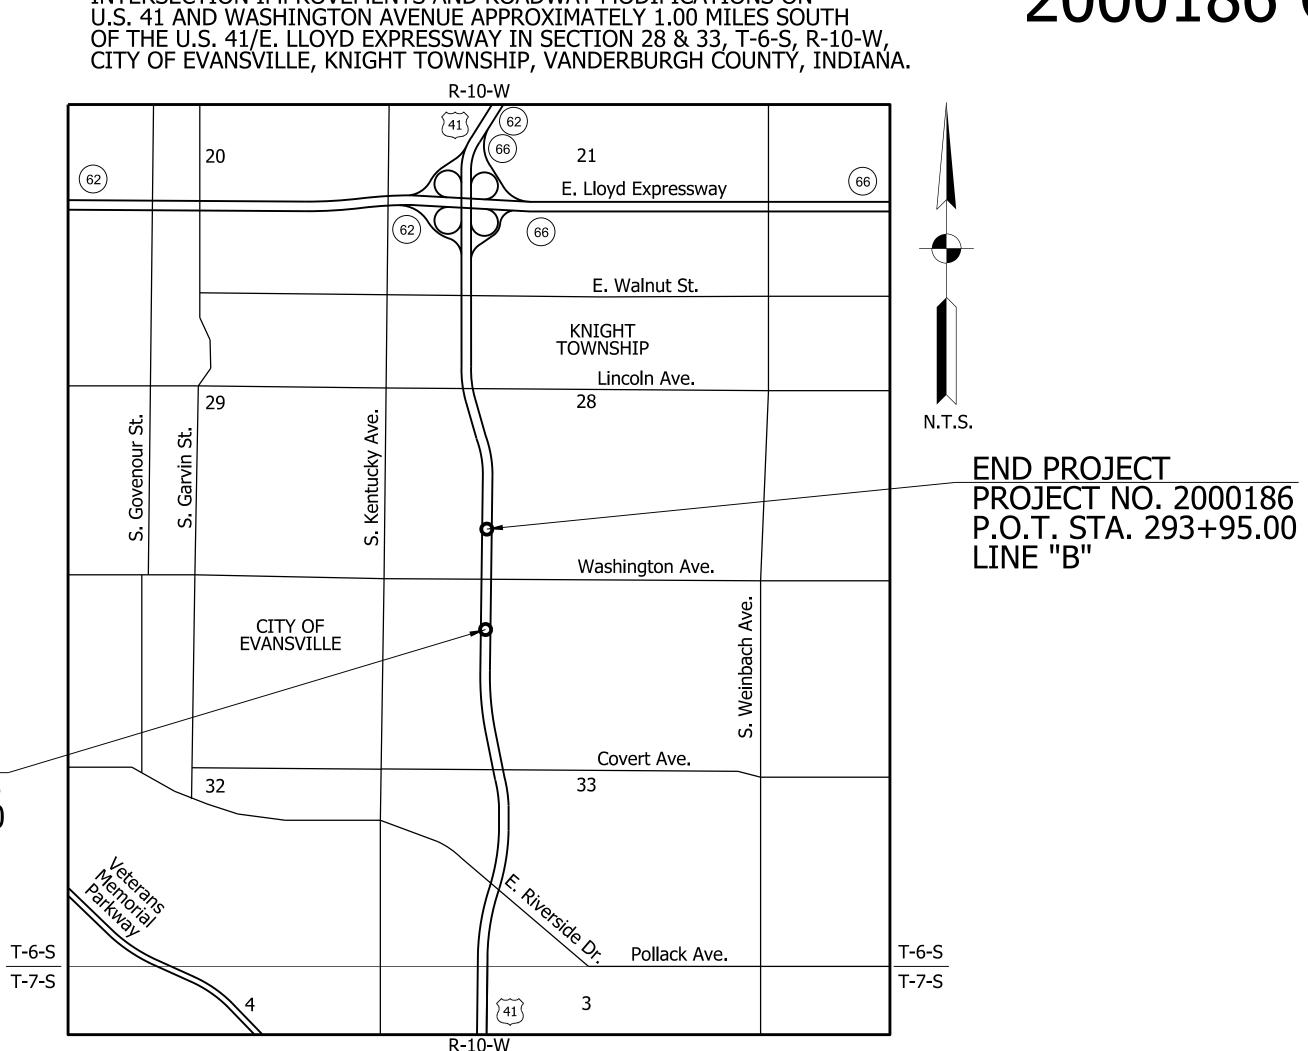

LOCATION MAP

LOCATION MAP

CITY OF EVANSVILLE, KNIGHT TOWNSHIP,
VANDERBURGH COUNTY

GROSS LENGTH:

NET LENGTH:

INDIANA DEPARTMENT OF TRANSPORTATION STANDARD SPECIFICATIONS DATED 2022 TO BE USED WITH THESE PLANS

PROJECT LOCATION SHOWN BY -

LATITUDE: 37°57'46"N LONGITUDE: 87°32'34"W

THE HNTB COMPANIES
INFRASTRUCTURE SOLUTIONS
111 MONUMENT CIRCLE
SUITE 1200
INDIANAPOLIS, IN 46204-5178



PLANS PREPARED BY:	HNTB INDIANA, INC.	(317) 636-4682 PHONE NUMBER
CERTIFIED BY:		DATE
APPROVED FOR LETTING:		
	INDIANA DEPARTMENT OF TRANSPORTATION	DATE

	DESIGNATION		
	2	00018	36
SURVEY BOOK SHEETS		S	
ELECTRONIC	1	of	45
CONTRACT	PROJECT		CT
B-42876 2000186			36

0.397 MI.

0.397 MI.

UTILITIES

COMMUNICATIONS:

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NOTE TO REVIEWER

UTILITY CONTACTS ARE PRELIMINARY AND WILL BE FINALIZED FOR FUTURE SUBMITTALS.



REVISIONS

SHEET NO.	DATE	REVISED

GENERAL NOTES

	The final cross sections of the grading contract will be the original cross sections of the paving contract. However, partial or complete cross sections shall be taken if necessary to determine the actual excavation quantities.
	The paper relocation lines will be cross sectioned by the engineer before construction.
	Existing asphalt pavement located outside the constuction limits shall be removed as directed.
	Existing pccp sidewalks and curbs shall be removed from project right of way limits unless otherwise noted and shall be paid for under clearing right of way.
жж	All earth shoulders, median areas, cut and fill slopes shall be plain or mulched seeded except where sodding is specified.
ЖЖ	All existing storm drainage pipes, inlets, and manholes shall remain unless otherwise noted.
	All limited access right of way is to be fenced with black vinyl coated chain link type fence (b.v.c.l.t.f.) unless otherwise noted.
	All existing right of way fence shall be removed unless otherwise noted.
ЖЖ	All disturbed areas shall be seeded with seed mixture "R" unless otherwise noted.
жж	All slopes are to be repaired with a minimum amount of grading so as not to disturb existing vegetation more than necessary.
	All pipes that are to be removed which connect to existing sewers that are to remain in operation shall be sealed water tight.


XX Denotes General Notes Required.

SHEET INDEX

SHEET NO.		DESIGNATION				
1	TITLE SHEET					
2	INDEX AND GENERAL NOTES					
3-4	ROADWAY TYPICAL CROSS SECTIONS					
5-18	MAINTENANCE OF TRAFFIC					
19-22	ROADWAY PLAN LINE "B"					
23	ROADWAY PLAN LINE "C"					
24-27	CONSTRUCTION DETAILS					
28-30	INTERSECTION DETAILS					
31-36	PAVEMENT MARKING DETAIL	S				
37-38	SIGNING PLAN					
39-41	TRAFFIC SIGNALS					
42	APPROACH TABLE					
43	STRUCTURE DATA TABLE					
44-56	ROADWAY CROSS SECTIONS	LINE "R"				
		NOTE TO REVIEWER				
		CROSS SECTIONS NOT INCLUDED FOR LINE "C"				
		DUE TO THE ONLY WORK ALONG THIS				
		ALIGNMENT BEING SIGNING AND				
		PAVEMENT MARKINGS.				

ORAK CONSTRUCTION

				П	LIODIZONITAL COALE		DID OF FIL	
				TAIDTANIA	HORIZONTAL SCALE	BRIDGE FILE		
RECOMMENDED				INDIANA	1"=1'-0"	N/A		
FOR APPROVAL				DEPARTMENT OF TRANSPORTATION	VERTICAL SCALE	DE	ESIGNATIO	N
		DESIGN ENGINEER DATE			N/A	2000186		
DECICALED	NSX D	X DRAWN: CPH	DD AWAY	SURVEY BOOK		SHEETS	IN-01	
DESIGNED:			INDEX AND GENERAL NOTES	ELECTRONIC	2	of	45	
CUECKED.		IE CHECKED: NSX		CONTRACT		PROJECT		
CHECKED:	TNE		-	B-42876		2000186		

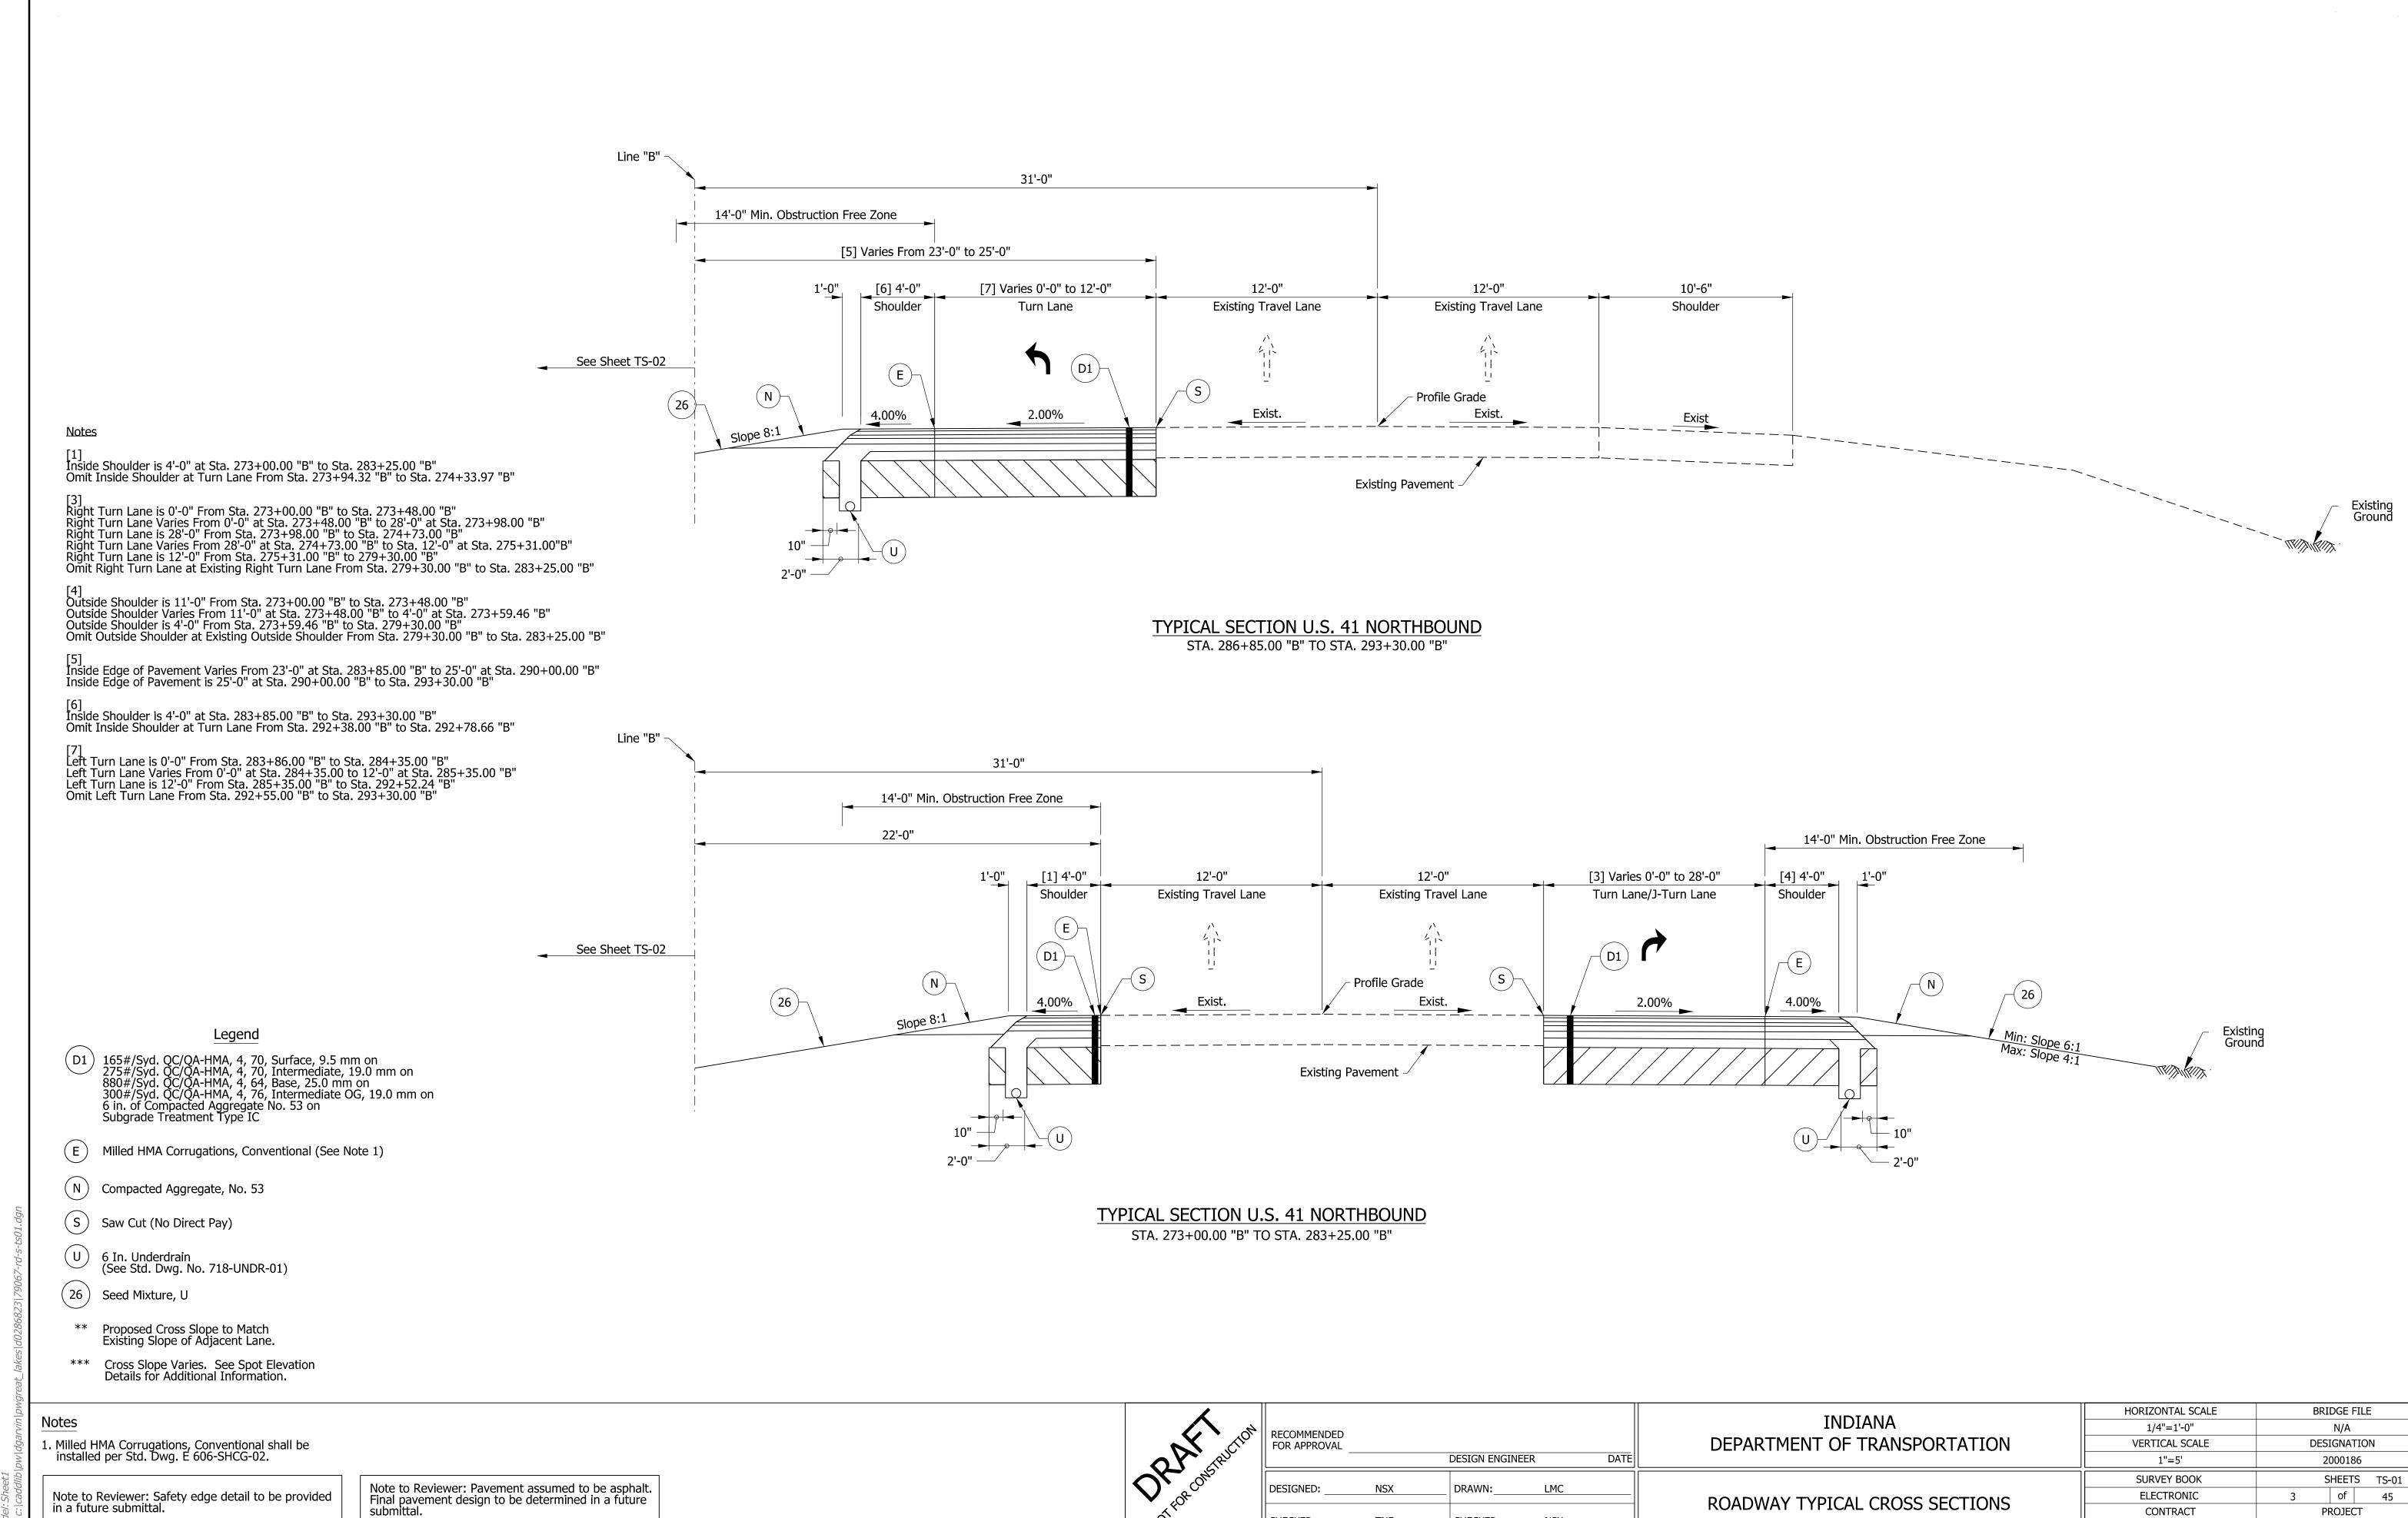


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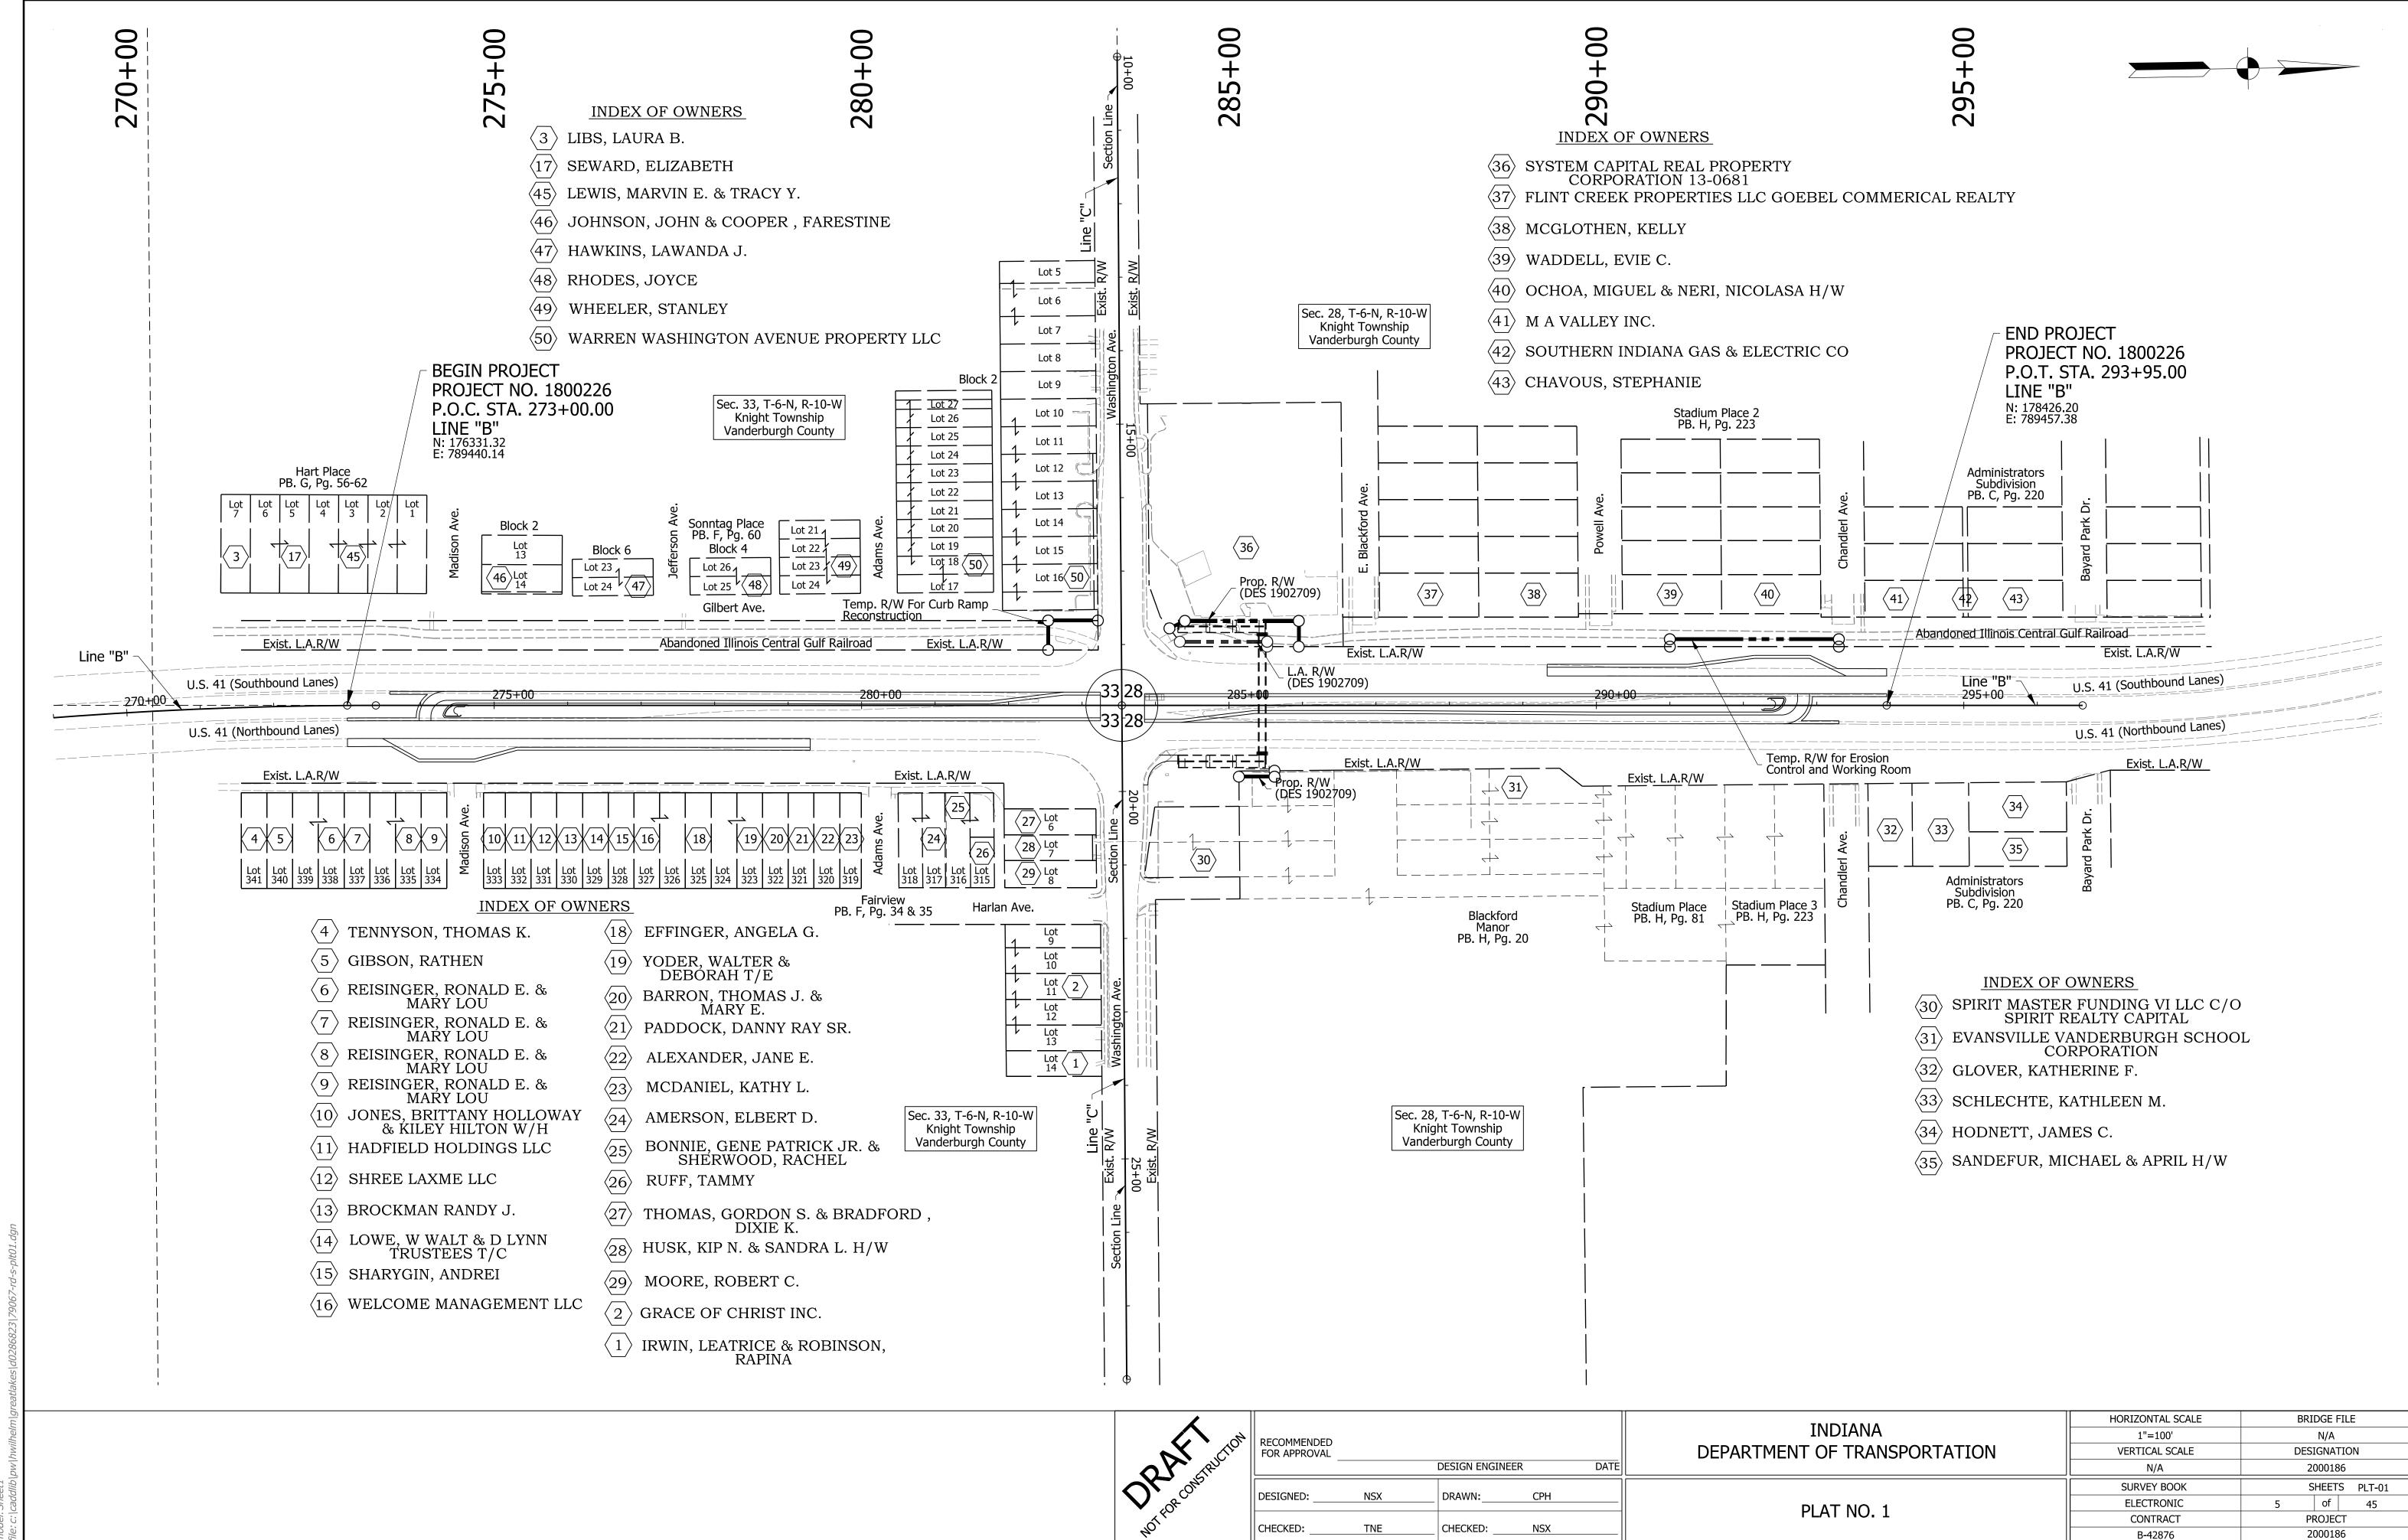
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CHECKED: _

2000186

B-42876



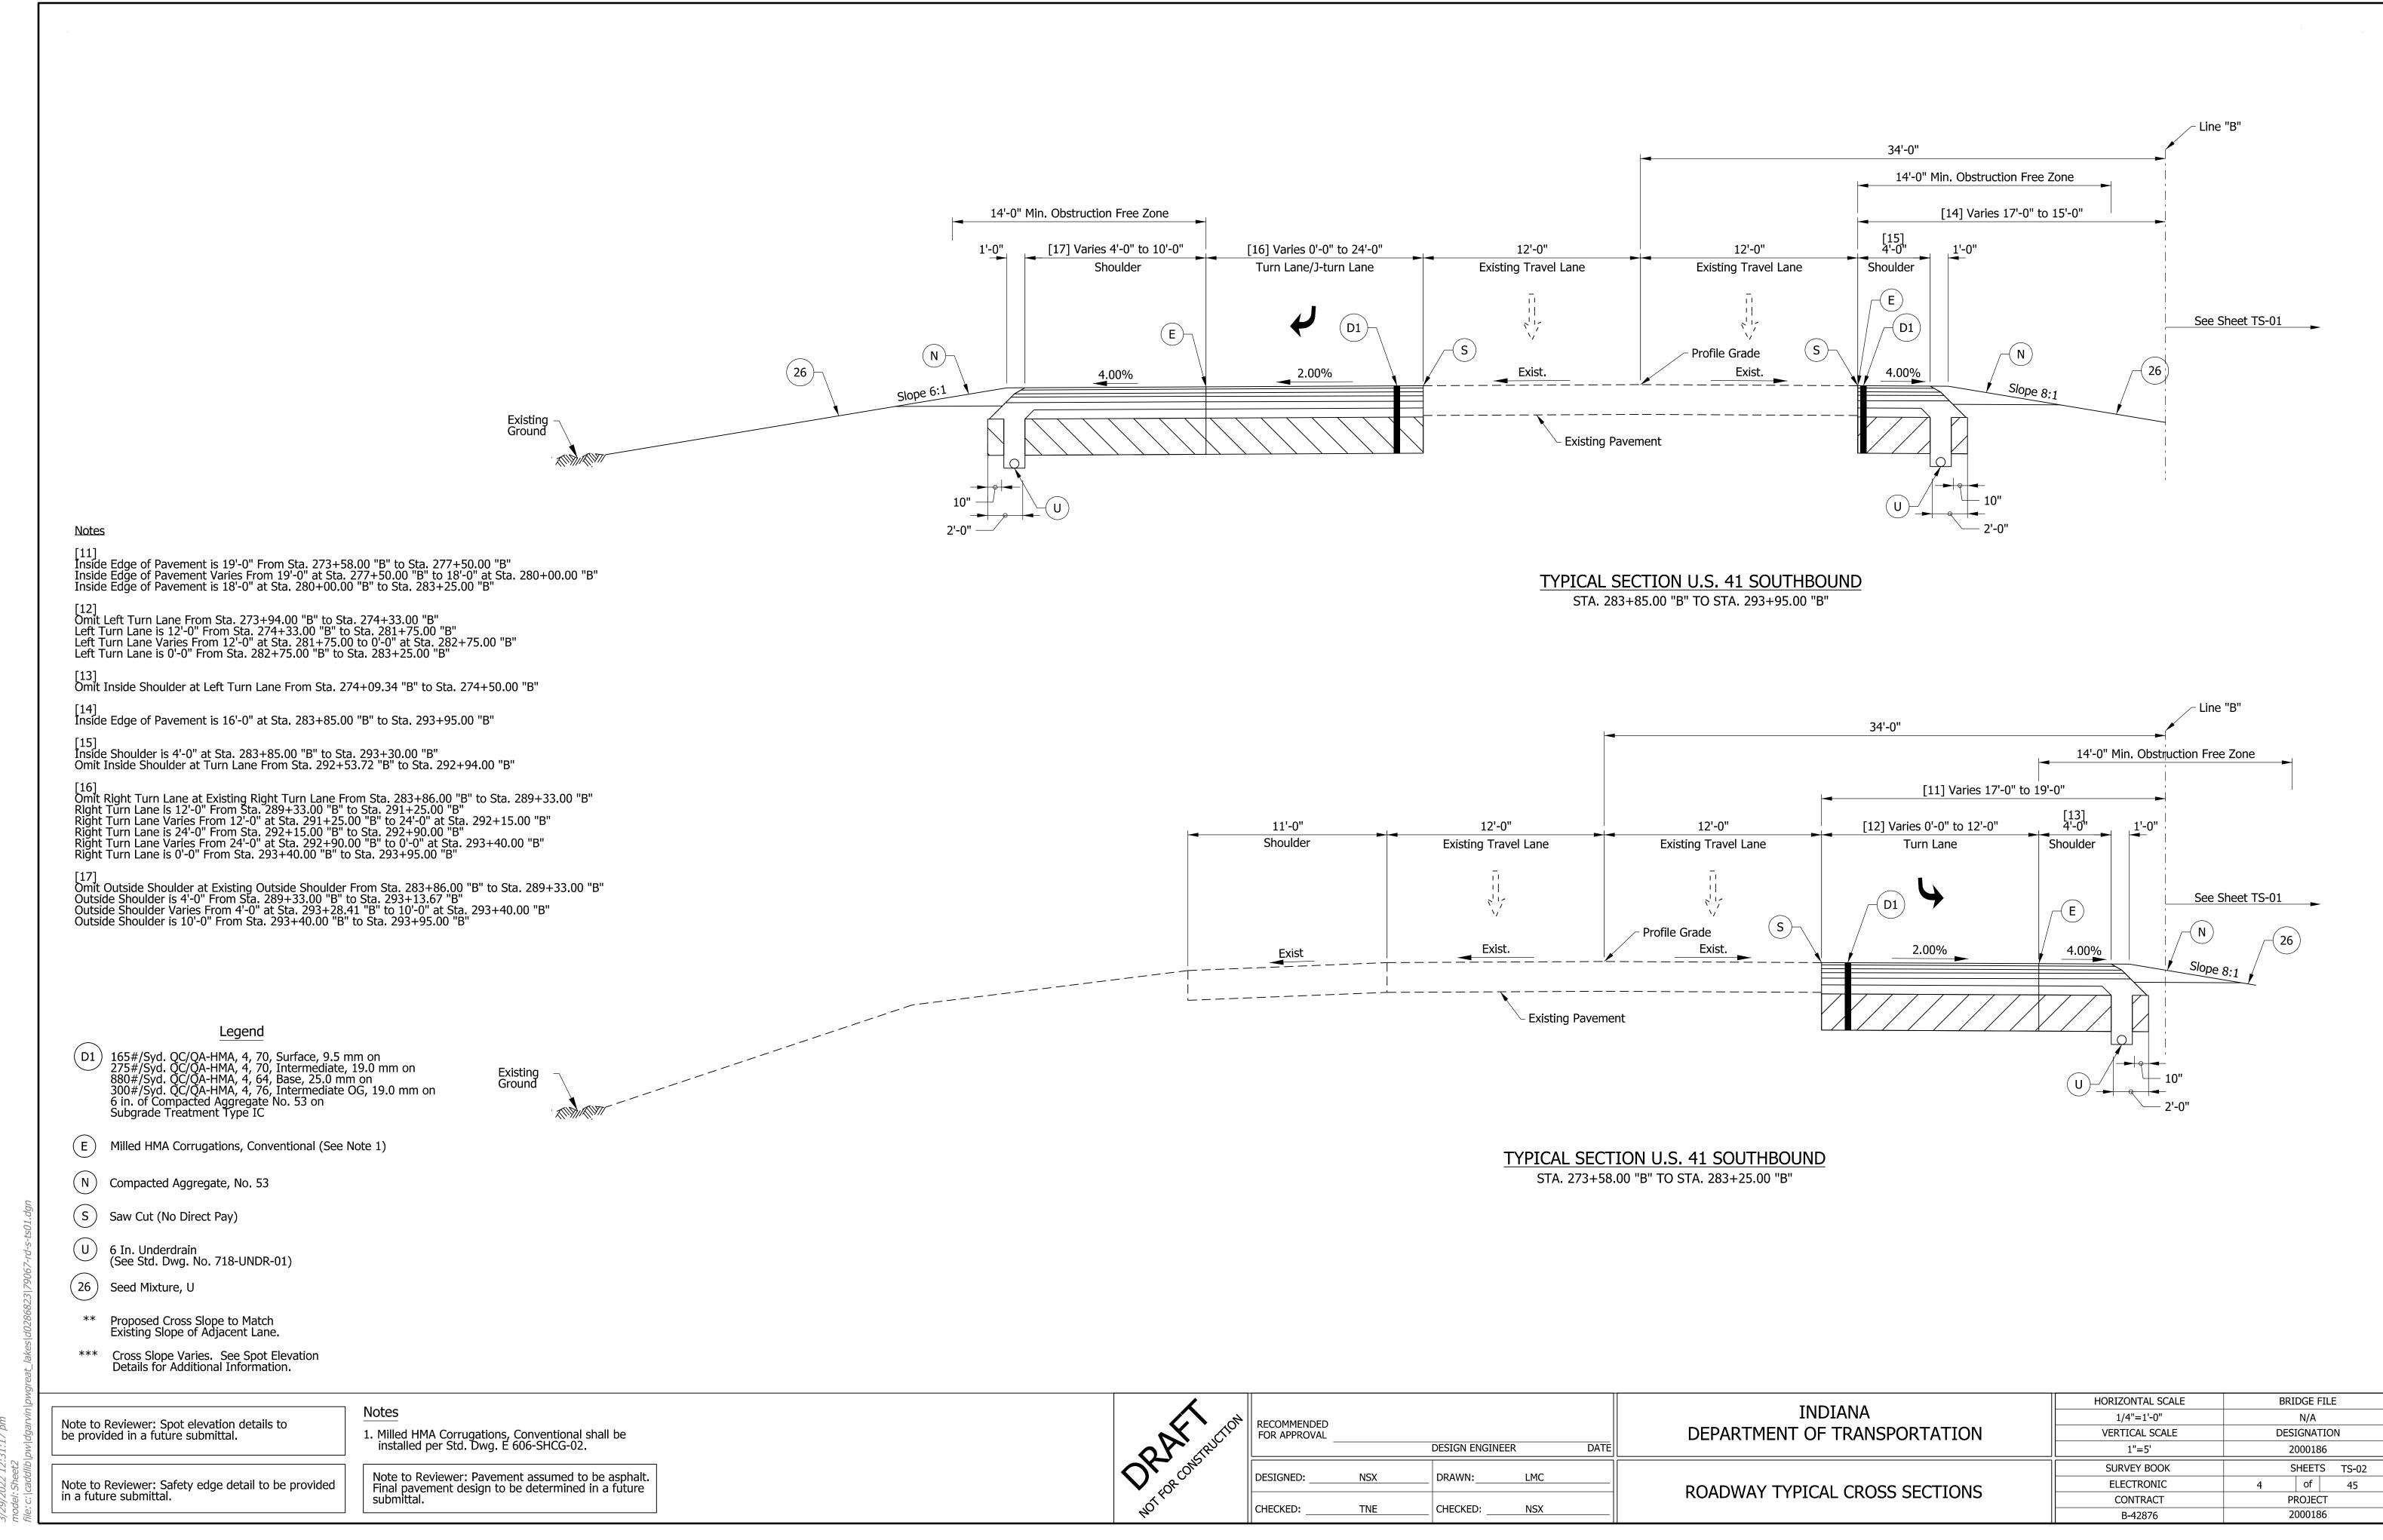


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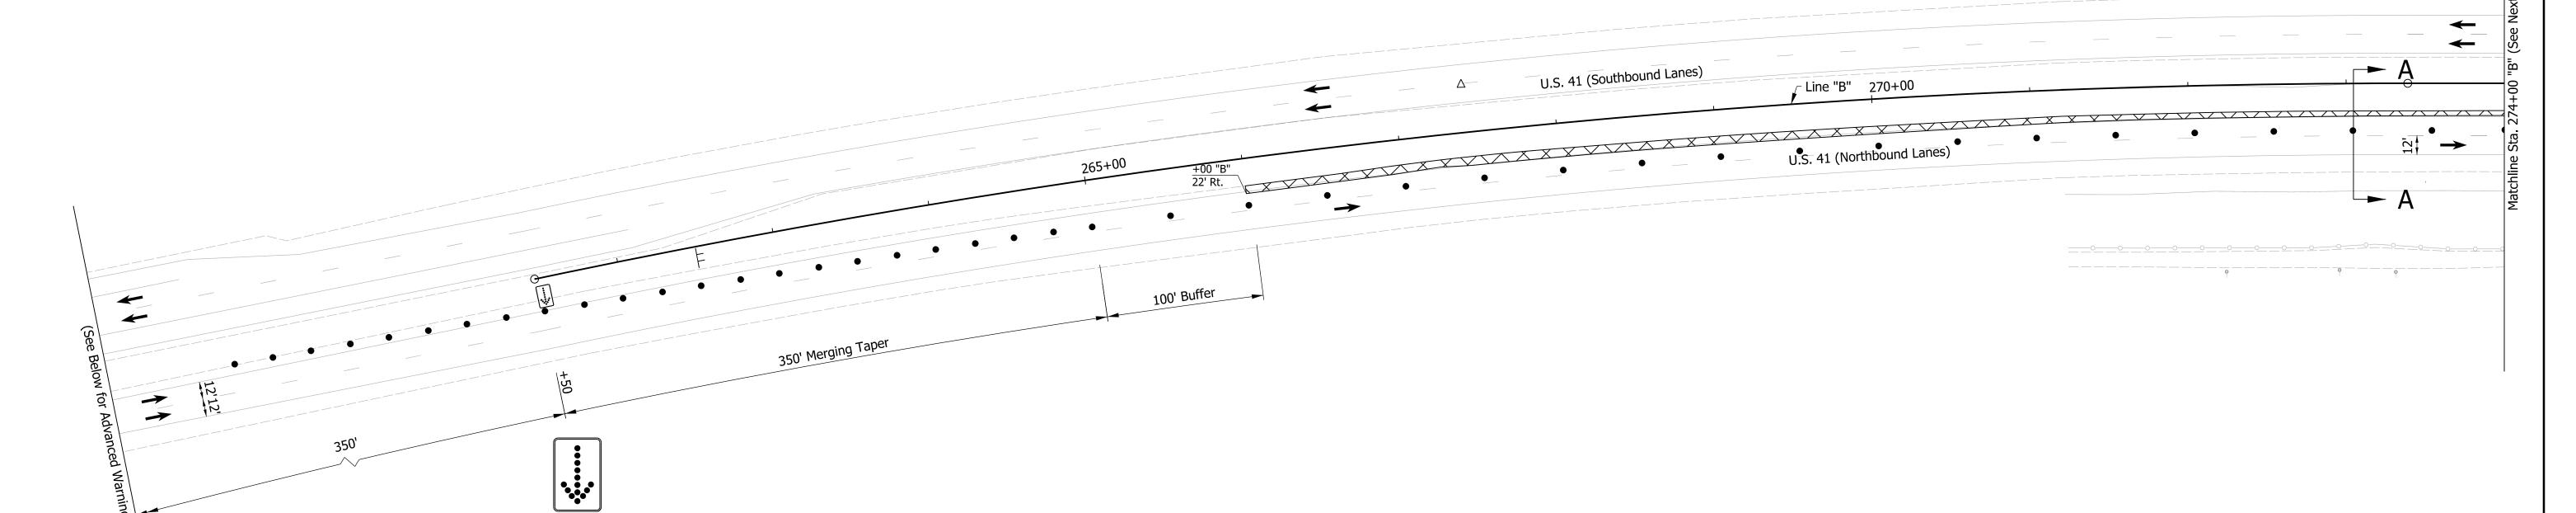
- 1. Install Advanced Warning Signs.
- 2. Place temporary Traffic Drums adjacent to US 41 workzones.
- 3. Construct the Northbound and Southbound Shoulder Strengthening along US 41.


Construction Design Speed: 40 MPH


Construction Clear Zone: 13'-0"

ary - Pha	ise 1
Amount	Unit
20	EACH
6	EACH
8	EACH
14	DAY
	20 6 8



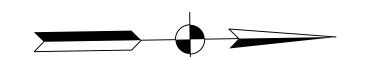

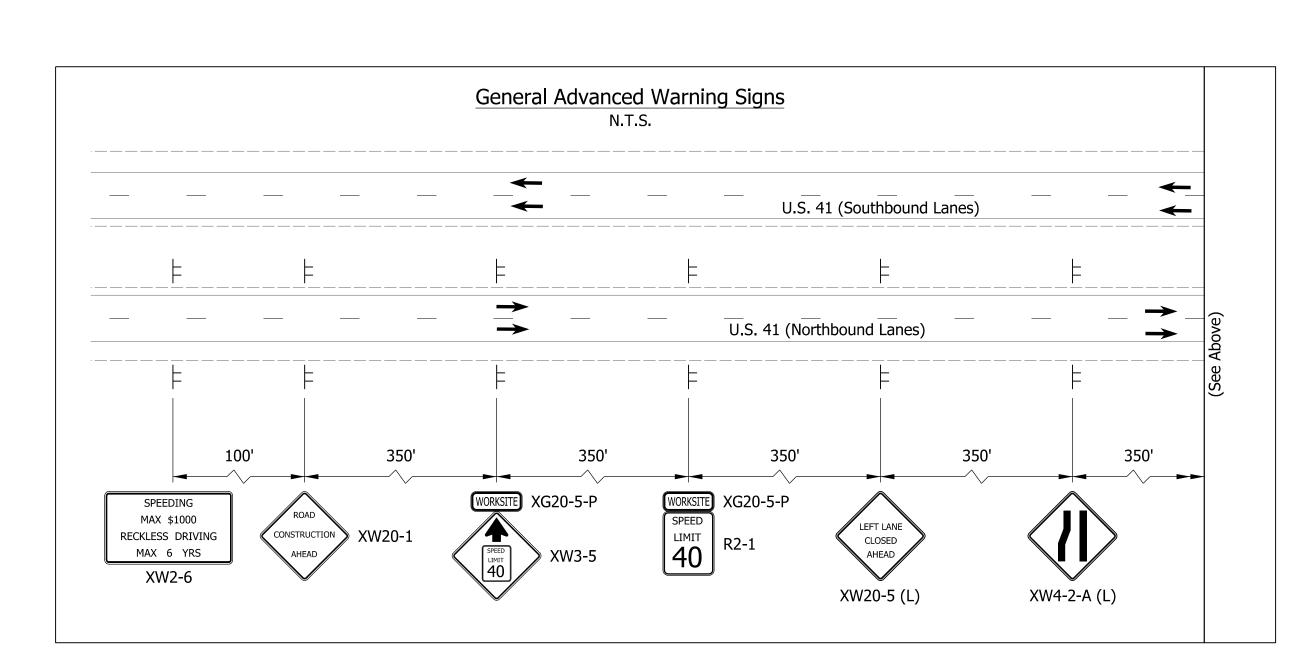

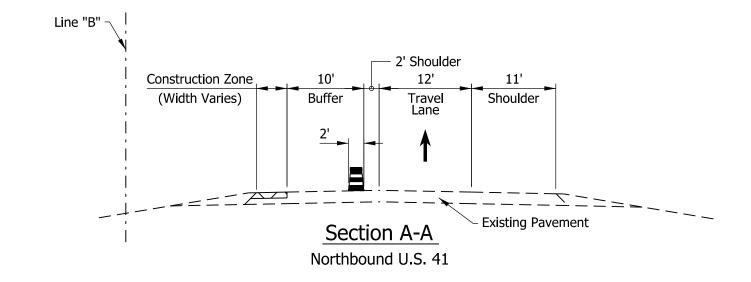

- Shoulder Strengthening to be completed by Single Lane Closure per SDD E 801-TCLC-11 Contractor shall maintain a 1' Minimum Shoulder at all times
- All Sign Spacing shall be 350' Minimum unless otherwise noted
 Traffic Drum Spacing along Tapers shall be at 25'
 Traffic Drum Spacing along Tangents shall be at 50'
 All temporary Pavement Markings shall be Removable

- Existing Transverse Rumble Strips to remain in place No changes to the Traffic Signal at US 41 and Washington Ave. Intersection

neim	<u>LEGENI</u>	2		
VINNI		Construction Zone	EAT	Energy Absorbing Terminal CZ, Type 2
ıdlaıı		Temporary Pavement	þ	Construction Sign
Cada	\rightarrow	Direction of Traffic	•	Traffic Drum
'''e: c:		Temporary Trafffic Barr	ier	Traine Drain

1 Temporary Pavement Markings, 6 In., Solid, White

2 Temporary Pavement Markings, 6 In., Solid, Yellow


5 Temporary Transverse Pavement Markings, 24 In., Solid, Stop Line


(6) Temporary Transverse Pavement Markings, 24 In., Solid, White Temporary Pavement Markings, 6 In., Broken, White 7 Temporary Pavement Message Marking, Lane Indication Arrow

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	A CONSTRUCTION FOR CONSTRUCTION
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DEPARTMEN					RECOMMENDED FOR APPROVAL
	DATE	GINEER	DESIGN ENG		
MAINTE		HDW	_ DRAWN:	NSX	DESIGNED:
		NSX	_ CHECKED: _	TNE	CHECKED:

TAIDTANIA	HORIZONTAL SCALE	BR	IDGE FILE
INDIANA	1"=50'		N/A
DEPARTMENT OF TRANSPORTATION	VERTICAL SCALE	DE:	SIGNATION
	N/A		2000186
MAINTENANCE OF TRAFFIC PHASE 1	SURVEY BOOK		SHEETS MOT-01
	ELECTRONIC	6	of 54
	CONTRACT	ŀ	PROJECT
	B-42876		2000186
	·		



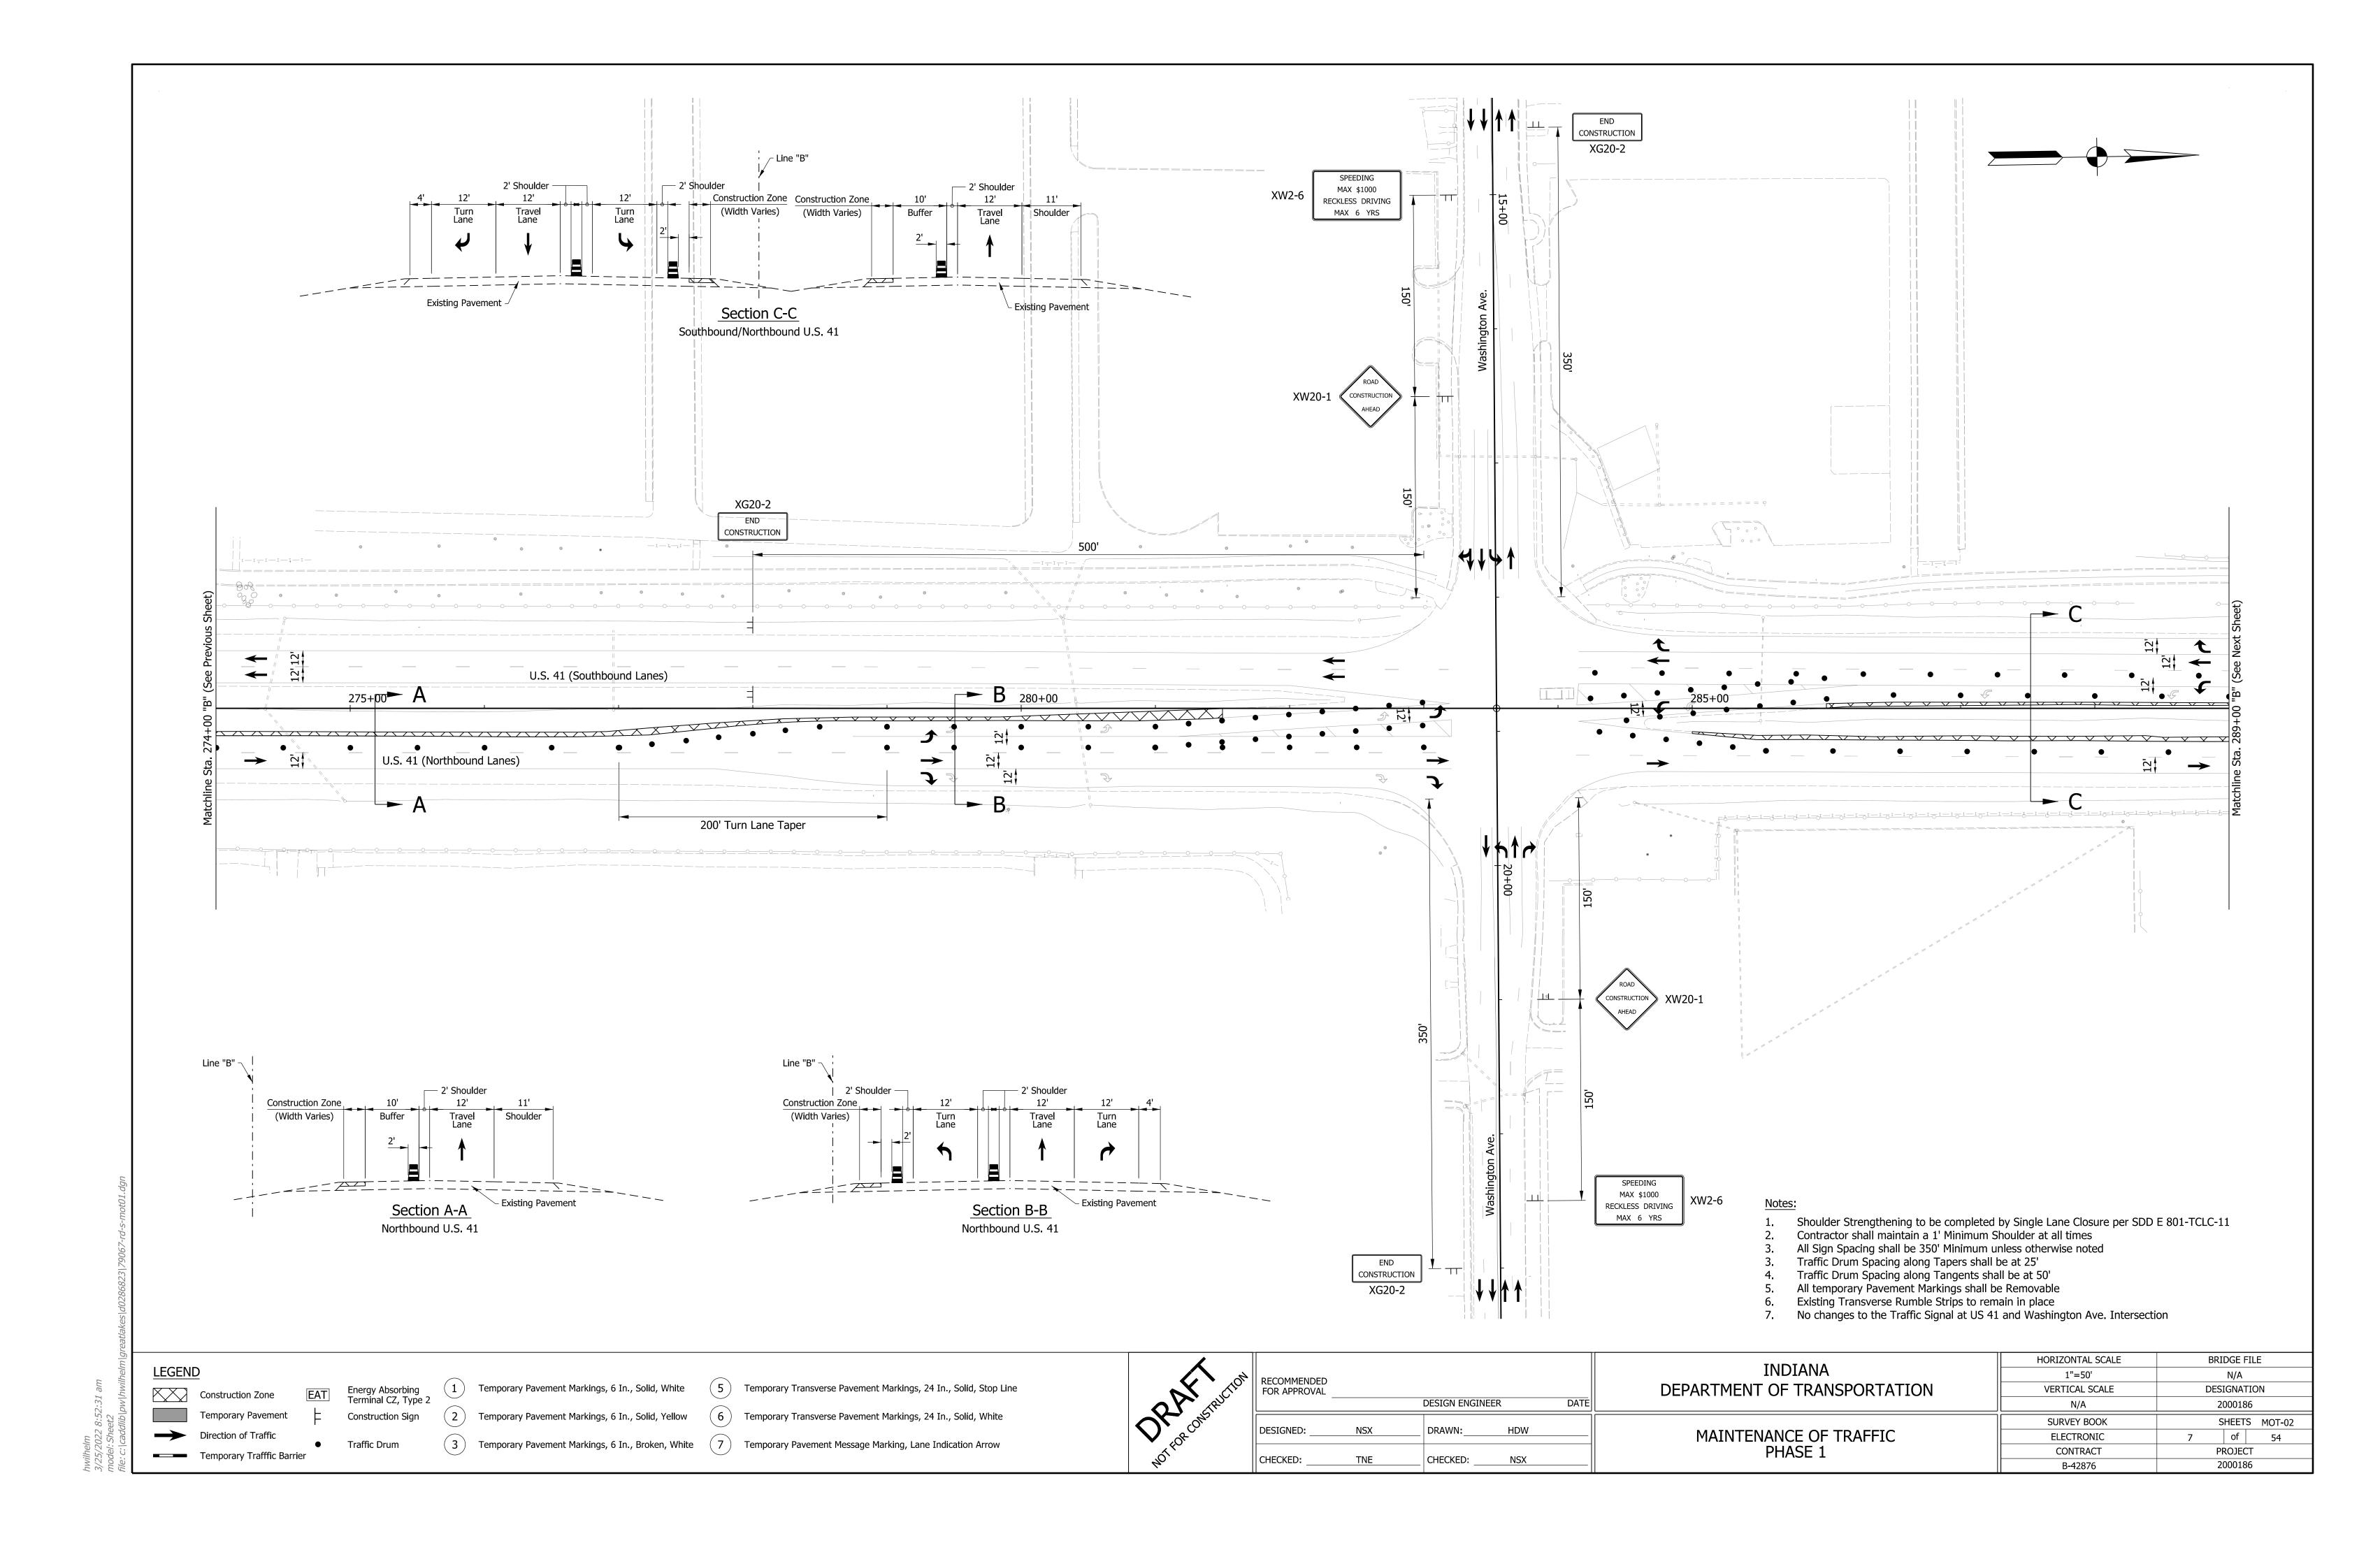


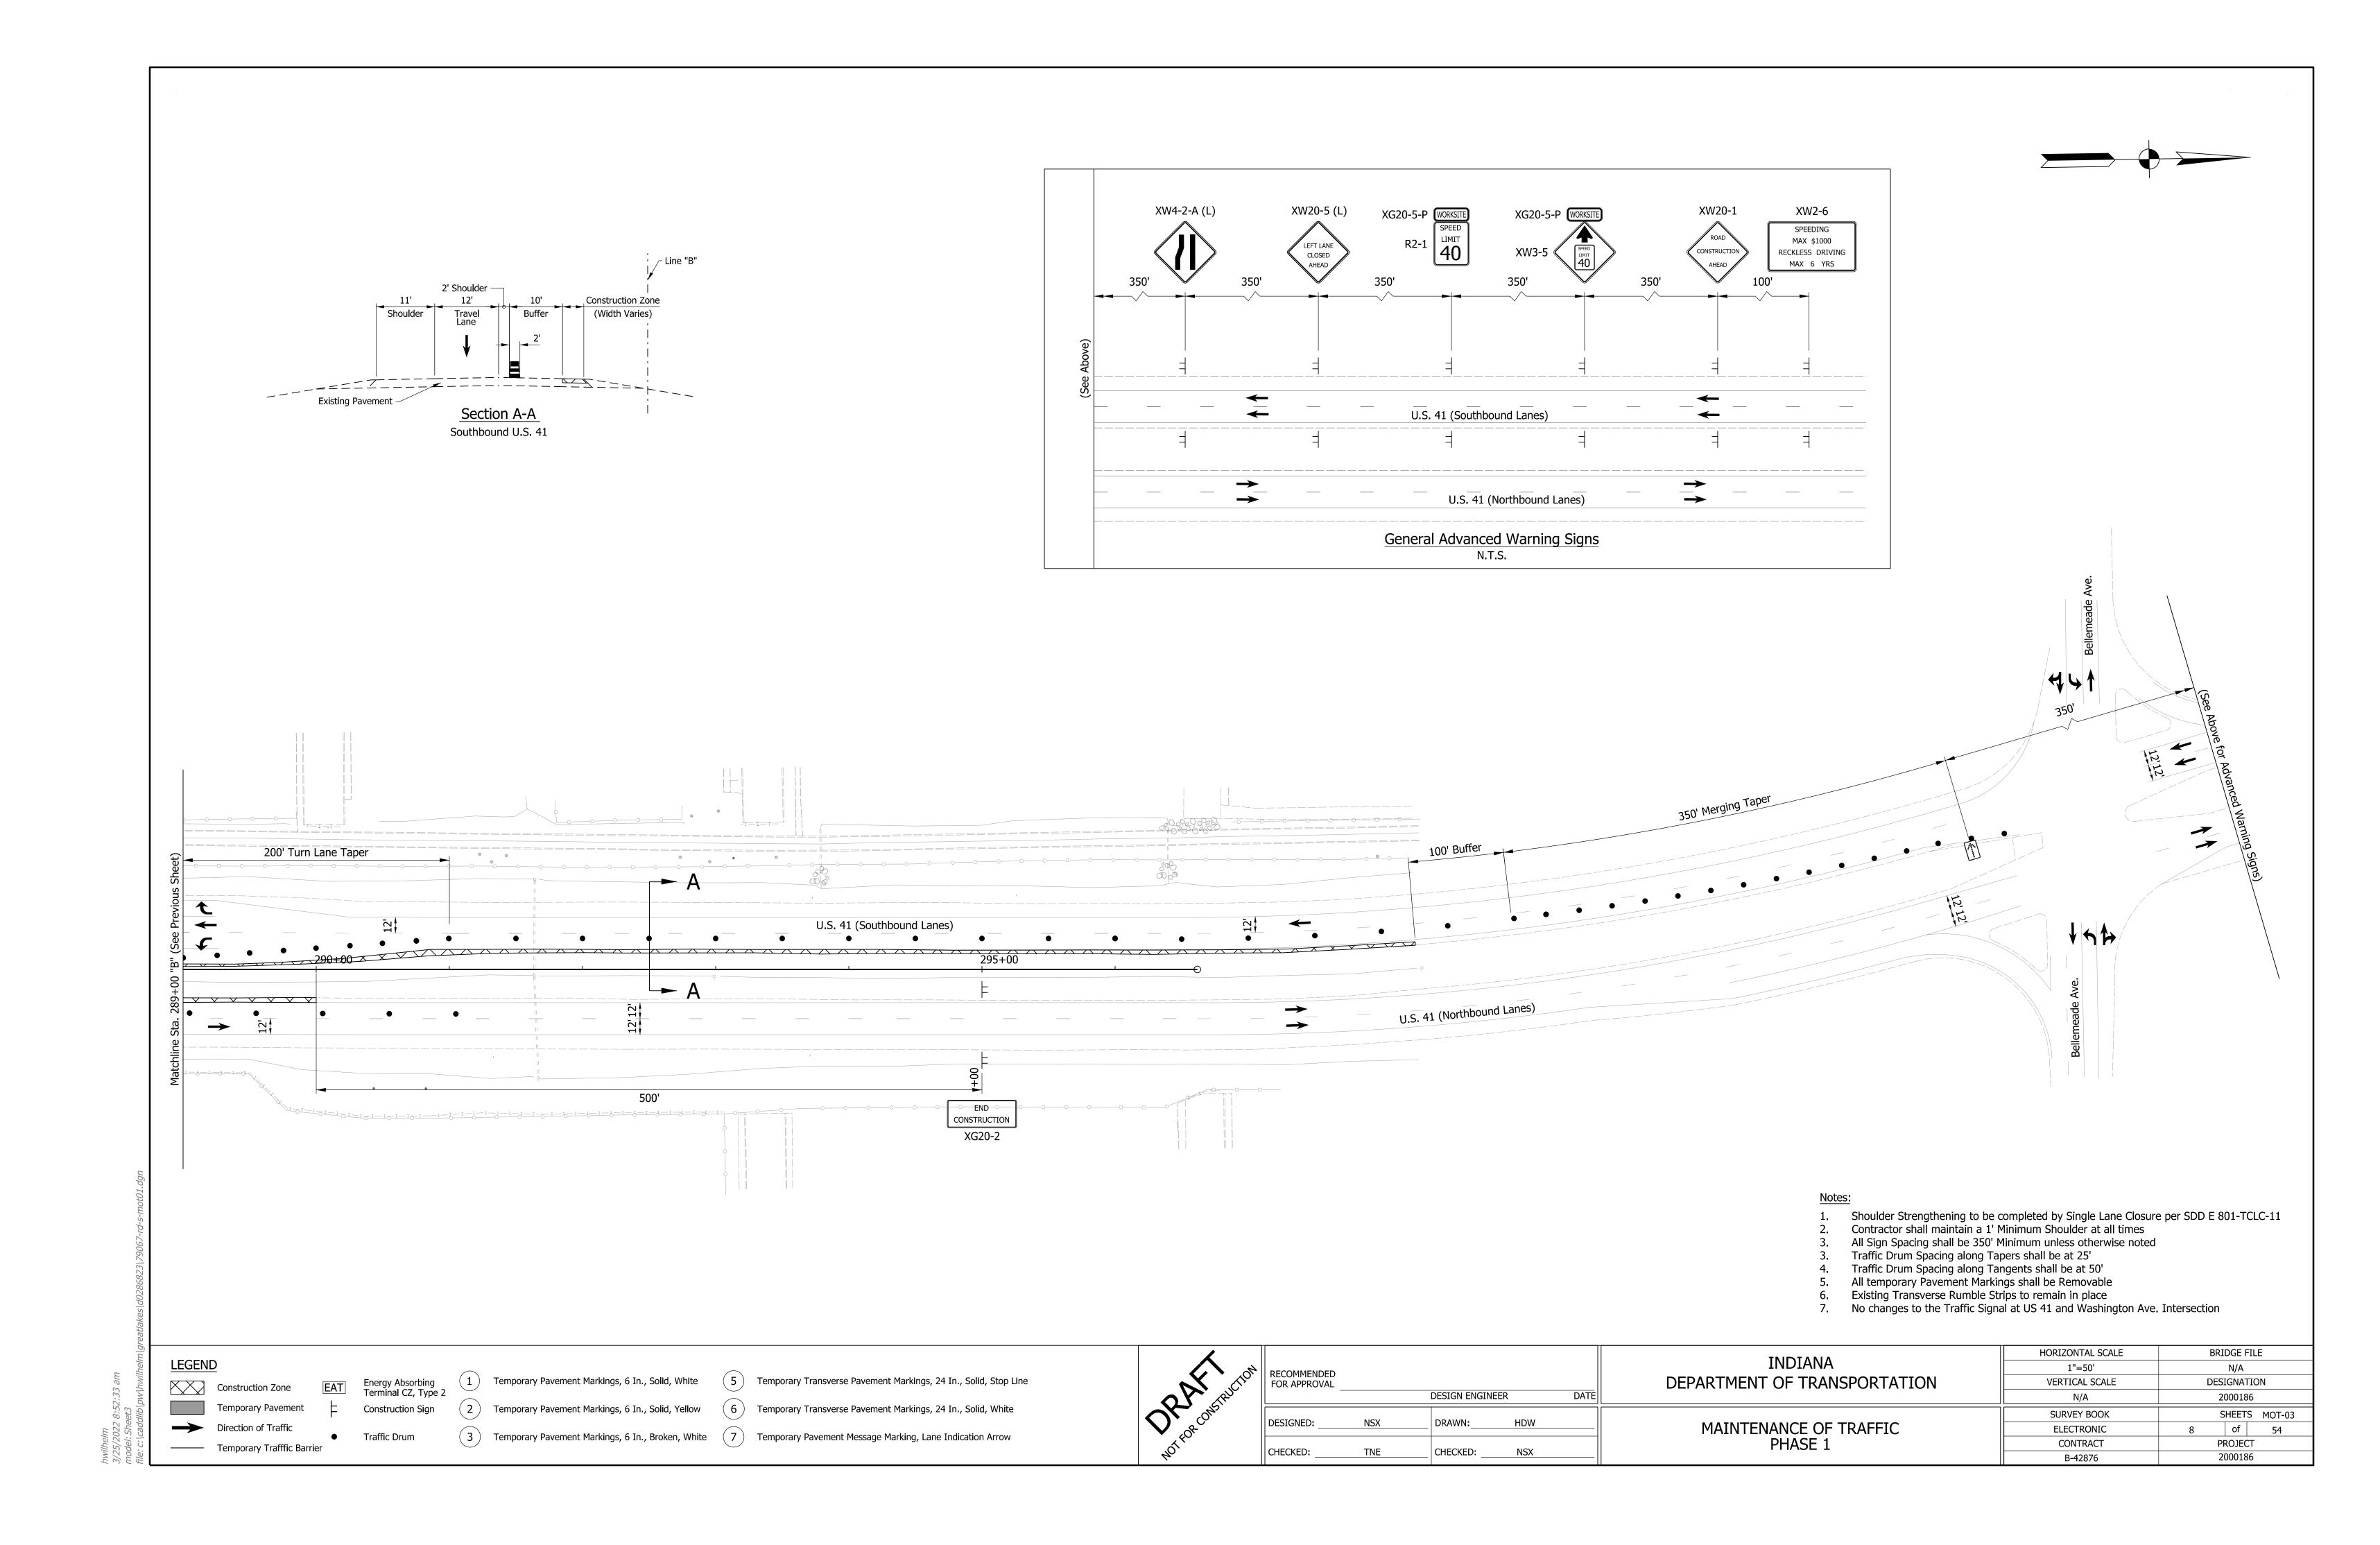
PHASE 2:


- 1. Install Advanced Warning Signs.
- 2. Remove existing Pavement Markings along US 41.
- Install temporary Pavement Markings and Traffic Drums.
- 4. Place temporary Traffic Barrier adjacent to US 41 workzones.
- 5. Construct the Northbound and Southbound along US 41 Outside Shoulder Loons.

Construction Design Speed: 40 MPH Construction Clear Zone: 13'-0"

Maintenance of Traffic Quantity Summary - Pha	3	
	se 2	
Item	Amount	Unit
Construction Sign A	18	EACH
Construction Sign B	4	EACH
Temporary Worksite Speed Limit Sign Assembly	8	EACH
Temporary Pavement Marking, Removable, 6 In.	10,518	LFT
Temporary Transverse Pavement Marking, Removable, Lane Indication Arrow	4	EACH
Temporary Transverse Pavement Marking, Removable, 24 In.	100	LFT
Temporary Traffic Barrier, Type 2	1,614	LFT
Energy Absorbing Terminal, CZ, Type-2	2	EACH

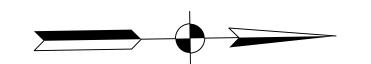

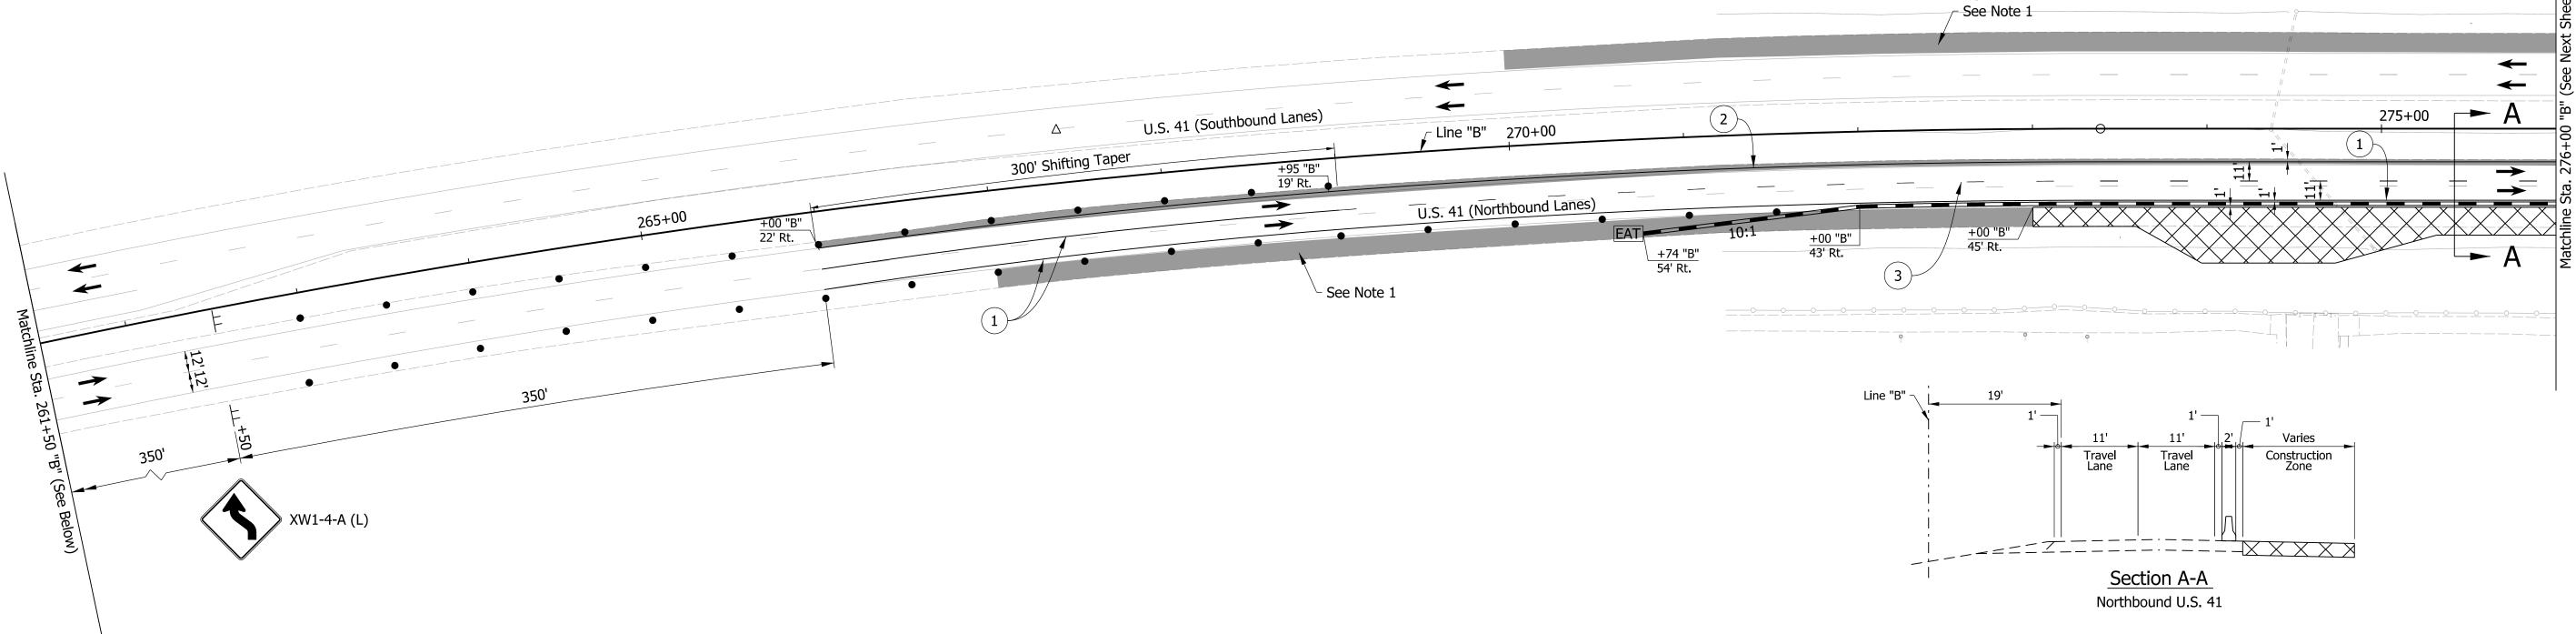

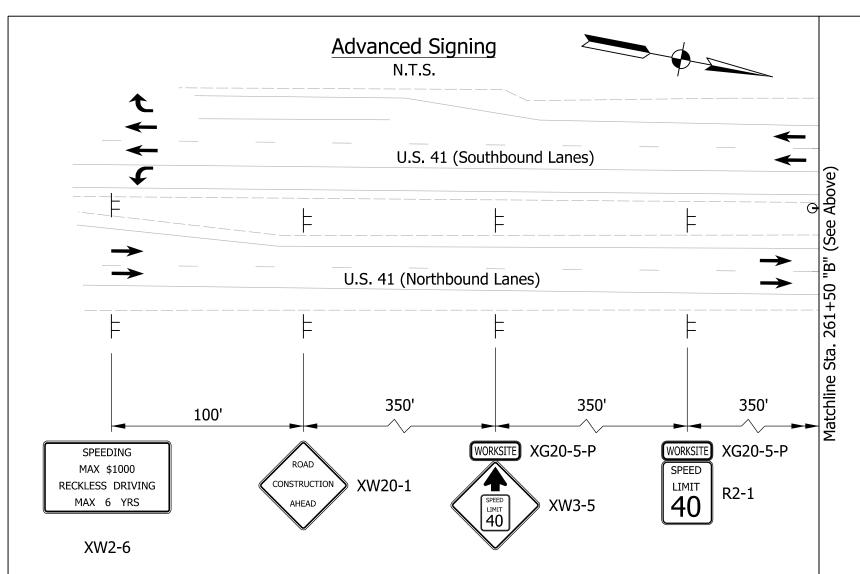

- Shoulder Strengthening to be completed by Single Lane Closure per SDD E 801-TCLC-11
 Screened Signs were place in Previous Construction Phase
 Contractor shall maintain a 1' Minimum Shoulder at all times

- All Sign Spacing shall be 350' Minimum unless otherwise noted
 Traffic Drum Spacing along Tapers shall be at 25'
 Traffic Drum Spacing along Tangents shall be at 50'
 All temporary Pavement Markings shall be Removable
- 8. Existing Transverse Rumble Strips to remain in place9. No changes to the Traffic Signal at US 41 and Washington Ave. Intersection

LEGEND

Construction Zone Temporary Pavement

Direction of Traffic

Temporary Trafffic Barrier

Energy Absorbing Terminal CZ, Type 2 Construction Sign

Traffic Drum

1 Temporary Pavement Markings, 6 In., Solid, White


Temporary Pavement Markings, 6 In., Broken, White 7 Temporary Pavement Message Marking, Lane Indication Arrow

5 Temporary Transverse Pavement Markings, 24 In., Solid, Stop Line


2 Temporary Pavement Markings, 6 In., Solid, Yellow 6 Temporary Transverse Pavement Markings, 24 In., Solid, White


1	RECOMMENDED FOR APPROVAL		DESIGN ENGINE	ER	DATE
	DESIGNED:	NSX	DRAWN:	HDW	
	CHECKED:	TNE	CHECKED:	NSX	

TAIDTANIA	HORIZONTAL SCALE	BRIDGE FILE
INDIANA	1"=50'	N/A
DEPARTMENT OF TRANSPORTATION	VERTICAL SCALE	DESIGNATION
	N/A	2000186
	SURVEY BOOK	SHEETS MOT-04
MAINTENANCE OF TRAFFIC	ELECTRONIC	9 of 54
PHASE 2	CONTRACT	PROJECT
	B-42876	2000186

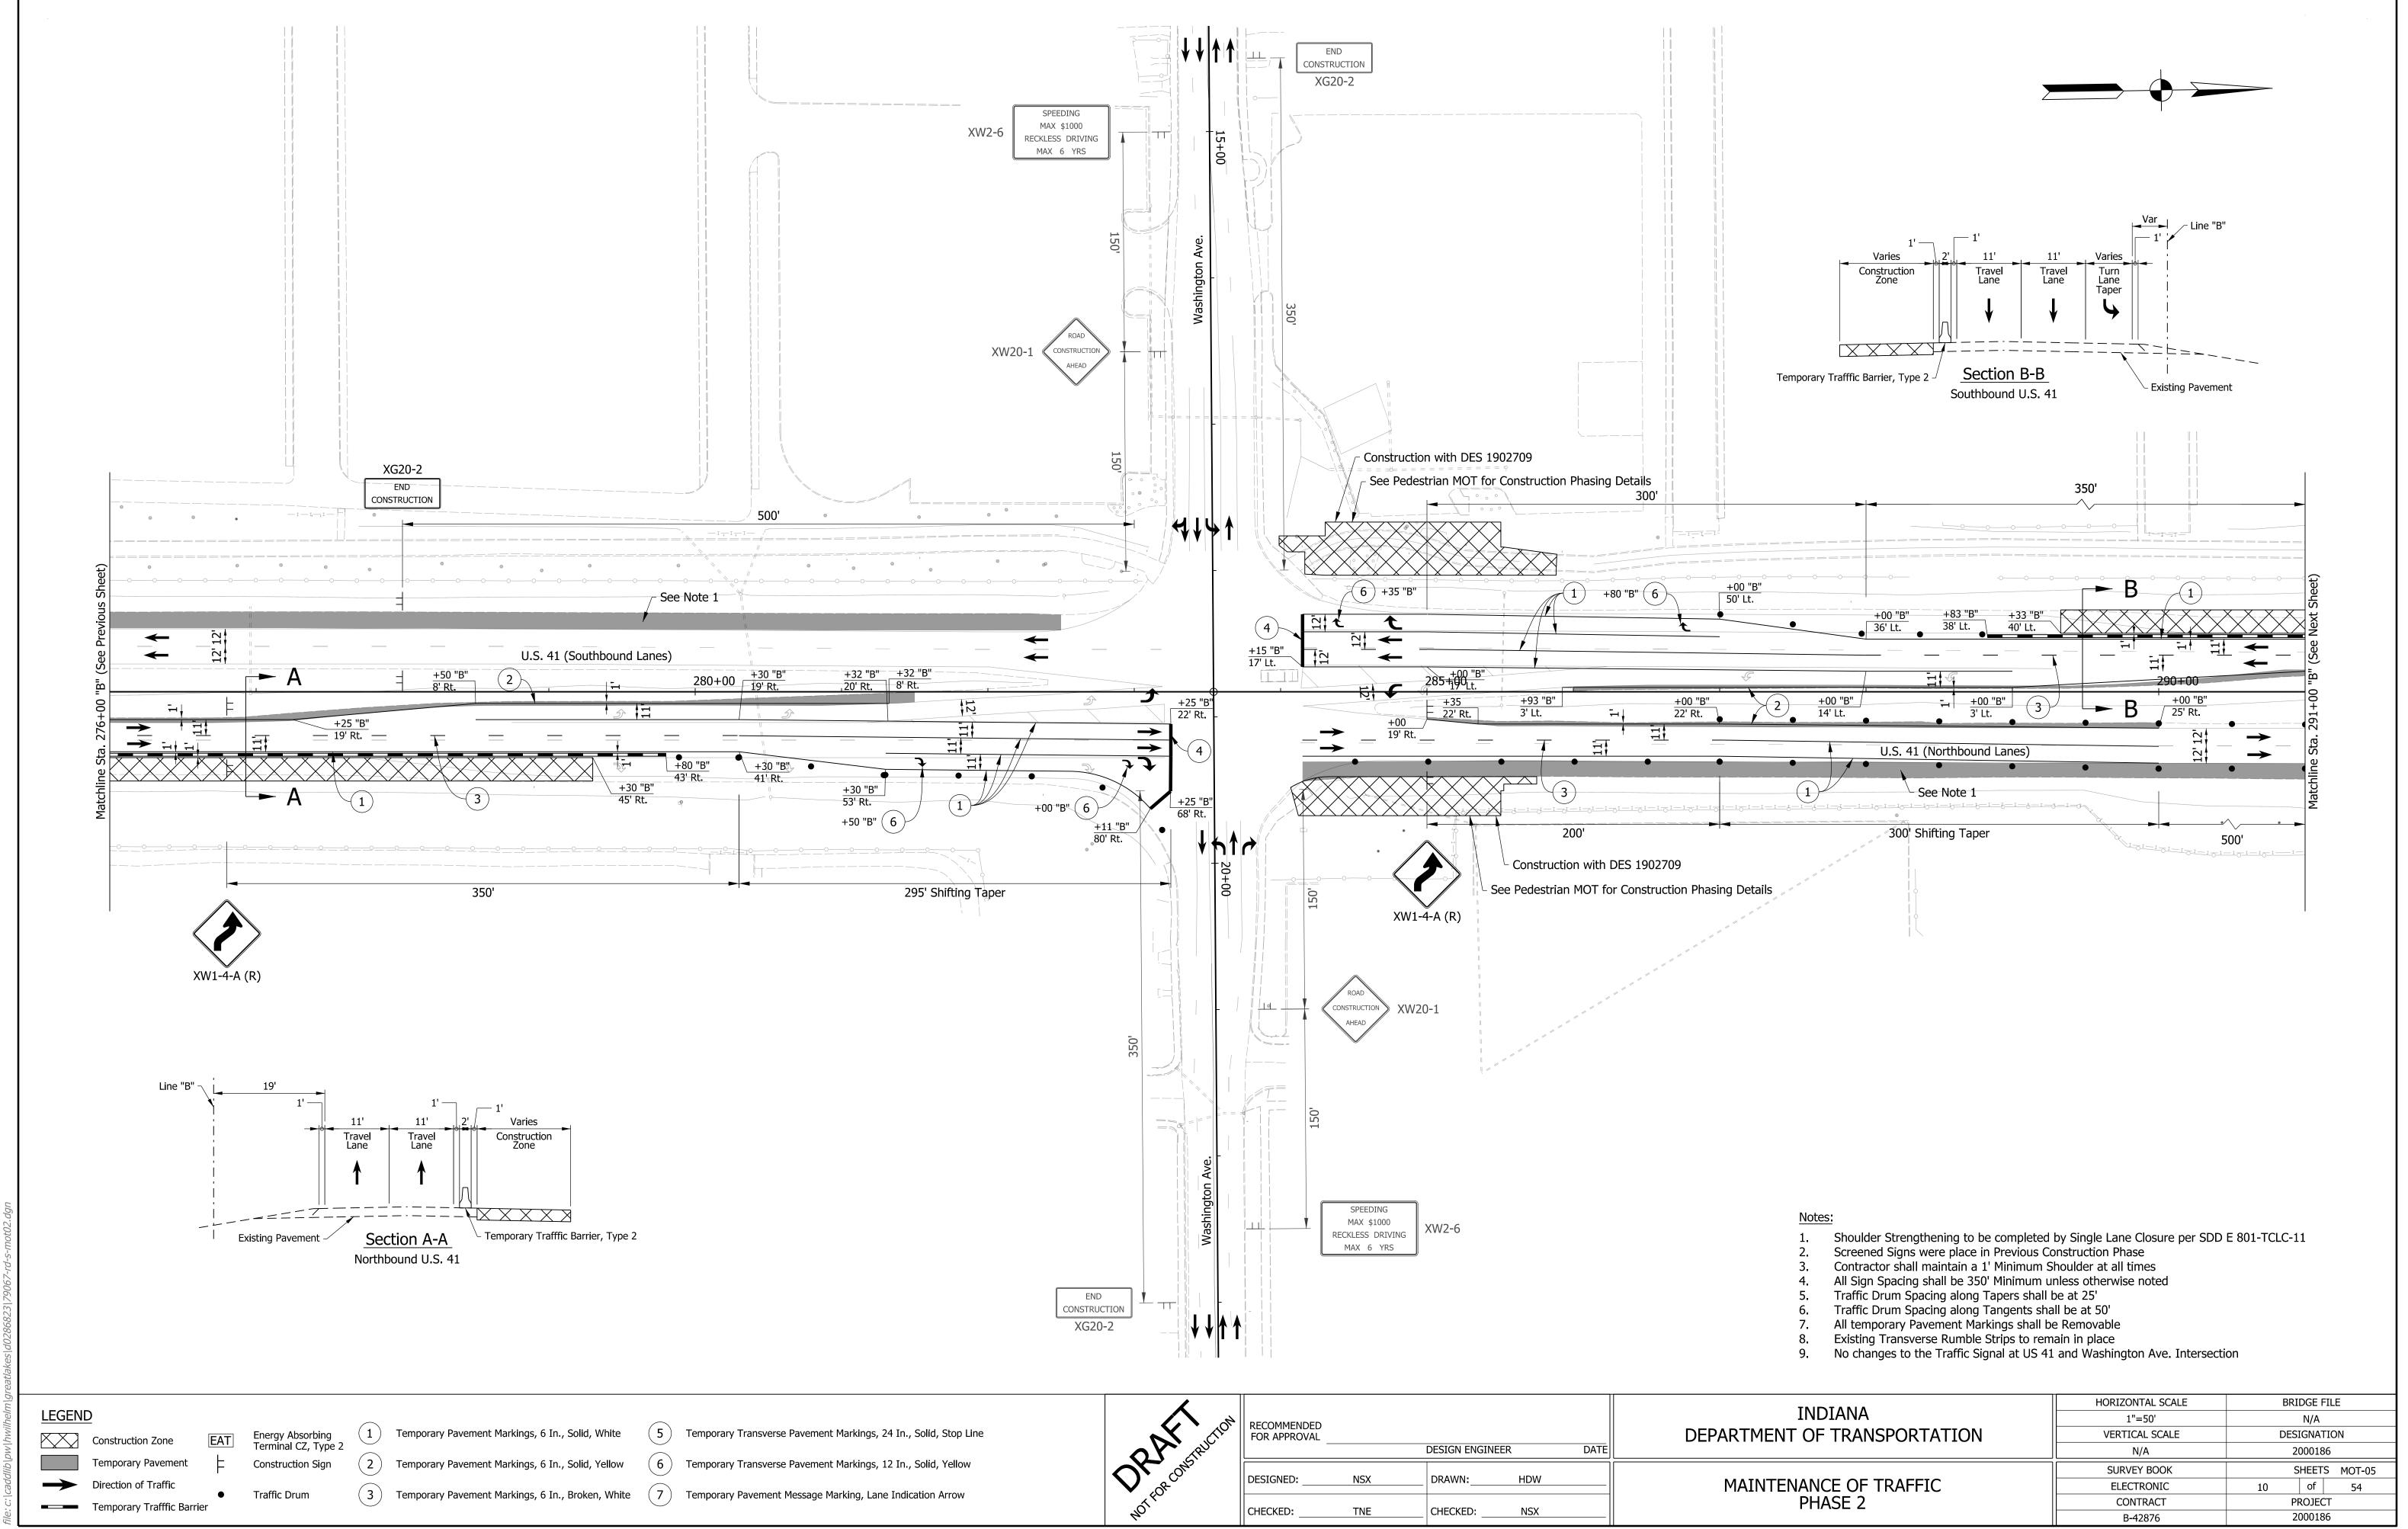

3/25/2022 8:52:39 am model: Sheet2

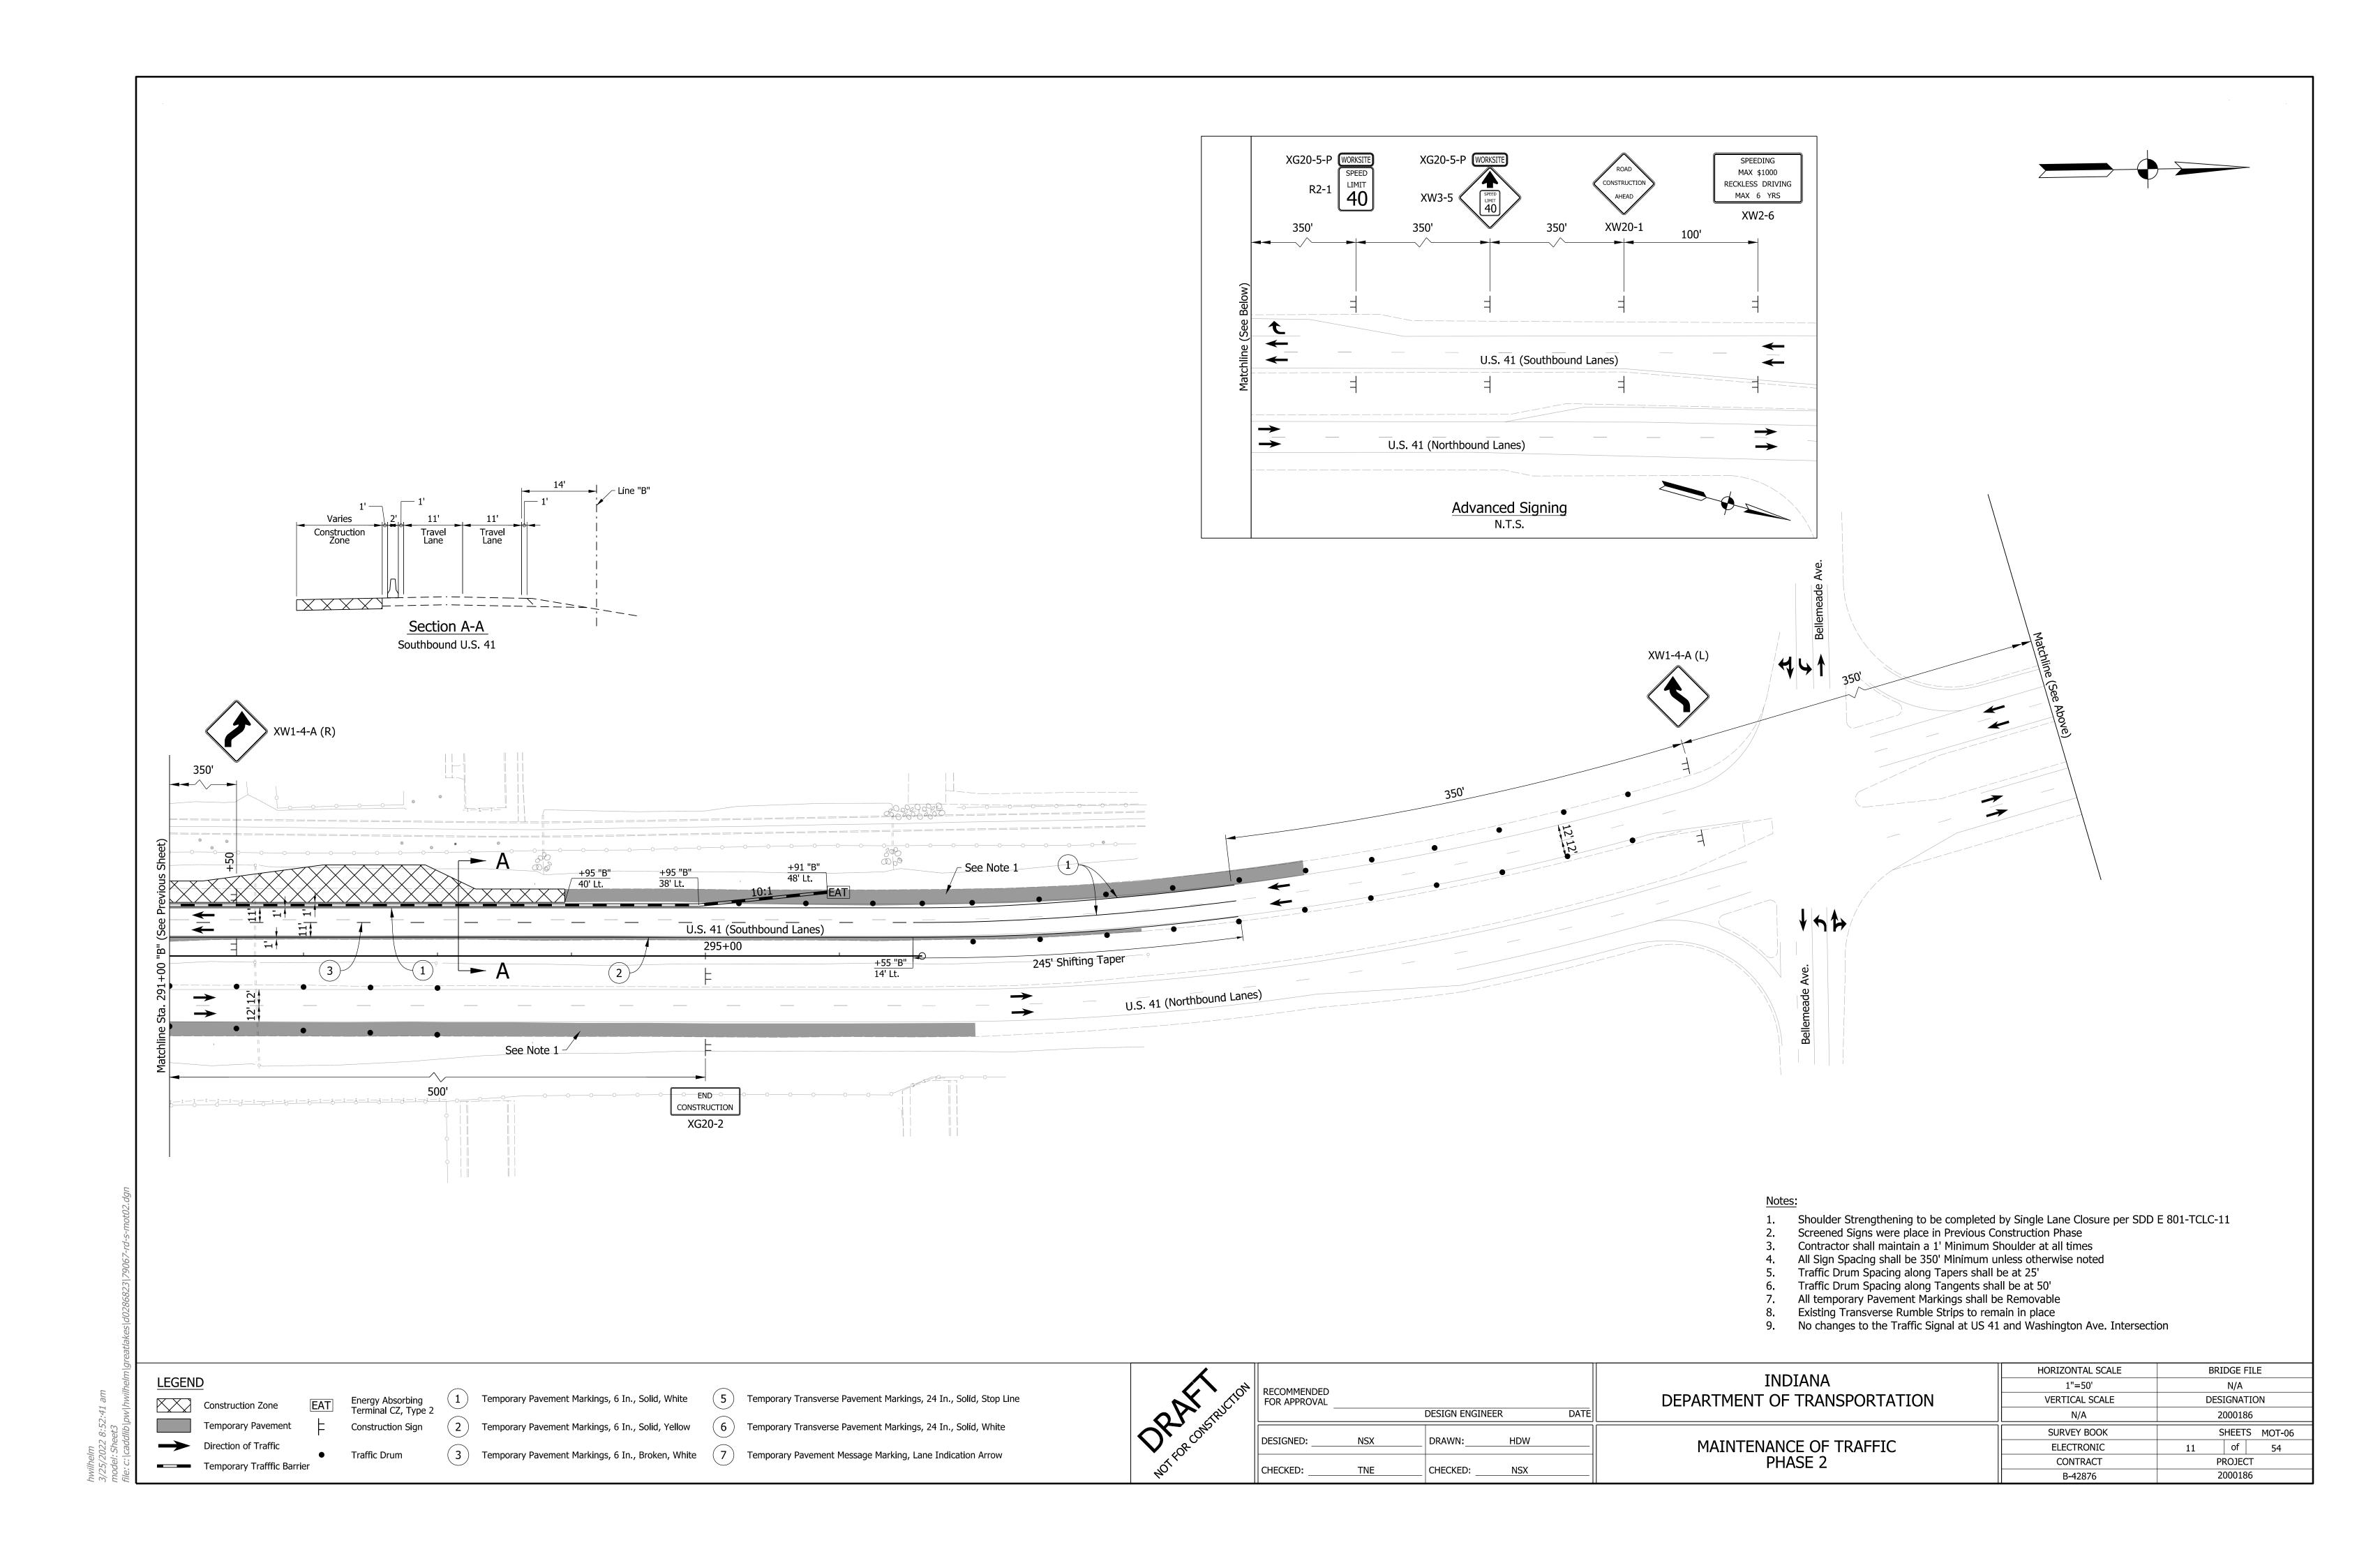

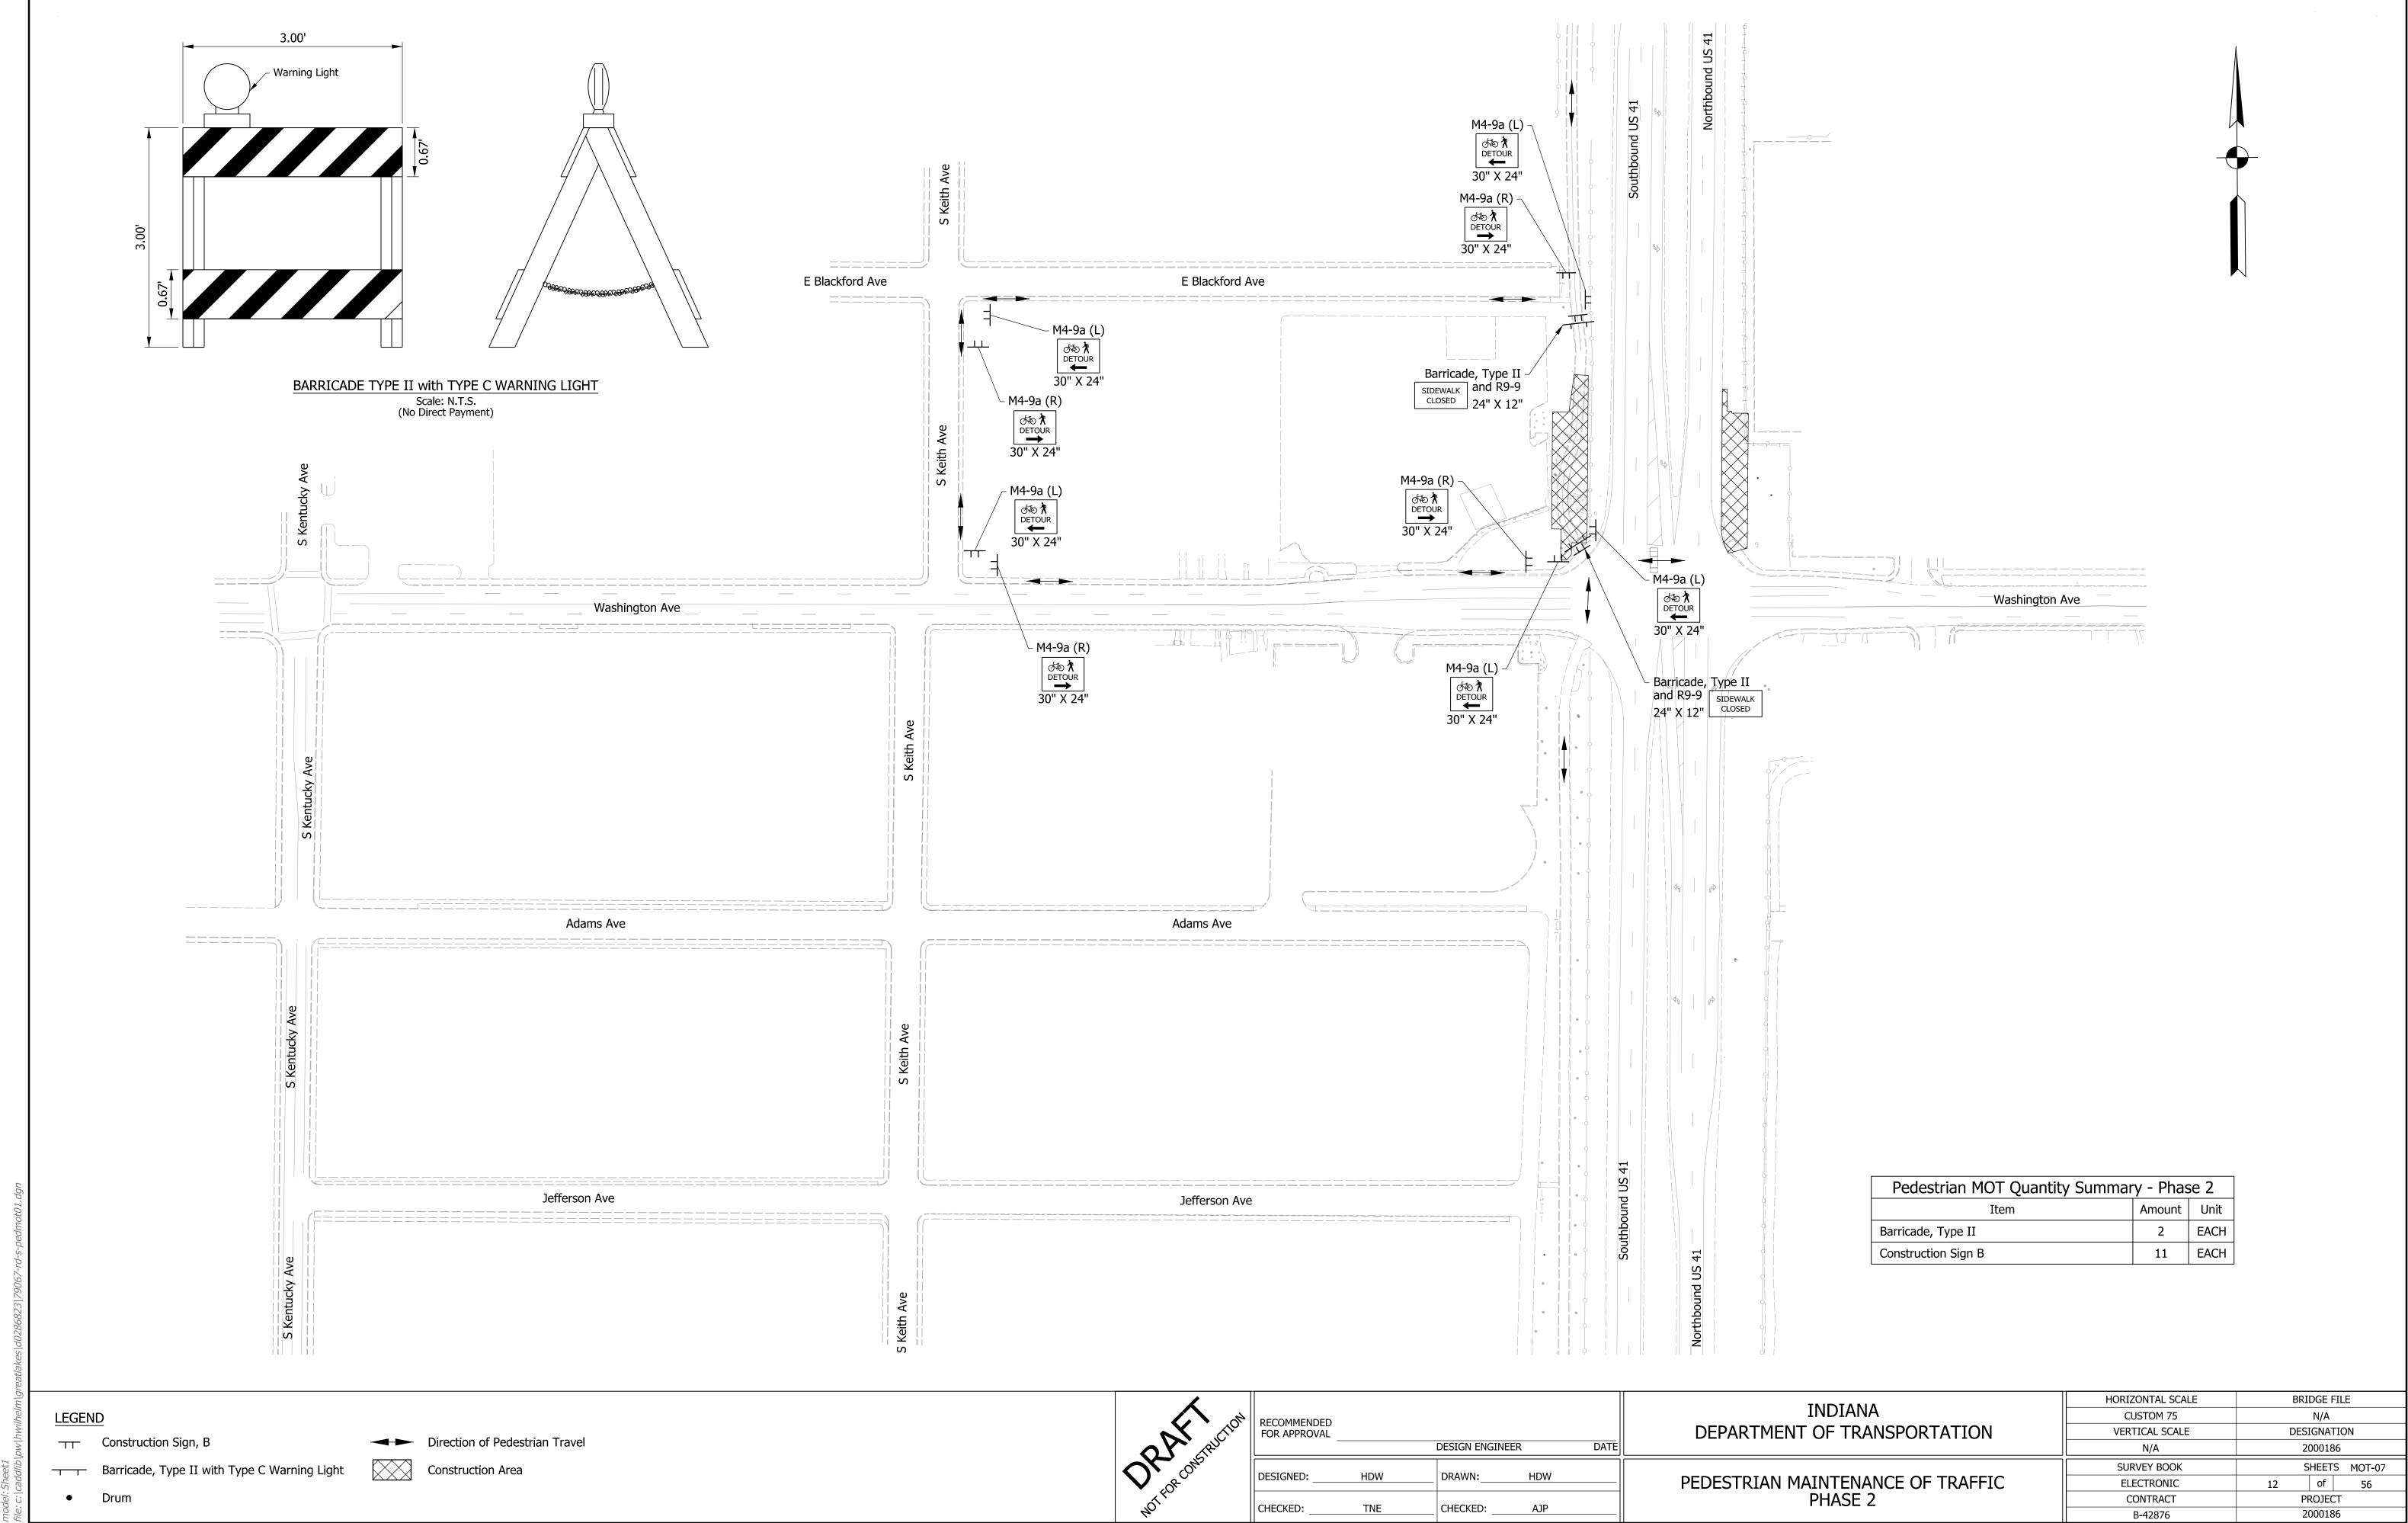

3/25/2022 8:52:48 am model: Sheet1


PHASE 3A:


- 1. Install Advanced Warning Signs.
- 2. Remove existing Pavement Markings and temporary Pavement Markings from Phase 2 along US 41.
- 3. Install temporary Pavement Markings and Traffic Drums.
- 4. Place temporary Traffic Barrier adjacent to US 41 workzones.
- 5. Construct the Northbound and Southbound Median U-Turn Lanes and Median Widening along US 41.


Construction Design Speed: 40 MPH


Construction Clear Zone: 13'-0"

Maintenance of Traffic Quantity Summary - Phase 3A				
Item	Amount	Unit		
Construction Sign A	18	EACH		
Construction Sign B	6	EACH		
Temporary Worksite Speed Limit Sign Assembly	8	EACH		
Temporary Pavement Marking, Removable, 6 In.	15,285	LFT		
Temporary Transverse Pavement Marking, Removable, Lane Indication Arrow	2	EACH		
Temporary Transverse Pavement Marking, Removable, 24 In.	113	LFT		
Temporary Traffic Barrier, Type 2	4,020	LFT		
Energy Absorbing Terminal, CZ, Type-2	4	EACH		
	•			

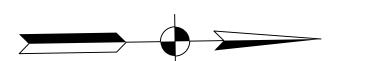

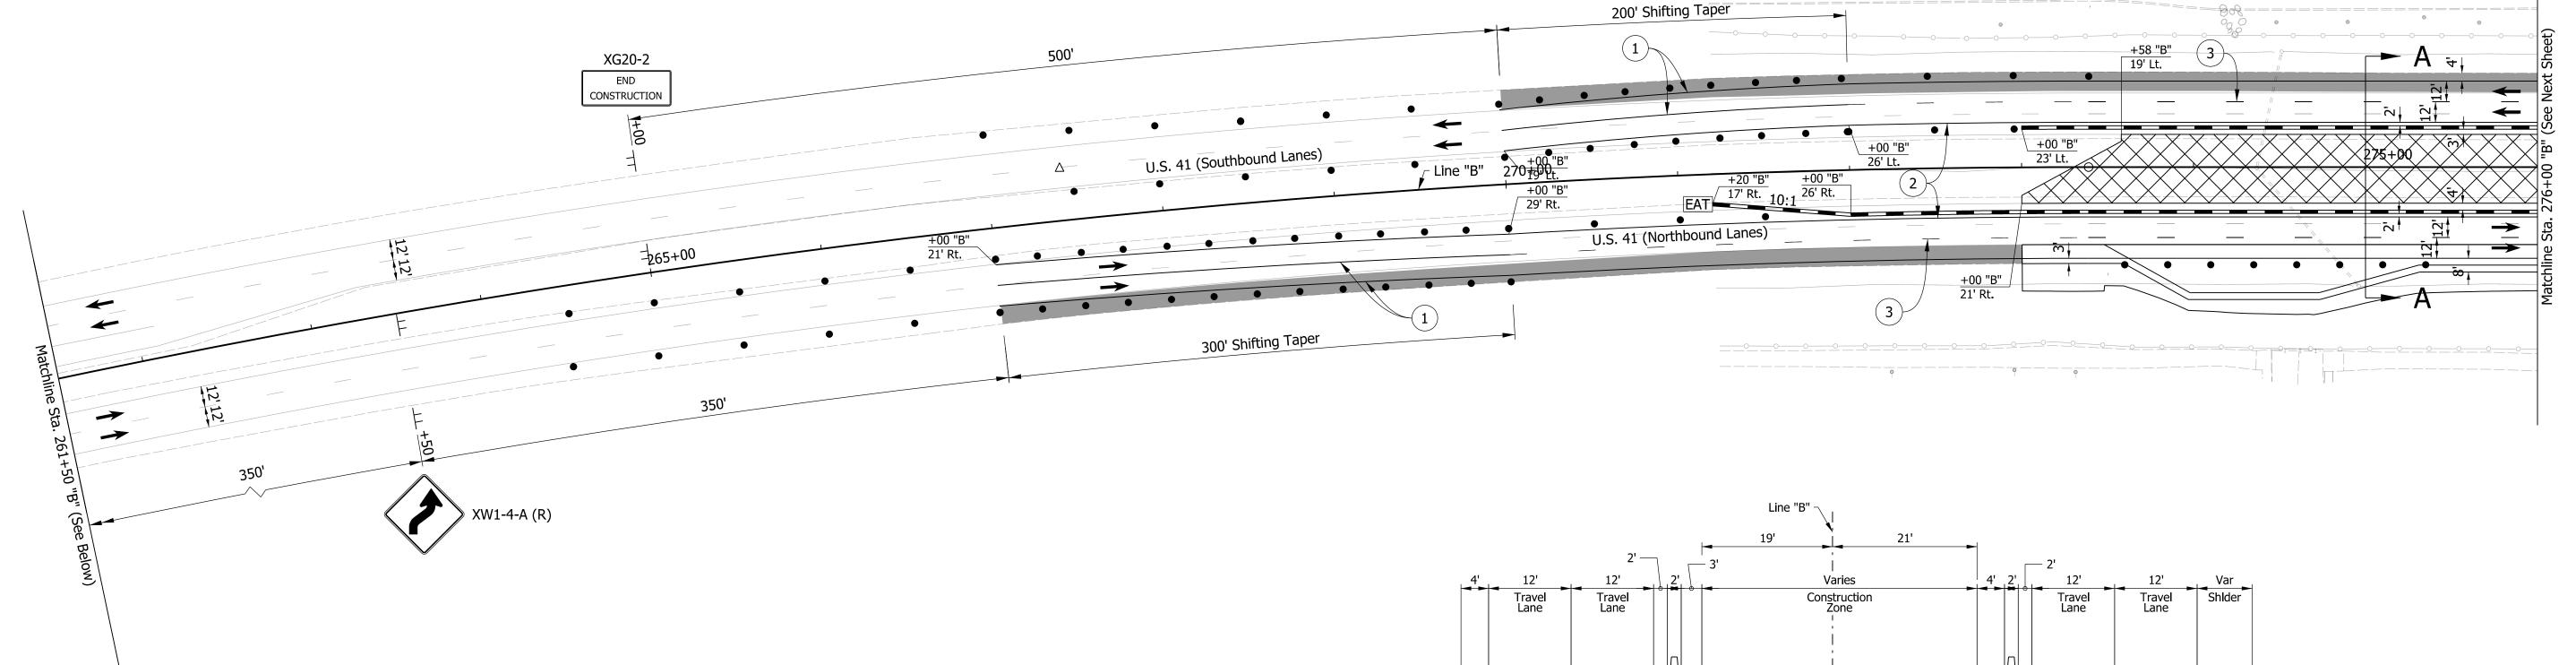

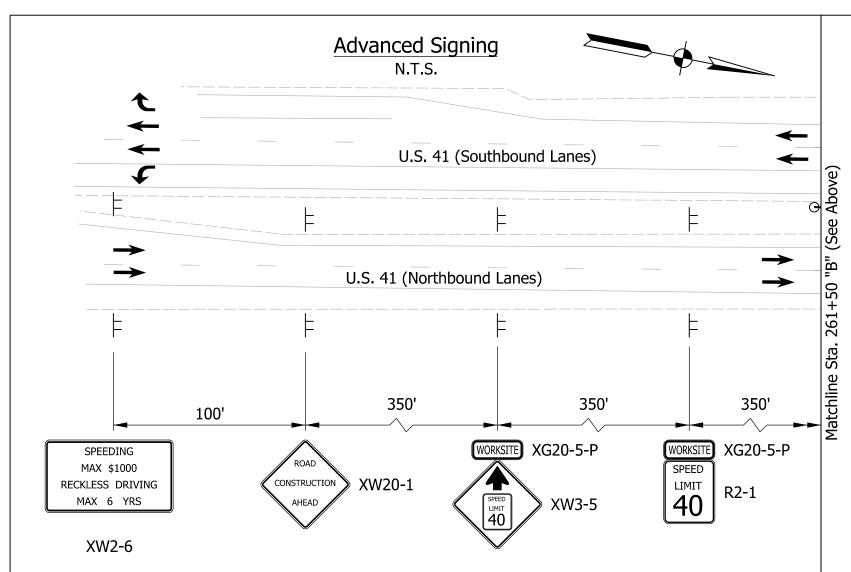

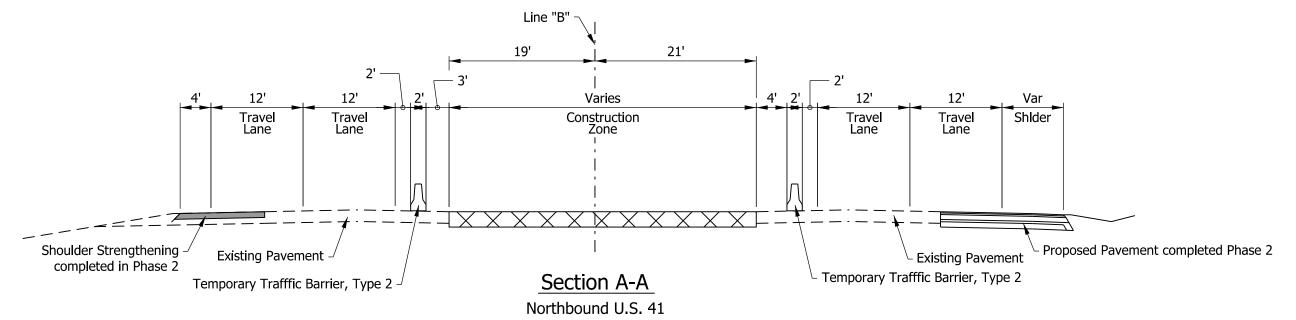

- Contractor shall maintain a 2' Minimum Shoulder at all times
- All Sign Spacing shall be 350' Minimum unless otherwise noted Traffic Drum Spacing along Tapers shall be at 25' Traffic Drum Spacing along Tangents shall be at 50'
- All temporary Pavement Markings shall be Removable
- Existing Transverse Rumble Strips to remain in place
- No changes to the Traffic Signal at US 41 and Washington Ave. Intersection

<u>LEGEND</u>

Construction Zone Temporary Pavement Direction of Traffic

Temporary Trafffic Barrier

Energy Absorbing Terminal CZ, Type 2 Construction Sign

Traffic Drum

1 Temporary Pavement Markings, 6 In., Solid, White

Temporary Pavement Markings, 6 In., Broken, White 7 Temporary Pavement Message Marking, Lane Indication Arrow


(5) Temporary Transverse Pavement Markings, 24 In., Solid, Stop Line

(2) Temporary Pavement Markings, 6 In., Solid, Yellow (6) Temporary Transverse Pavement Markings, 24 In., Solid, White


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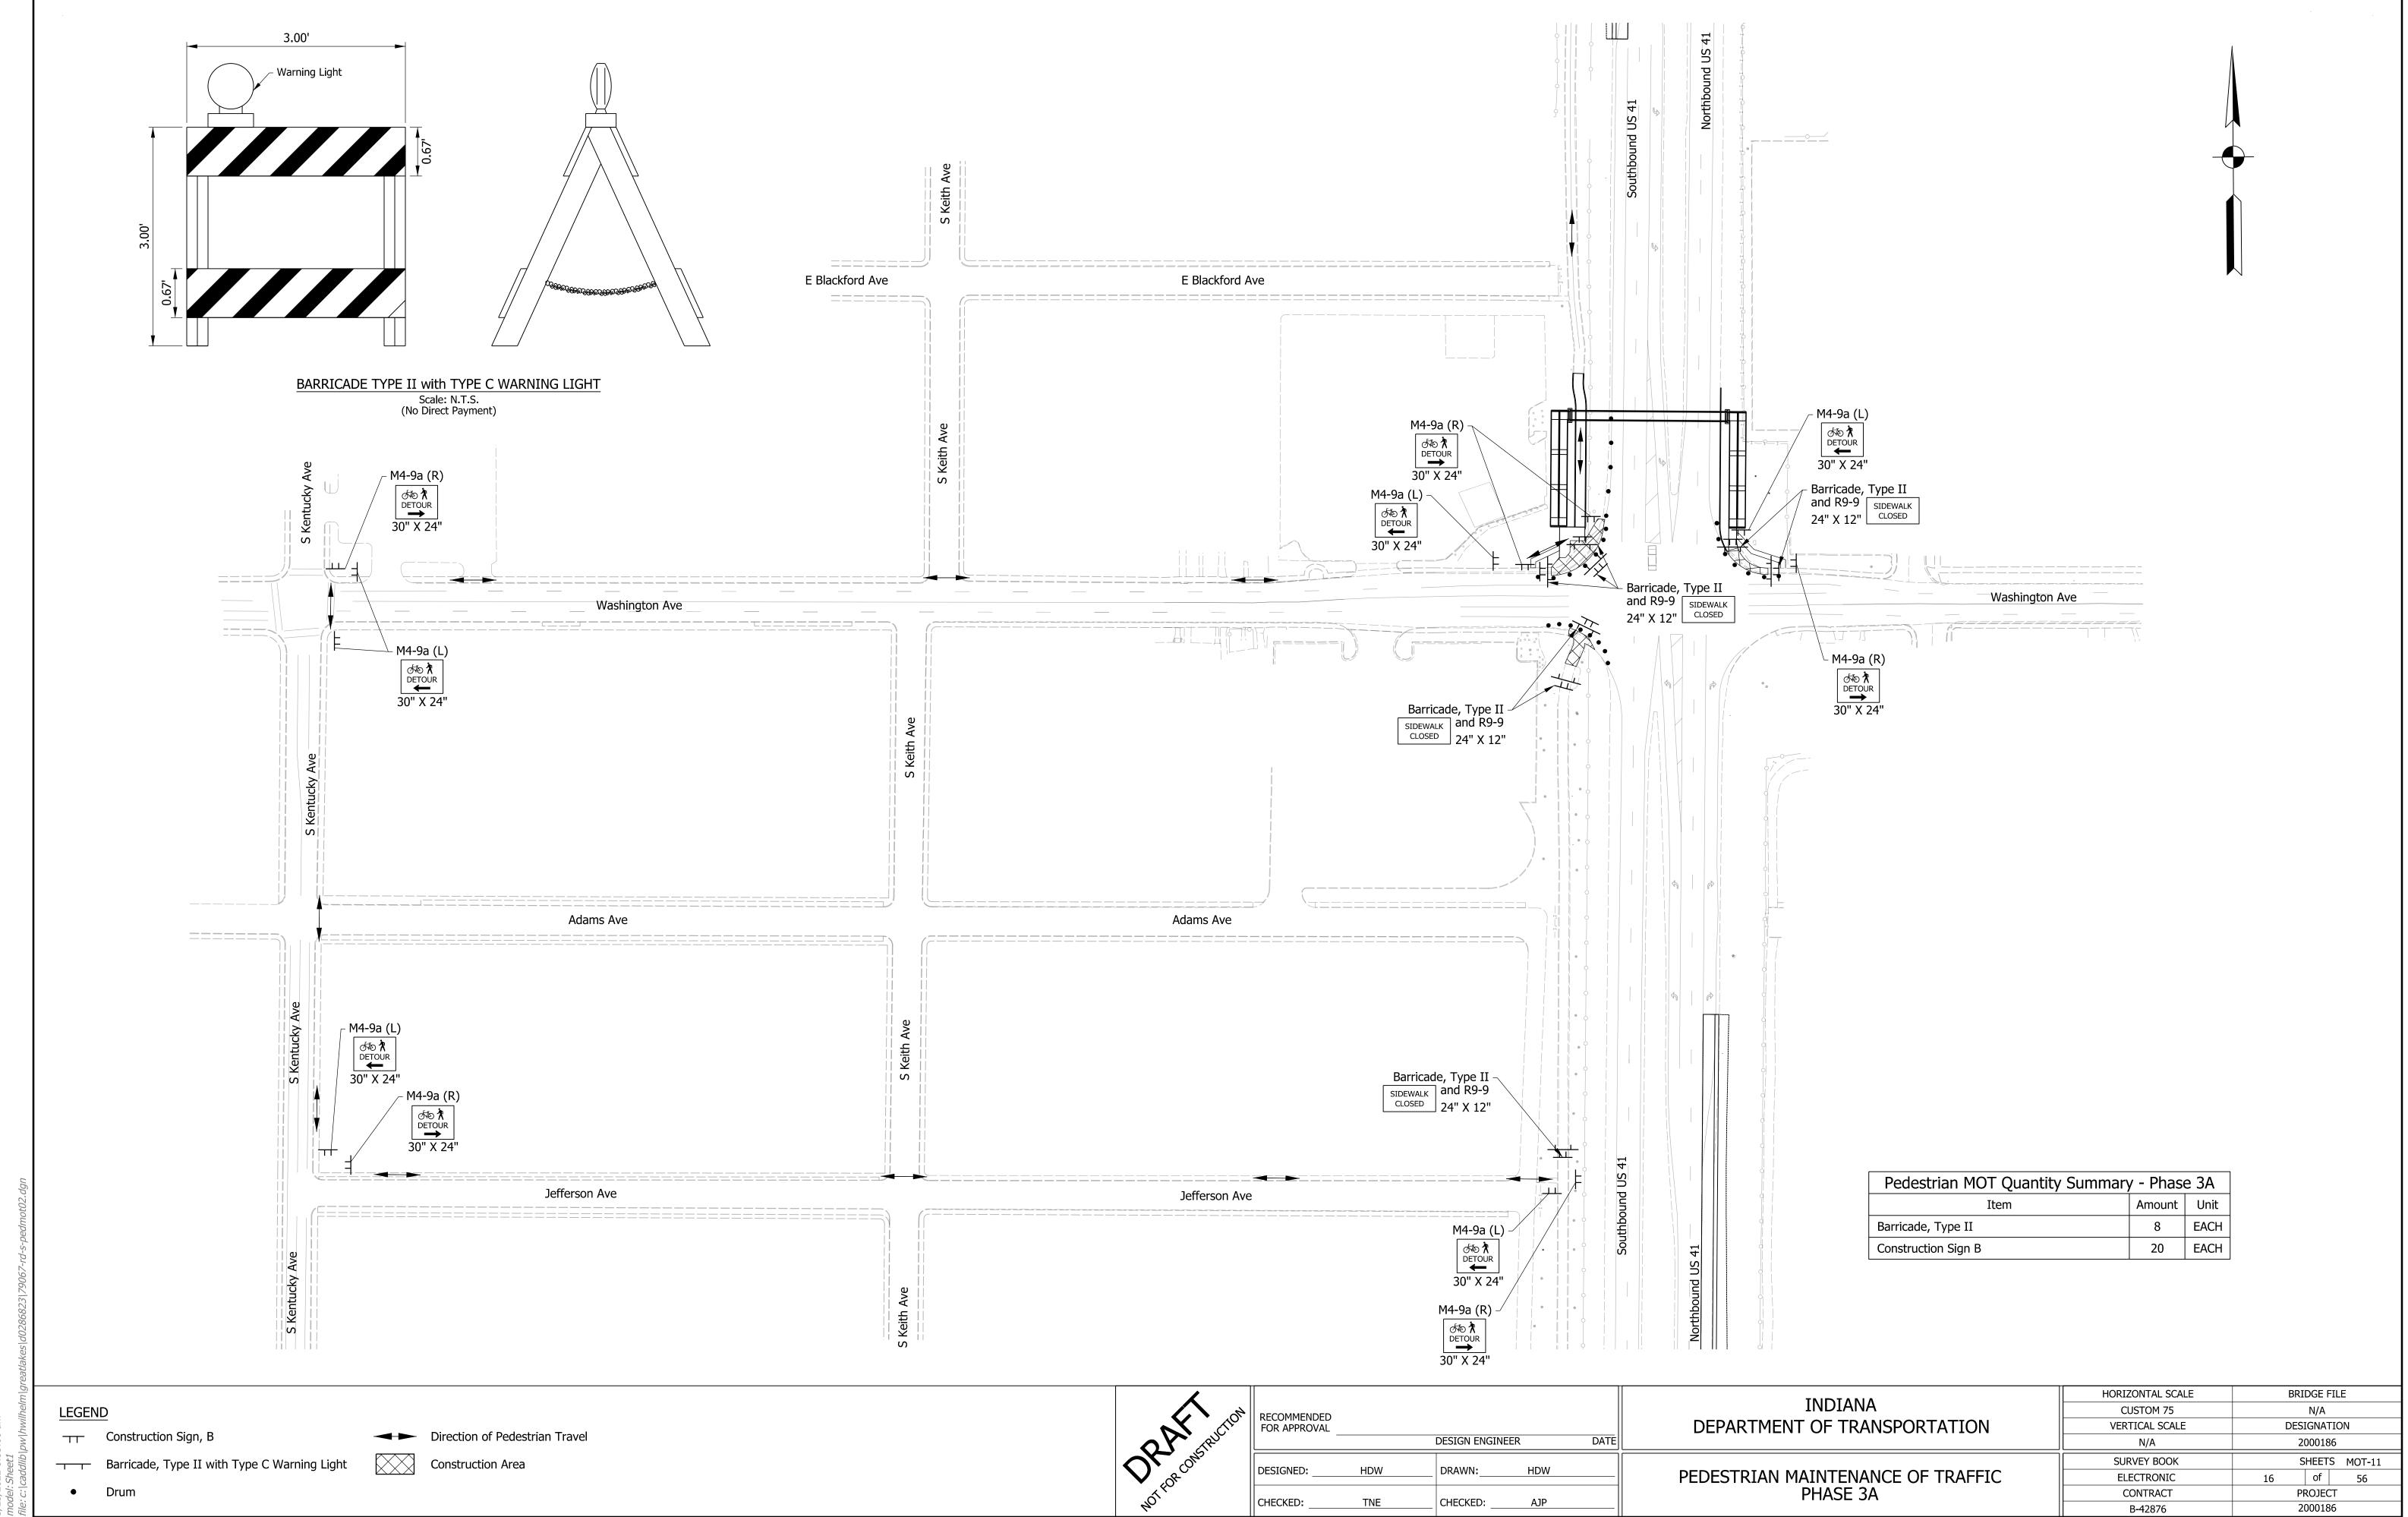
RECOMMENDED FOR APPROVAL		DESIGN ENGINEER	DATE	DEPARTME
DESIGNED:	NSX	DRAWN:	HDW	MAINT
CHECKED:	TNE	CHECKED:	NSX	

INDIANA DEPARTMENT OF TRANSPORTATION	HORIZONTAL SCALE	BRIDGE FILE
	1"=50'	N/A
	VERTICAL SCALE	DESIGNATION
	N/A	2000186
MAINTENANCE OF TRAFFIC PHASE 3A	SURVEY BOOK	SHEETS MOT-07
	ELECTRONIC	12 of 54
	CONTRACT	PROJECT
	B-42876	2000186

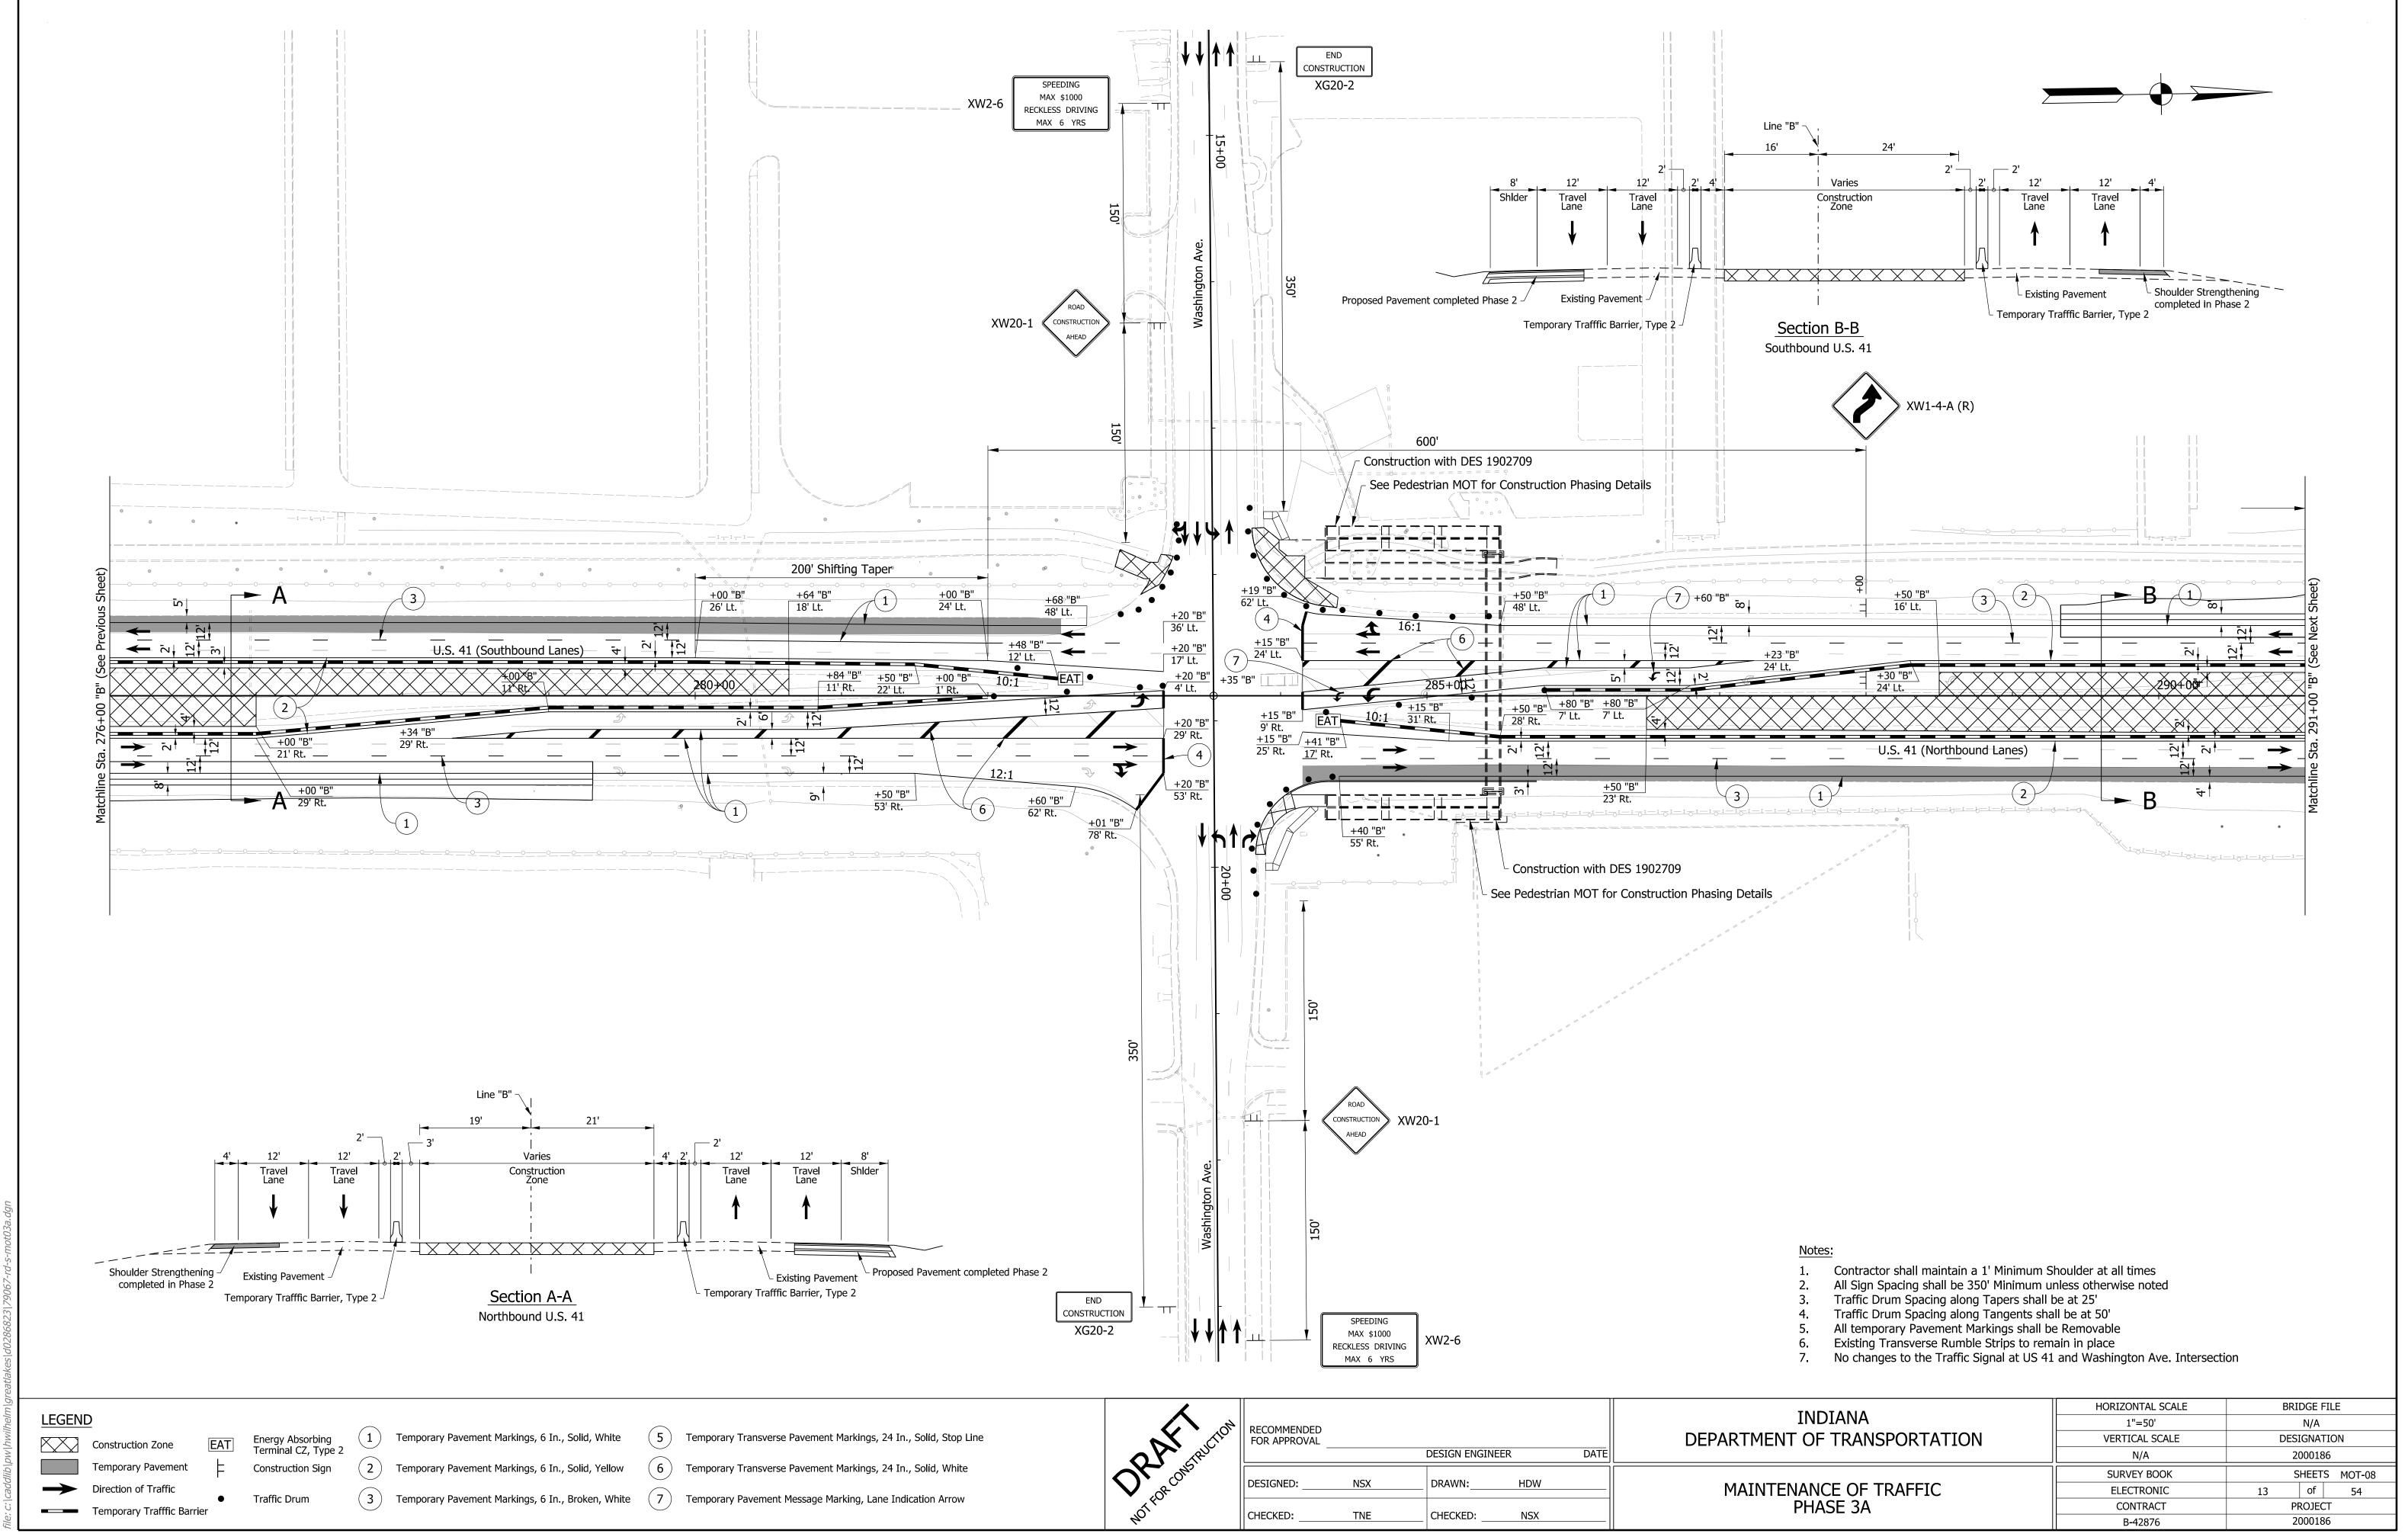

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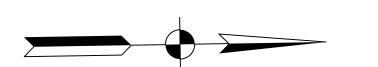
PHASE 3B:


- 1. Remove any conflicting temporary Pavement Markings from Phase 3A along US 41.
- 2. Install temporary Pavement Markings and Traffic Drums.
- Install Permanent Pavement Markings on and adjacent to Completed U-Turn Lanes along US 41.
- 3. Place temporary Traffic Barrier adjacent to US 41 workzones.
- 4. Finish constructing the Northbound and Southbound Median U-Turn Lanes and Median Widening along US 41 and Remove Existing Left Turn Lanes and Intersection Pavement.

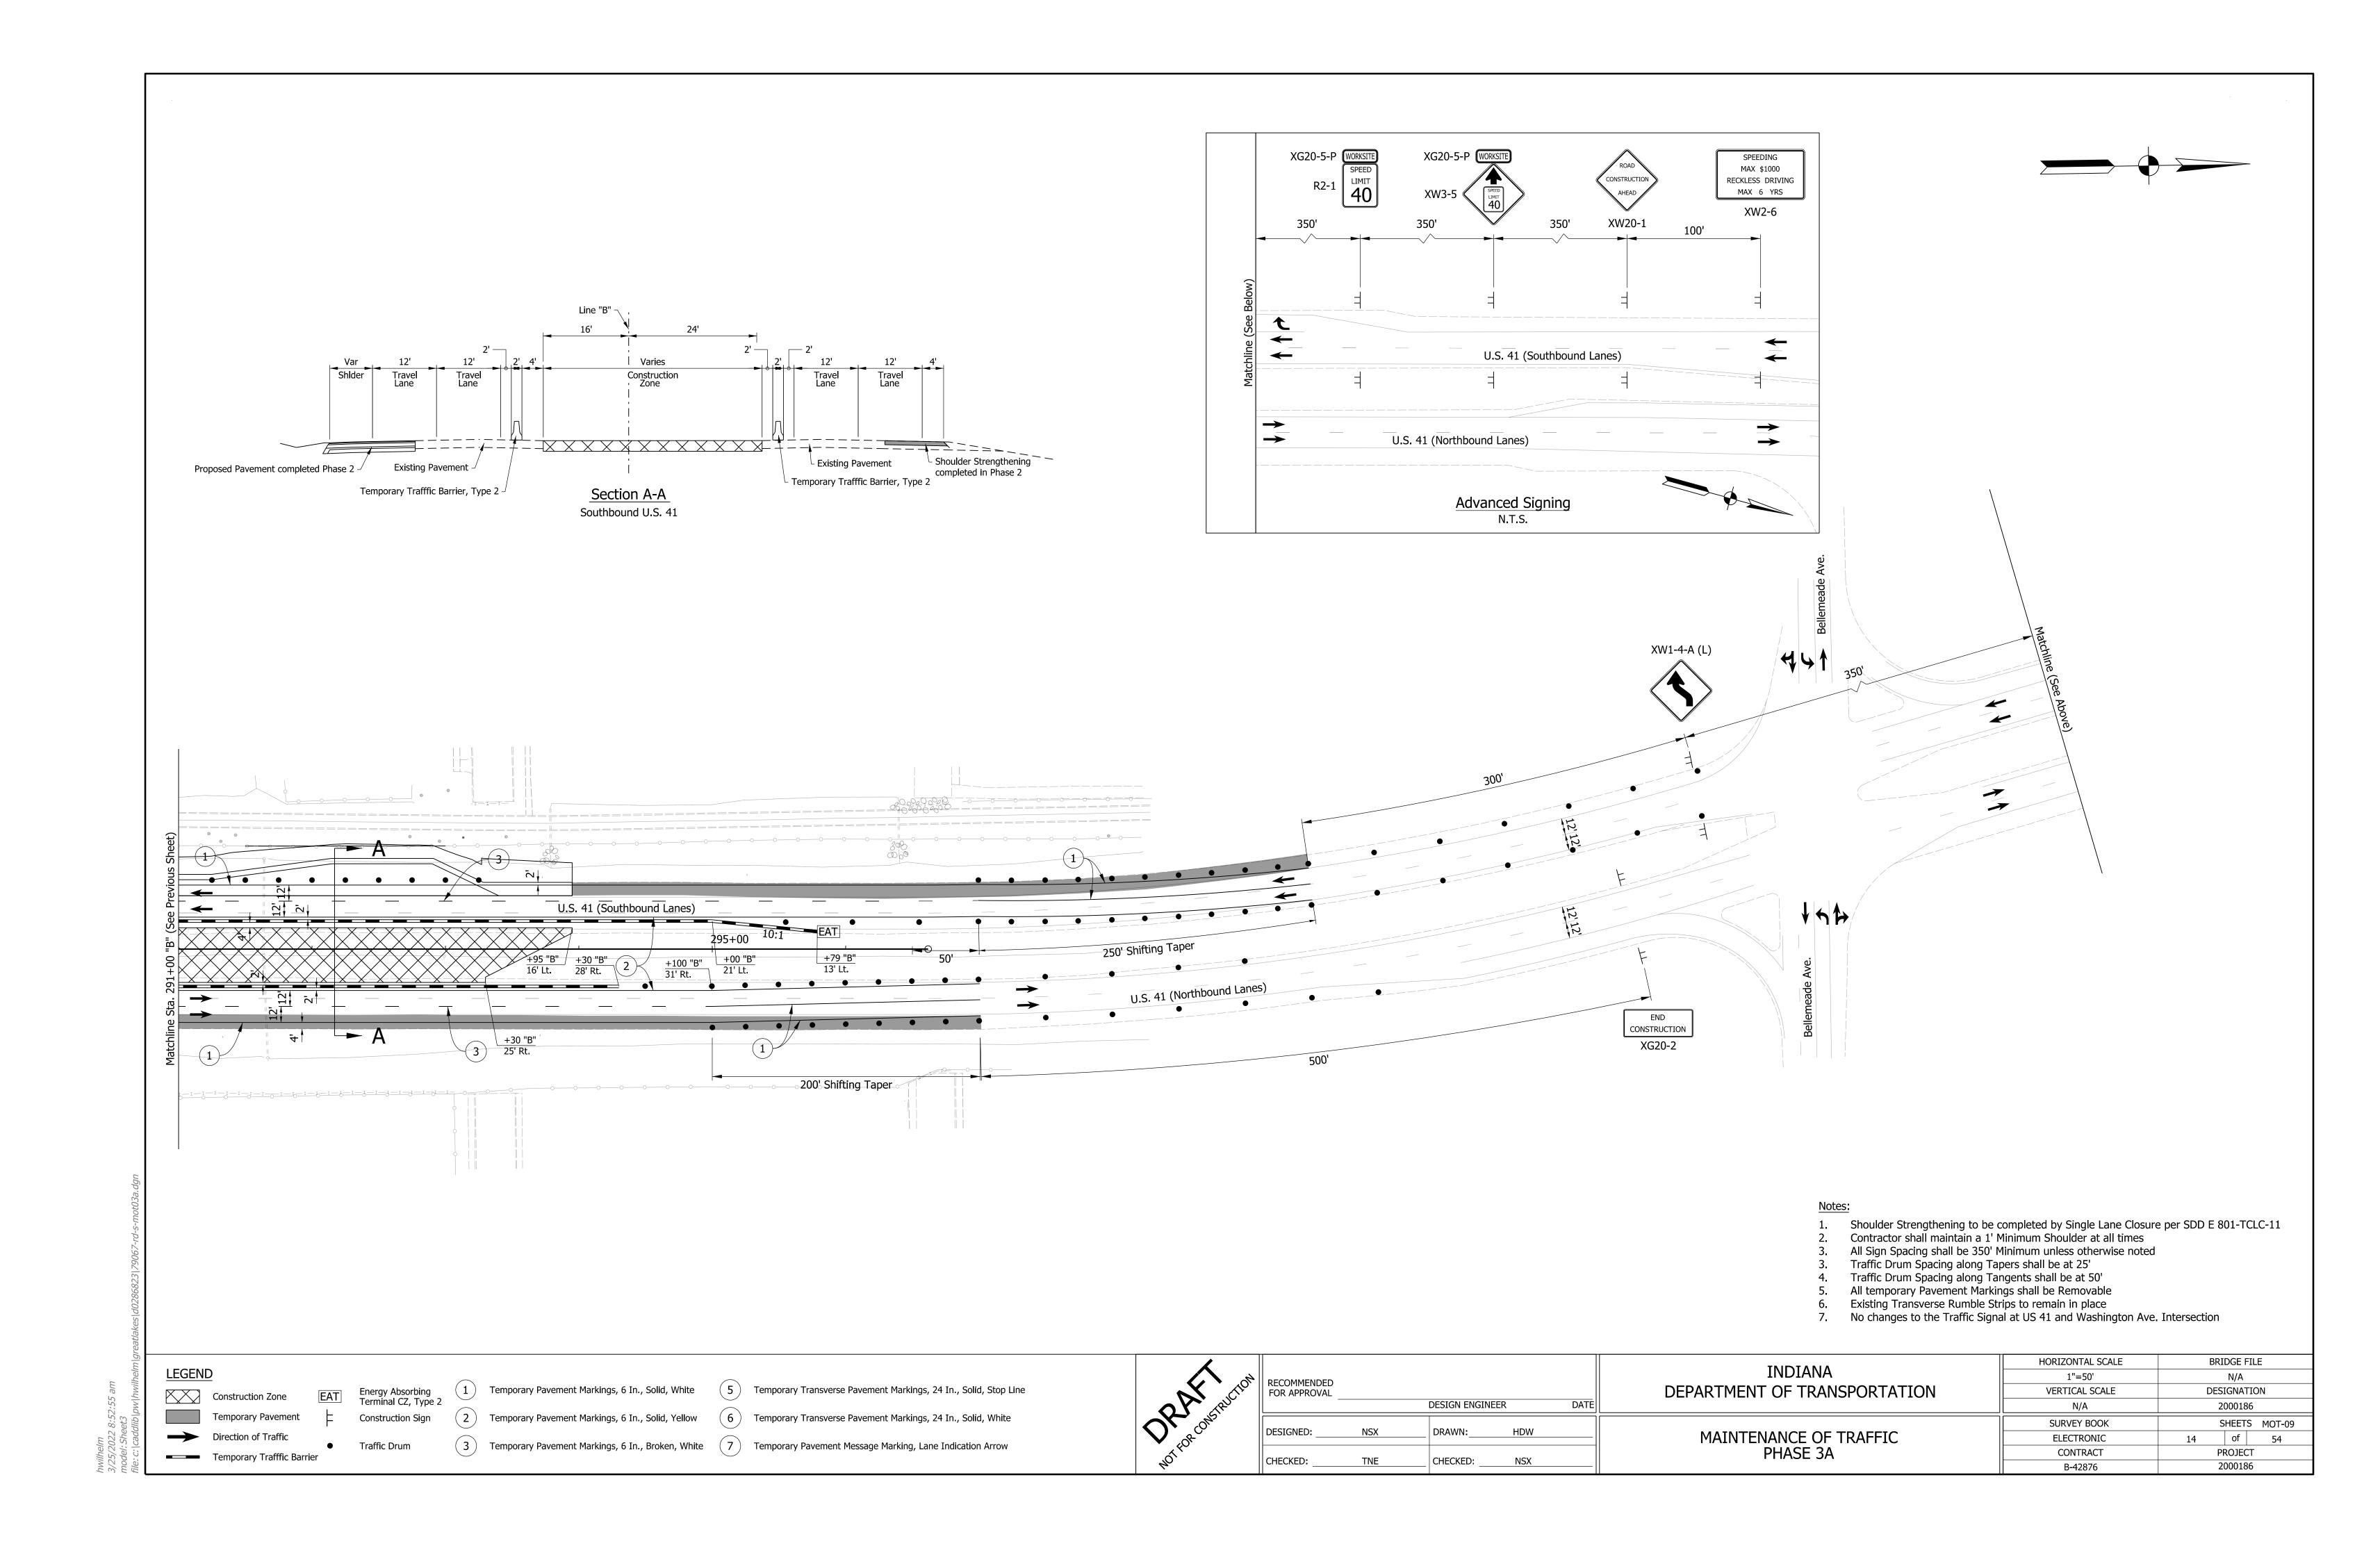
Construction Design Speed: 40 MPH

Construction Clear Zone: 13'-0"

Maintenance of Traffic Quantity Summary - Phase 3B				
Item	Amount	Unit		
Construction Sign A	4	EACH		
Construction Sign B	4	EACH		
Temporary Pavement Marking, Removable, 6 In.	2,877	LFT		
Temporary Traffic Barrier, Type 2	2,743	LFT		
Energy Absorbing Terminal, CZ, Type-2	2	EACH		



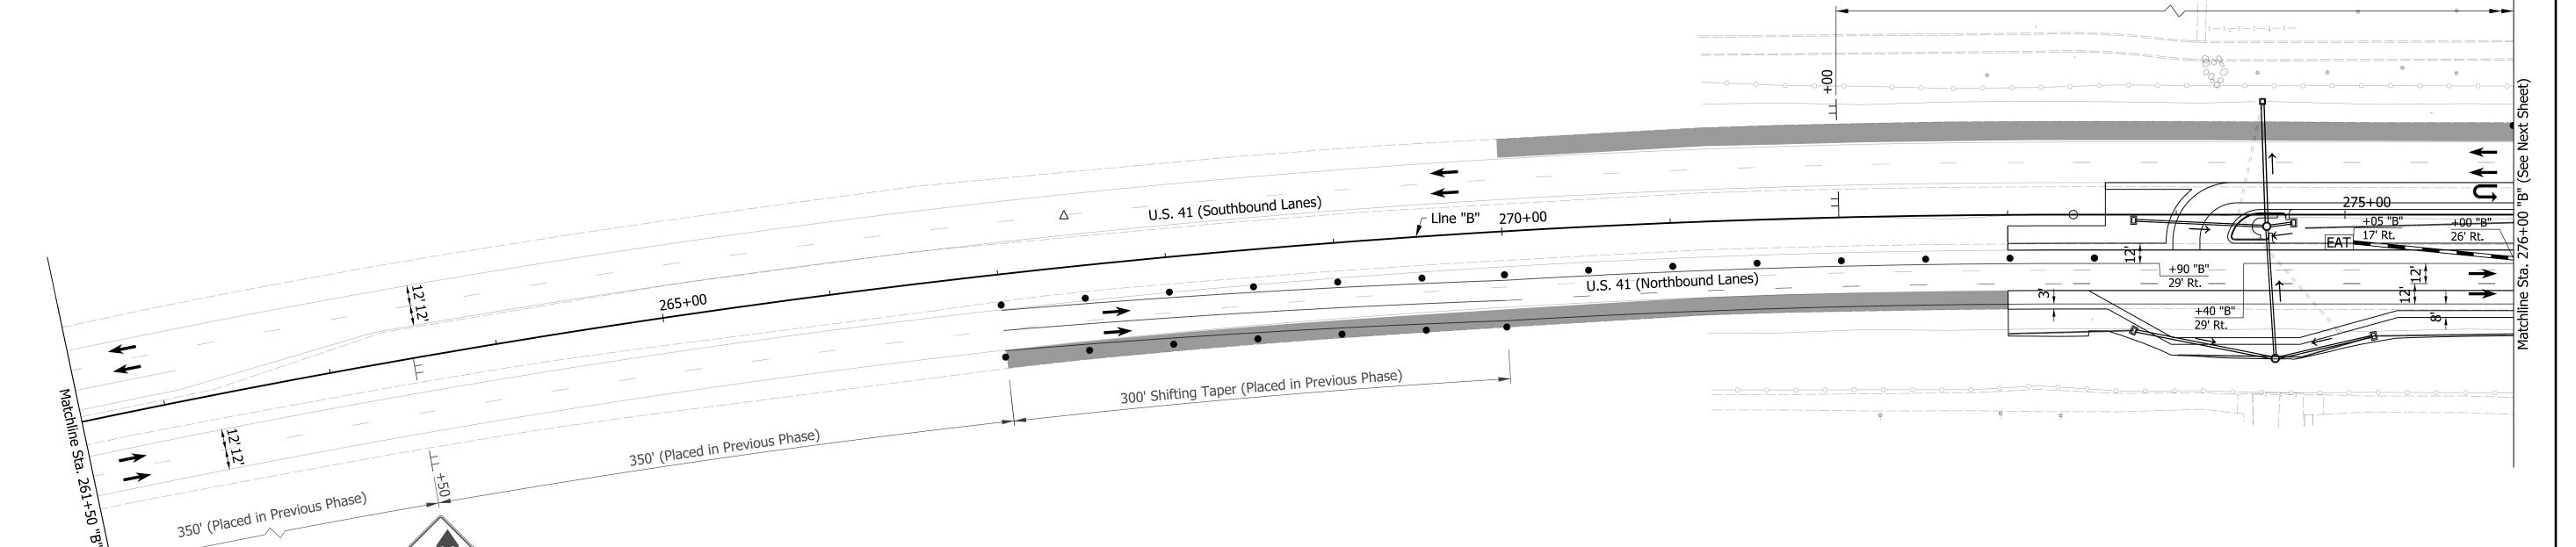

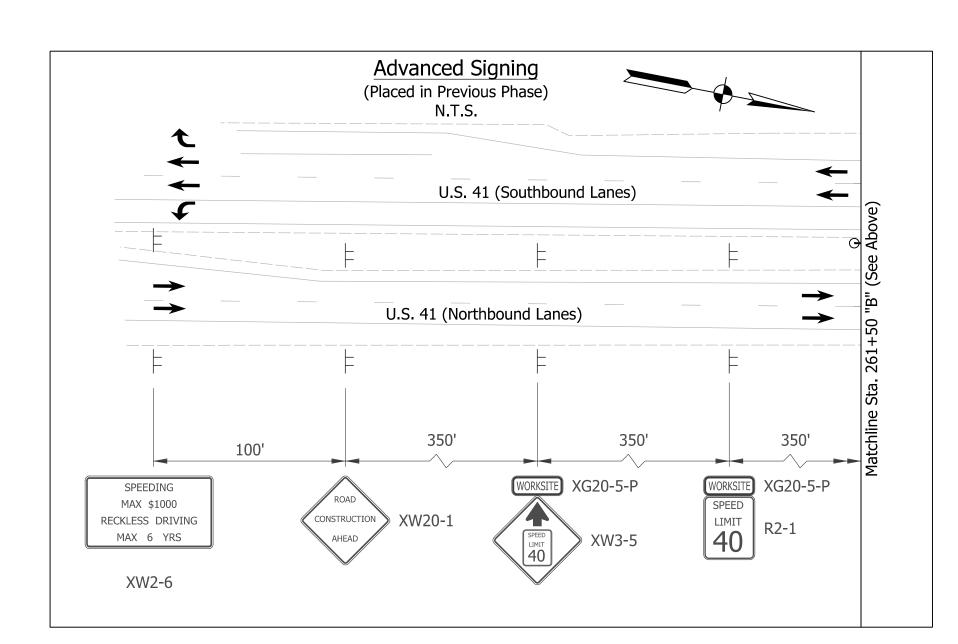

XG20-2

CONSTRUCTION

- Screened Pavement Markings and Signs were placed in Construction Phase 3A
 Contractor shall maintain a 2' Minimum Shoulder at all times
- All Sign Spacing shall be 350' Minimum unless otherwise noted
 Traffic Drum Spacing along Tapers shall be at 25'
 Traffic Drum Spacing along Tangents shall be at 50'
 All temporary Pavement Markings shall be Removable

- Existing Transverse Rumble Strips to remain in place No changes to the Traffic Signal at US 41 and Washington Ave. Intersection

LLGLINI	_	
	Construction Zone	E
	Temporary Pavement	
→	Direction of Traffic	
	Temporary Trafffic Barrie	er

LEGEND Energy Absorbing Terminal CZ, Type 2 rary Pavement Construction Sign

ig(1ig) Temporary Pavement Markings, 6 In., Solid, White


Temporary Pavement Markings, 6 In., Broken, White 7 Temporary Pavement Message Marking, Lane Indication Arrow

5 Temporary Transverse Pavement Markings, 24 In., Solid, Stop Line

(2) Temporary Pavement Markings, 6 In., Solid, Yellow (6) Temporary Transverse Pavement Markings, 24 In., Solid, White

RECOMMENDED FOR APPROVAL				
DESIGNED:	NSX	DRAWN: HDW		
CHECKED:	TNE	CHECKED: NSX		

INDIANA DEPARTMENT OF TRANSPORTATION	HORIZONTAL SCALE	BRIDGE FILE	
	1"=50'	N/A	
	VERTICAL SCALE	DESIGNATION	
	N/A	2000186	
MAINTENANCE OF TRAFFIC PHASE 3B	SURVEY BOOK	SHEETS MOT-10	
	ELECTRONIC	15 of 54	
	CONTRACT	PROJECT	
	B-42876	2000186	

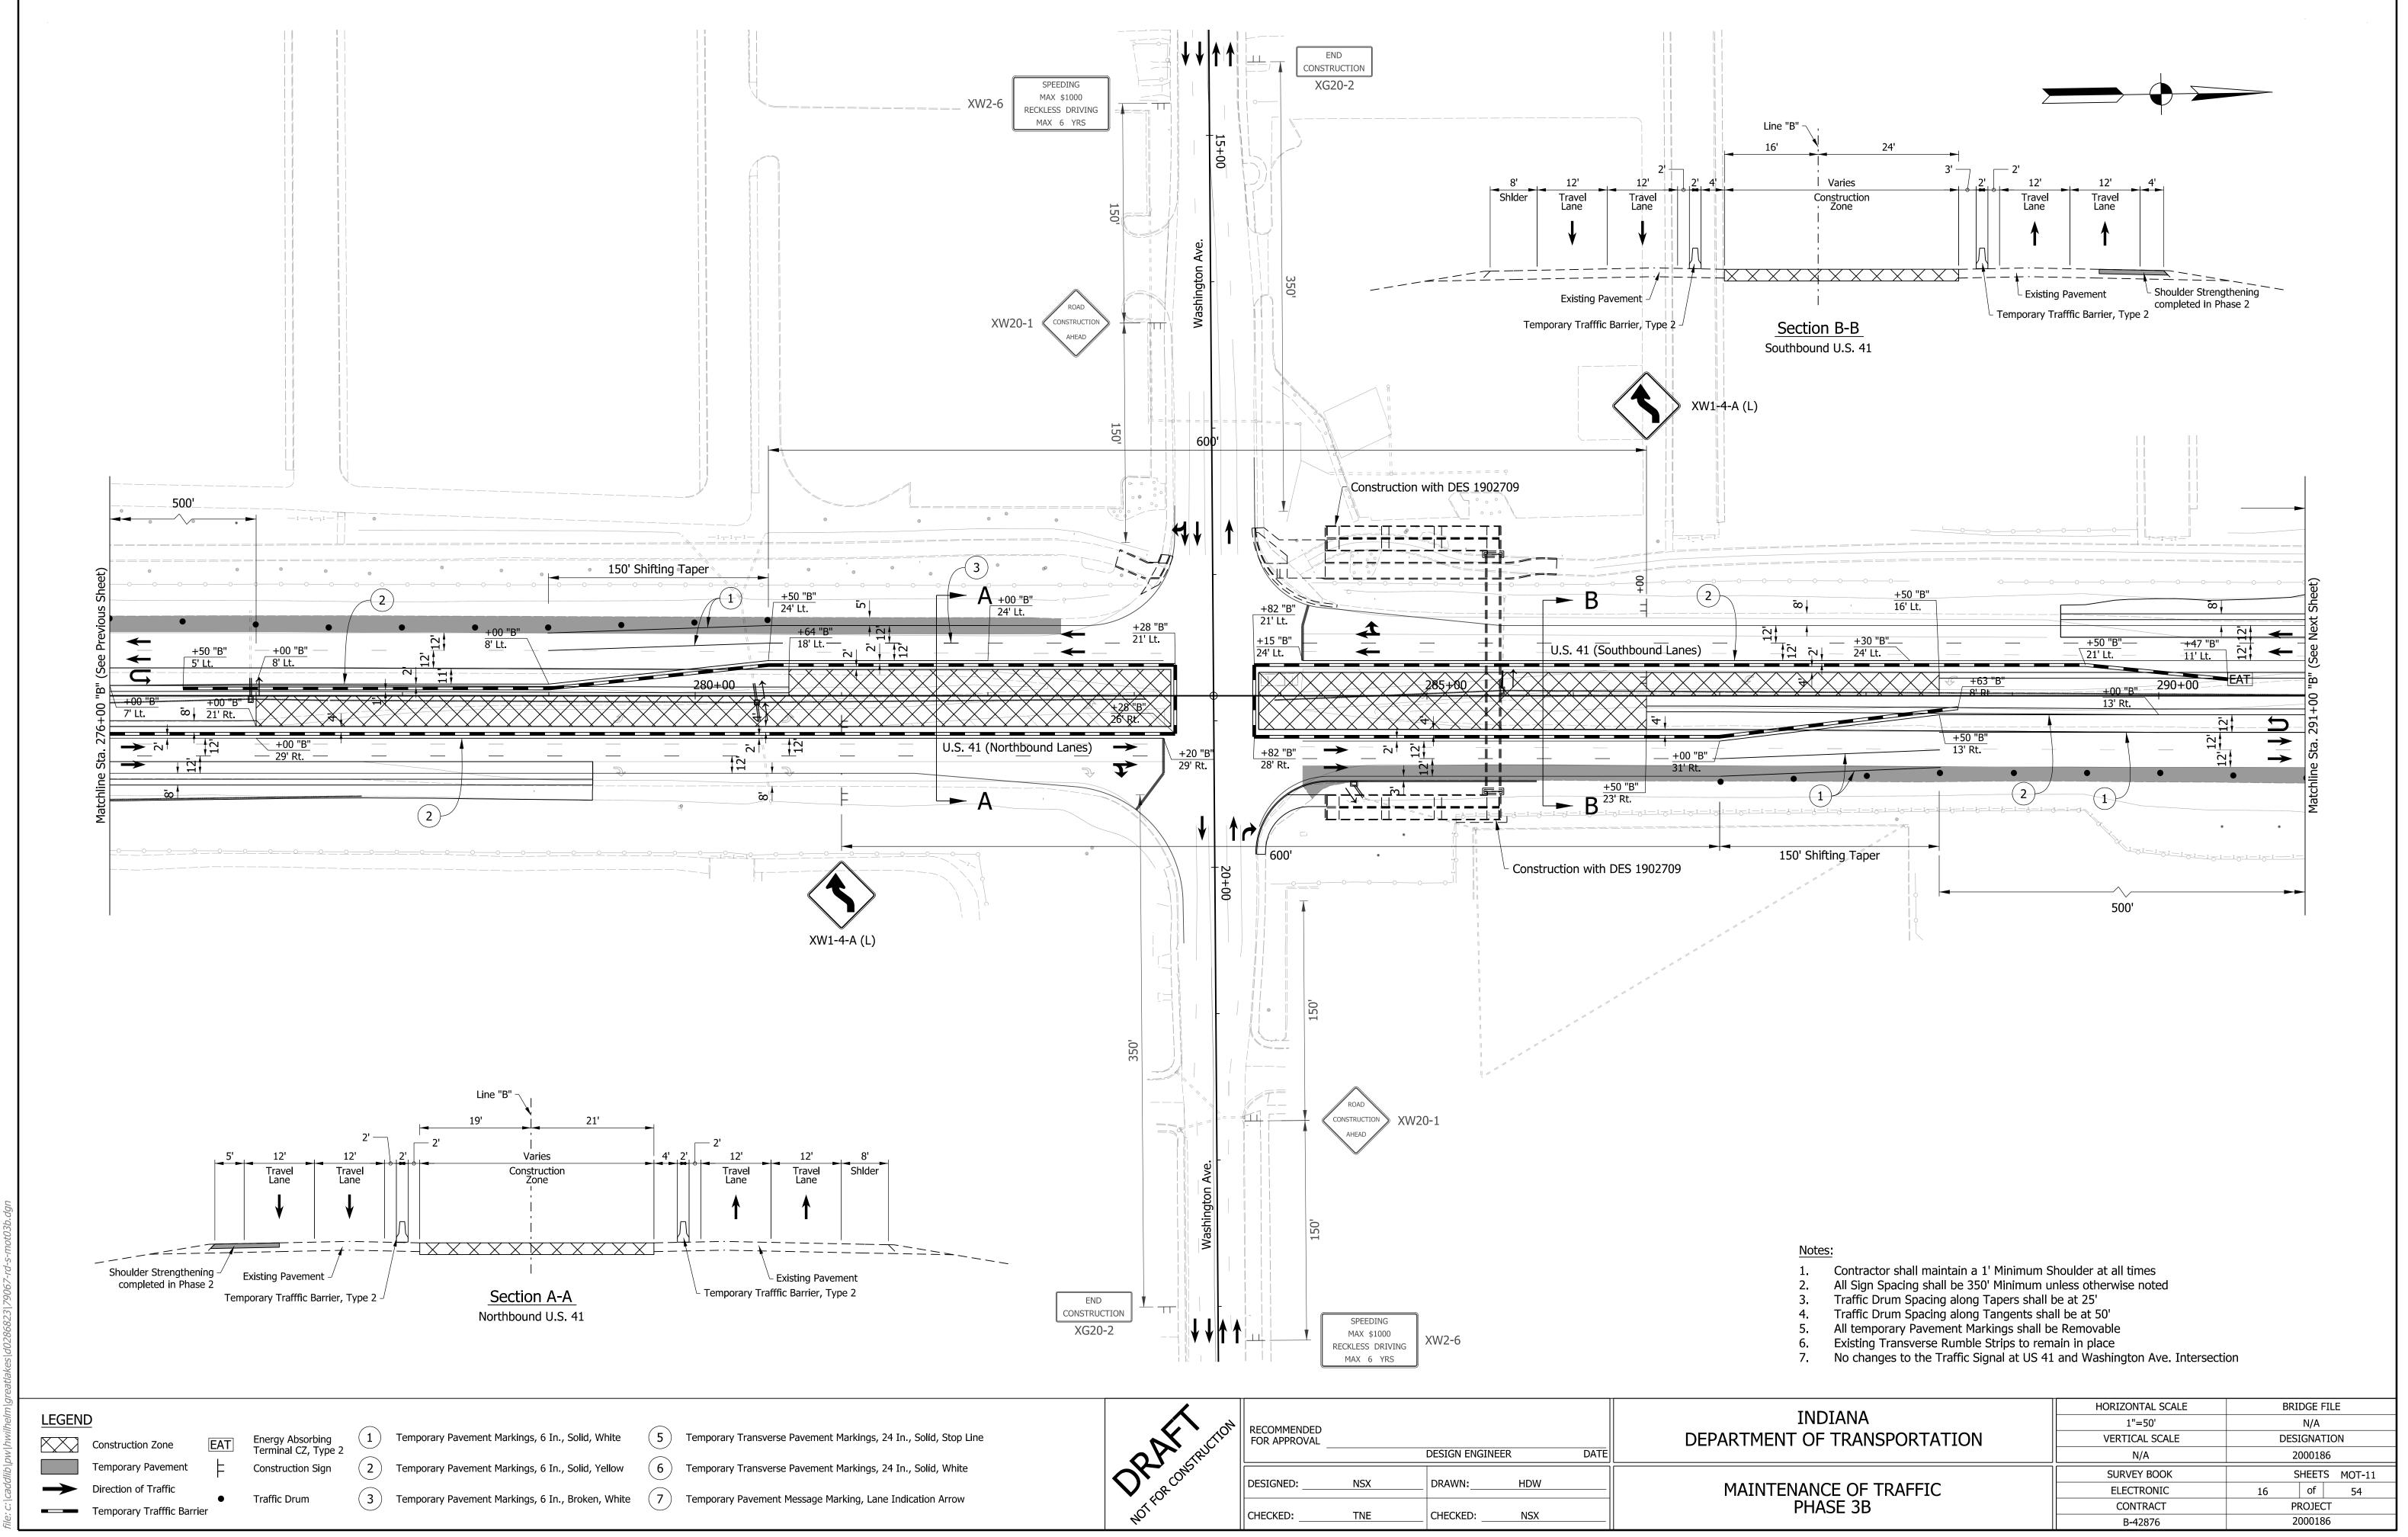

3/25/2022 8:53:06 am model: Sheet2

