


PROJECT	DESIGNATION
2001828	2001828
CONTRACT	BRIDGE FILE
R-43449	N/A

# INDIANA DEPARTMENT OF TRANSPORTATION

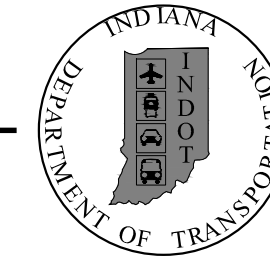


## ROAD PLANS SR 18 & SR 43 PAVEMENT REPLACEMENT


PROJECT NO. 2001828 P.E.  
PROJECT NO. 2001828 R/W  
PROJECT NO. 2001828 CONST.

PAVEMENT REPLACEMENT ON SR 18 & SR 43 FROM 0.57 MILES NORTH OF SR 18 SOUTH JUNCTION (RP 35+05) (MOOTS CREEK BRIDGE) TO SR 18 SOUTH JUNCTION (RP 35+35), LOCATED IN SECTIONS 21 & 22, TOWNSHIP 258 NORTH, RANGE 4 WEST IN PRAIRIE TOWNSHIP, TOWN BROOKSTON, WHITE COUNTY, INDIANA


Gross Length: 0.774 MI.  
Net Length: 0.774 MI.  
Maximum Grade: 2.48%

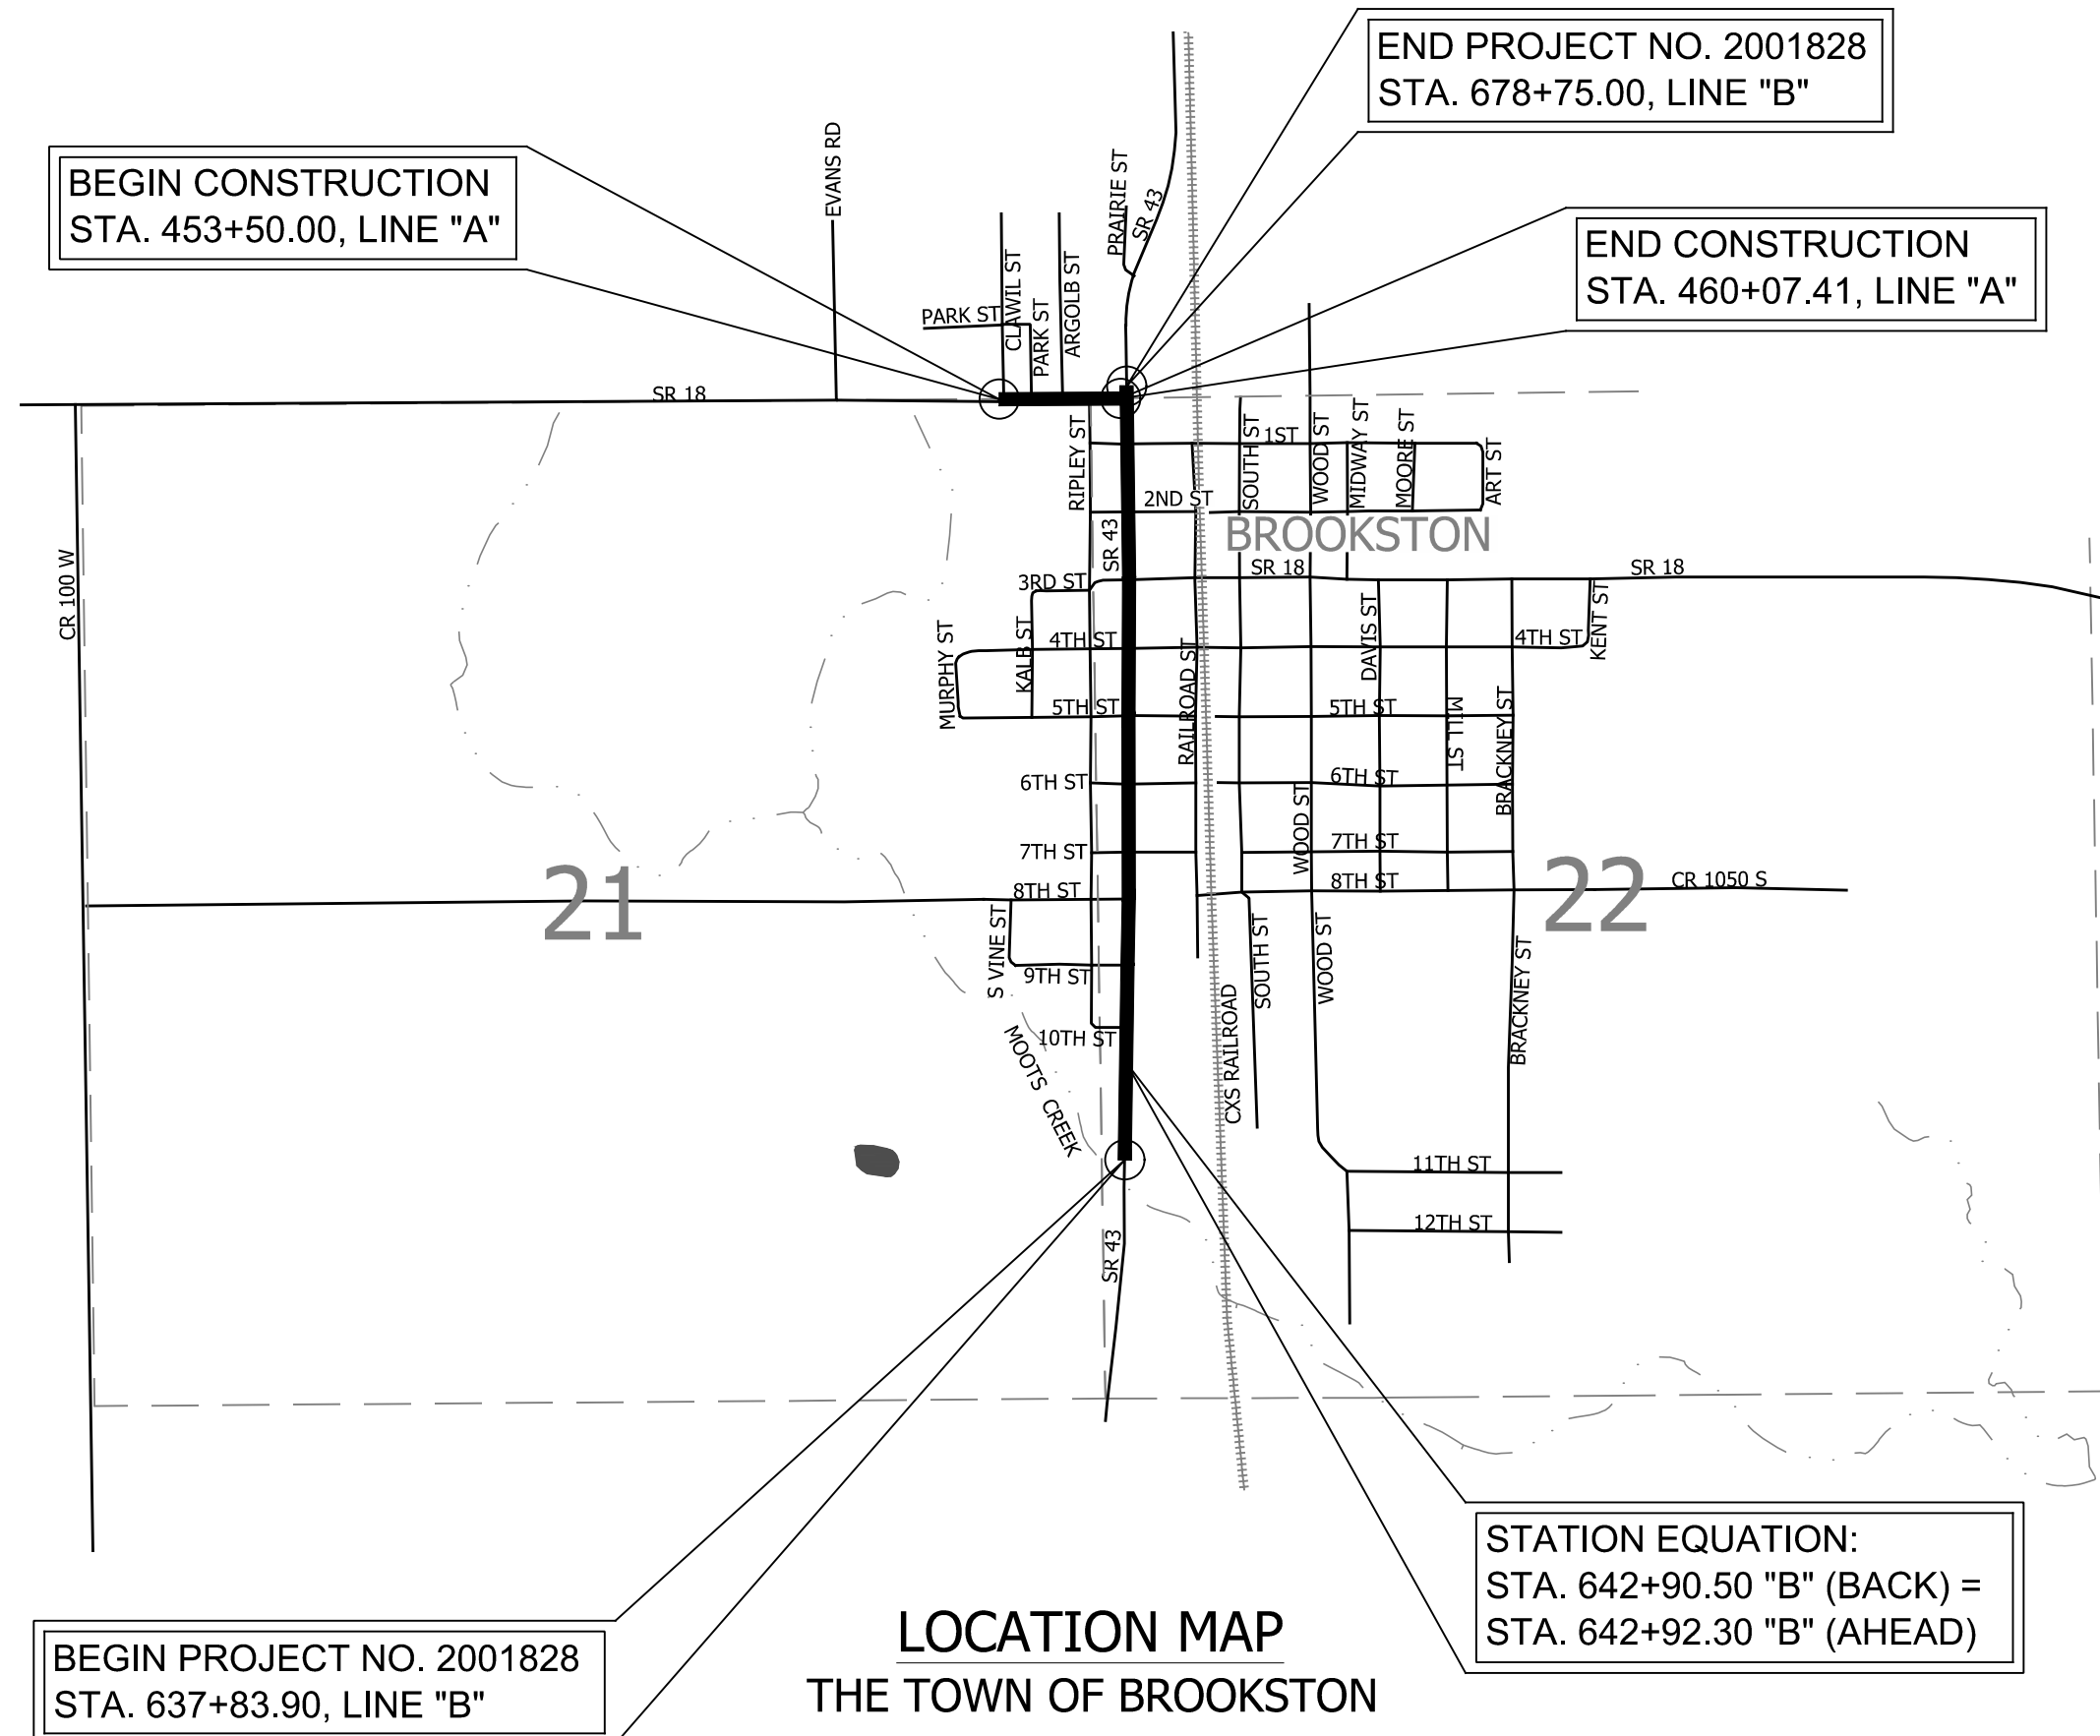

LOCATION MAP  
THE TOWN OF BROOKSTON

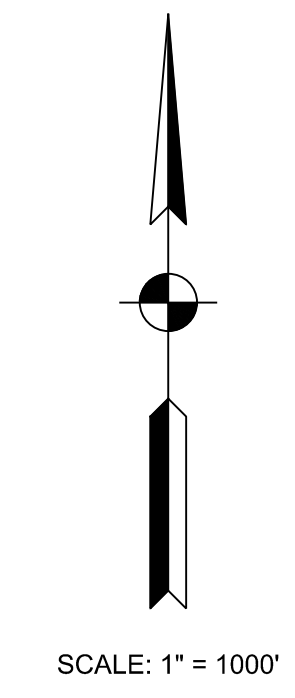

TRAFFIC DATA	
SR18	
A.A.D.T. (2025)	1861 V.P.D.
A.A.D.T. (2045)	1861 V.P.D.
D.H.V (2045)	185 V.P.H.
DIRECTIONAL DISTRIBUTION	49.9 % (POS)
TRUCKS	17.9 % A.A.D.T. 9.2 % D.H.V.
SR43	
A.A.D.T. (2025)	7329 V.P.D.
A.A.D.T. (2045)	7433 V.P.D.
D.H.V (2045)	788 V.P.H.
DIRECTIONAL DISTRIBUTION	50.6 % (POS)
TRUCKS	12.0 % A.A.D.T. 5.8 % D.H.V.
DESIGN DATA - SR 18	
DESIGN SPEED	35 M.P.H.
PROJECT DESIGN CRITERIA	RECONSTRUCTION (NON-FREEWAY)
FUNCTIONAL CLASSIFICATION (SR 18)	MAJOR COLLECTOR
RURAL/URBAN	URBAN (INTERMEDIATE)
TERRAIN	LEVEL
ACCESS CONTROL	NONE
DESIGN DATA - SR 43	
DESIGN SPEED	30 - 35 M.P.H.
PROJECT DESIGN CRITERIA	RECONSTRUCTION (NON-FREEWAY)
FUNCTIONAL CLASSIFICATION (SR 43)	PRINCIPAL ARTERIAL
RURAL/URBAN	URBAN (INTERMEDIATE)
TERRAIN	LEVEL
ACCESS CONTROL	NONE

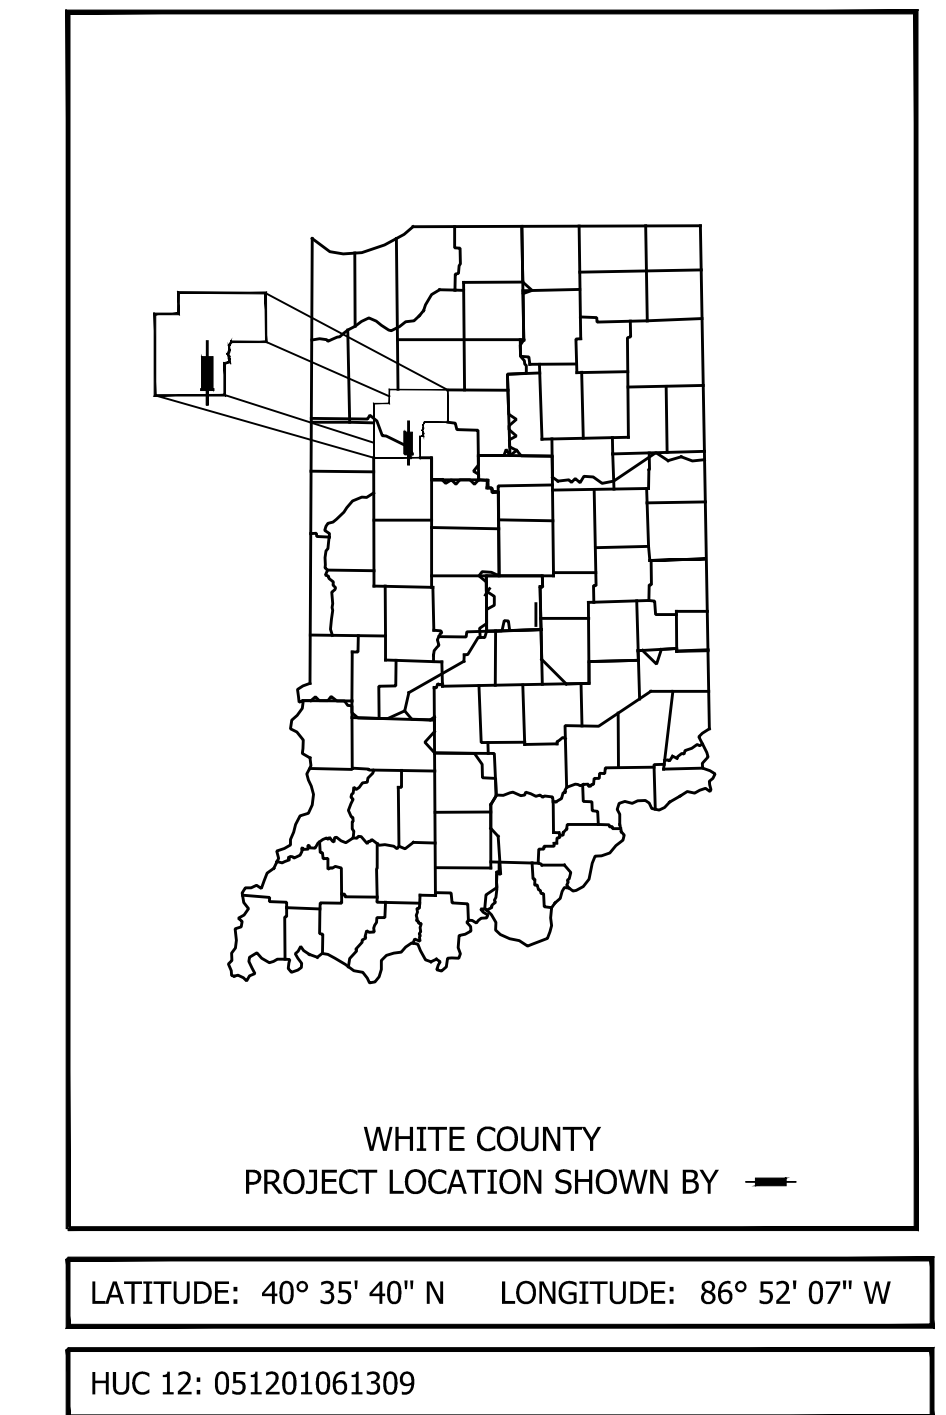

**STAGE 2 PLANS**  
**FEBRUARY 24, 2023**

INDIANA DEPARTMENT OF TRANSPORTATION  
STANDARD SPECIFICATIONS DATED 2022  
TO BE USED WITH THESE PLANS.







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8770 NORTH ST., STE. 110  
FISHERS, IN 46038  
P: 317.588.1798  
F: 317.588.1799  
WWW.RQAW.COM

PLANS PREPARED BY:	RQAW Corporation	317-588-1798
		PHONE NUMBER
CERTIFIED BY:		DATE
APPROVED FOR LETTING:	INDIANA DEPARTMENT OF TRANSPORTATION	DATE

SURVEY BOOK	SHEET
CONTRACT	1 of 117
R-43449	PROJECT
	2001828



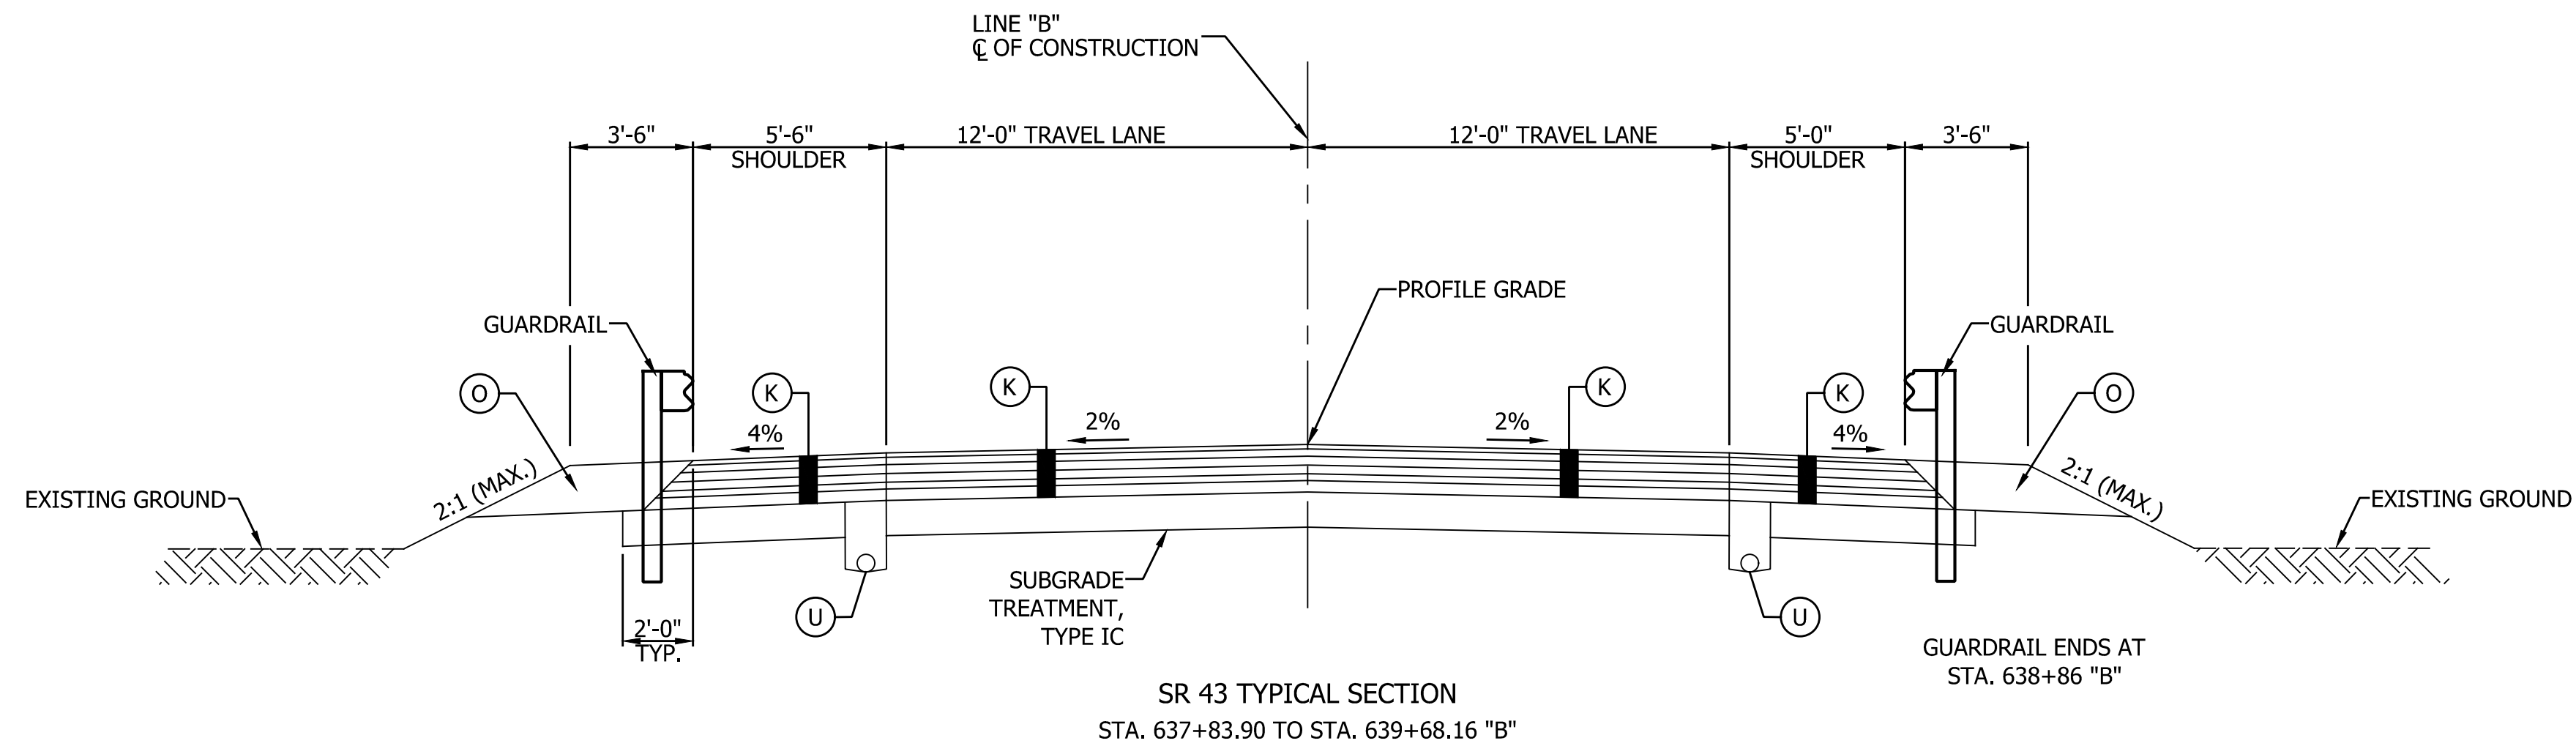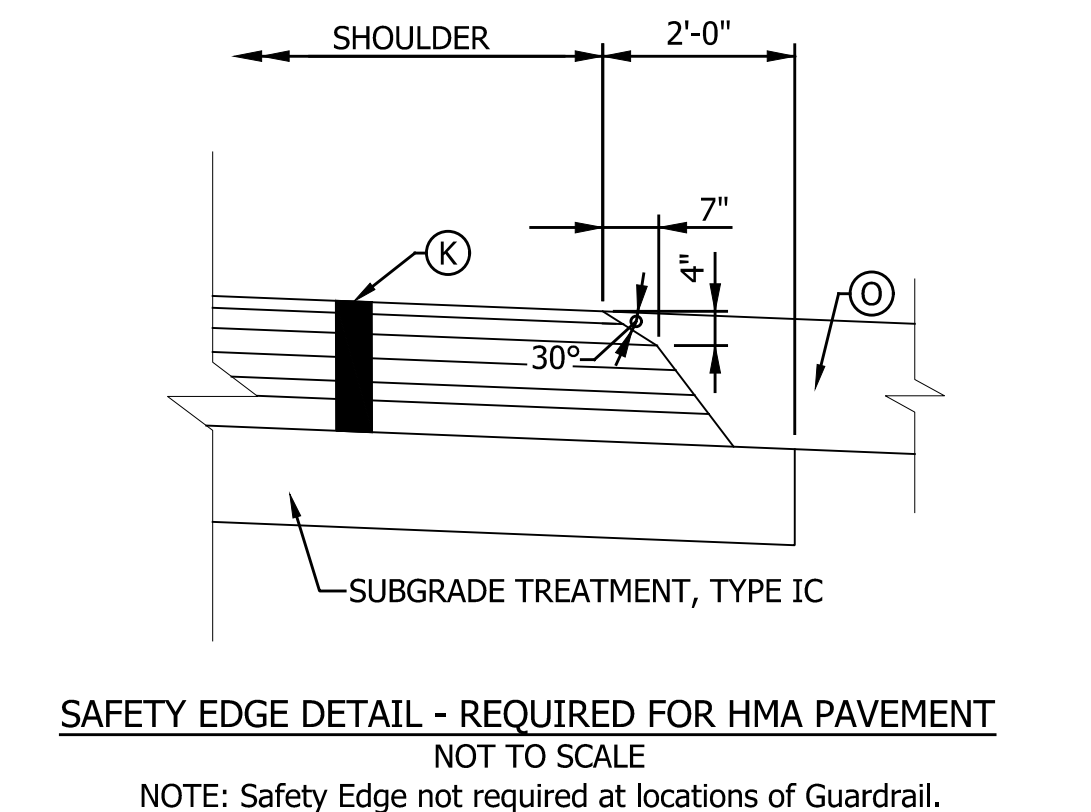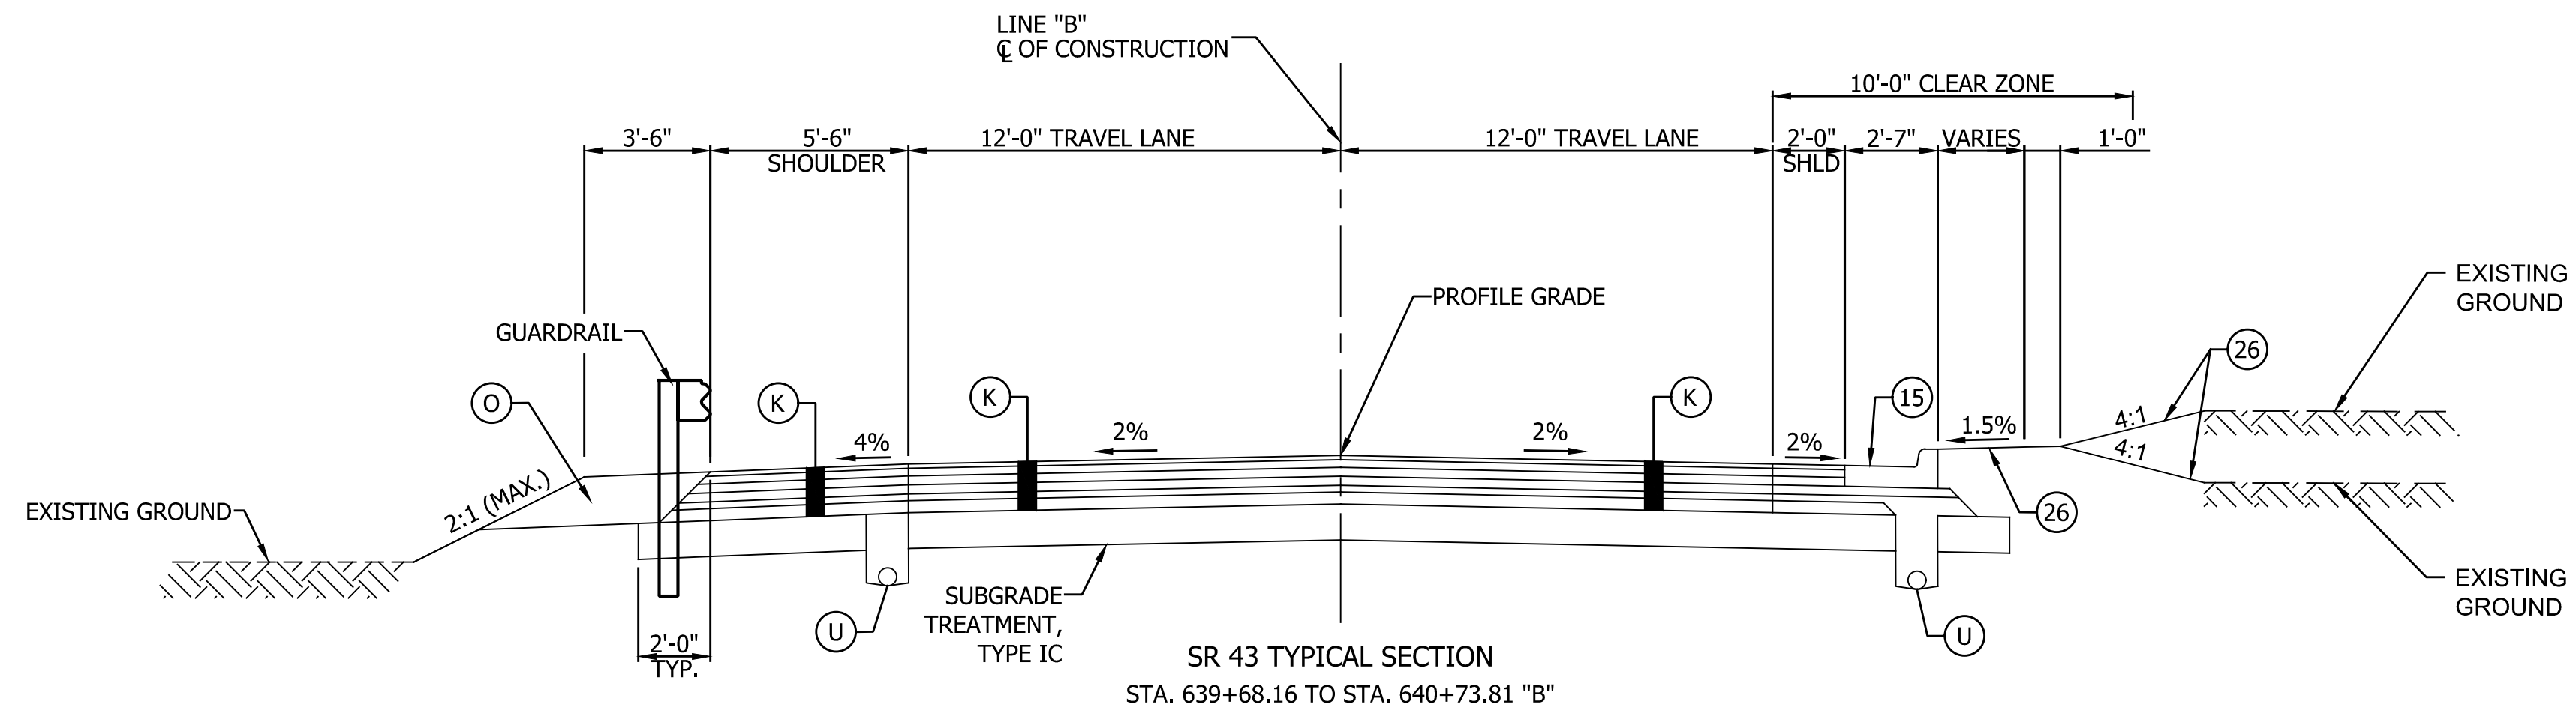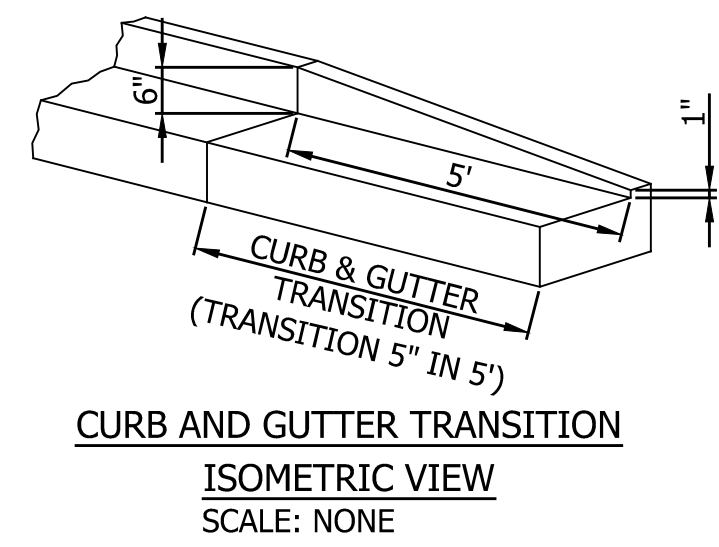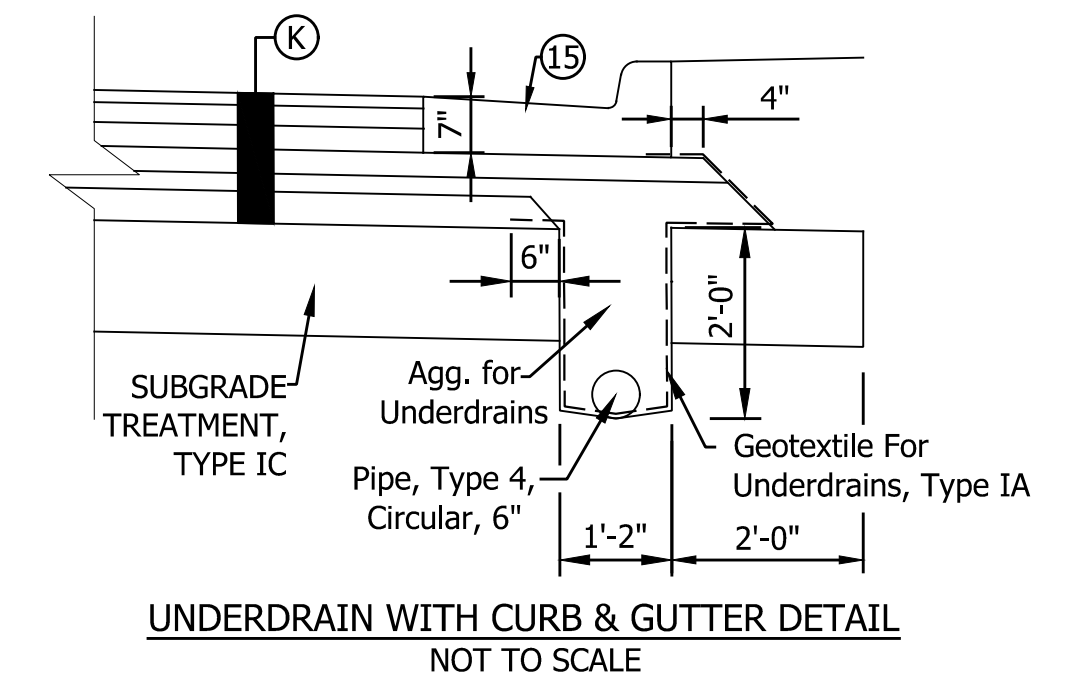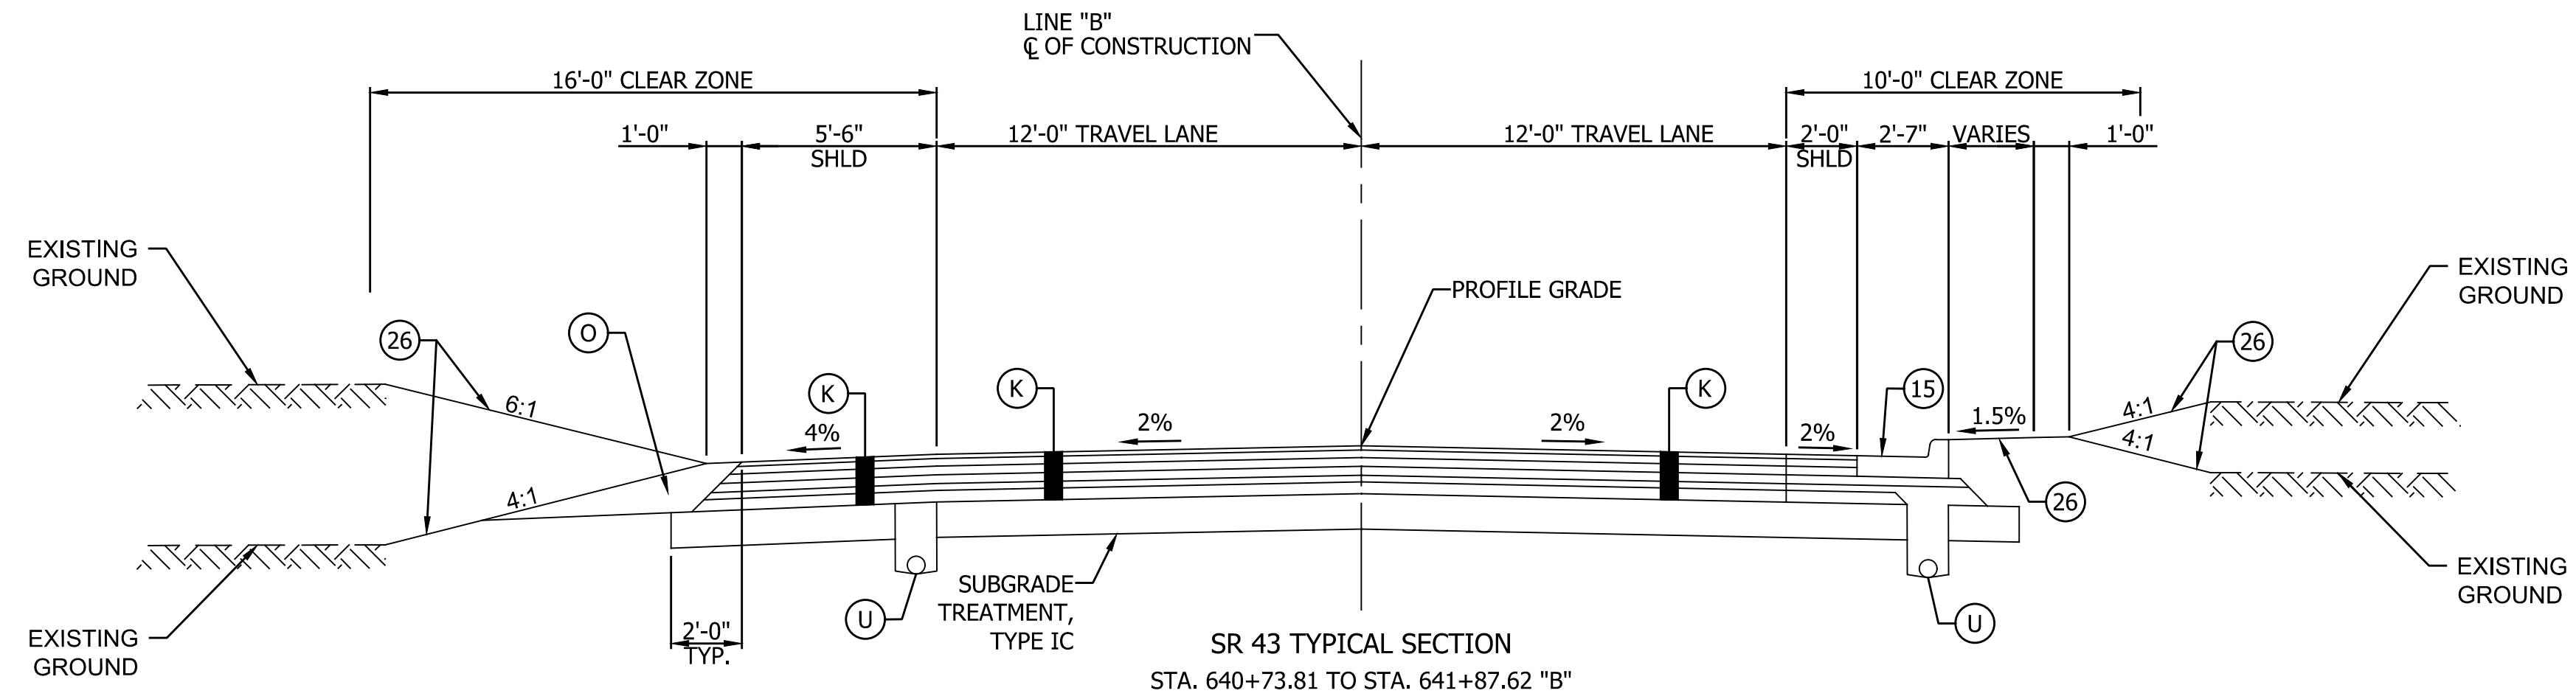

**NOTES:**

- Tack Coat to be placed between all HMA layers.
- Joint Adhesive to be installed at all joints in the surface and intermediate layers.
- Liquid Asphalt Sealant to be placed centered on all joints.

LEGEND			
(F)	Concrete Sidewalk, 4"	(W)	Widening with HMA, Type C
(K)	165 lb/SYS QC/QA HMA, 3, 70, Surface 9.5 mm on 275 lb/SYS QC/QA HMA, 3, 70, Intermediate 19.0 mm on 660 lb/SYS QC/QA HMA, 3, 64, Base 19.0 mm (2 Lifts) on 6\"/>		
(O)	Compacted Aggregate, No. 53	(14)	Mod. Concrete Rolled Curb (Sloping)
(R)	Milling, Asphalt 1.5\"/>		
(U)	26)	(15)	Combined Concrete Curb & Gutter
		(16)	Curb, Concrete (Vertical)
		(26)	Sodding, Nursery


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CHECKED: DCK	CHECKED: DCK	

INDIANA DEPARTMENT OF TRANSPORTATION	
TYPICAL CROSS SECTIONS SR 43	


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VERTICAL SCALE	DESIGNATION
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SURVEY BOOK	SHEET
	3 of 117
CONTRACT	PROJECT
R-43449	2001828

PRINT DATE: 4/9/23 PLOT SCALE: 1:1 EDIT DATE: 7/12/11 - 7:18 AM EDITED BY: RWILSON DRAWING FILE: P:\21-500-155-1 WHITE CO PAVEMENT REPLACEMENT 210108'S ACAD\03 TYPICALS\TYPICALS.DWG




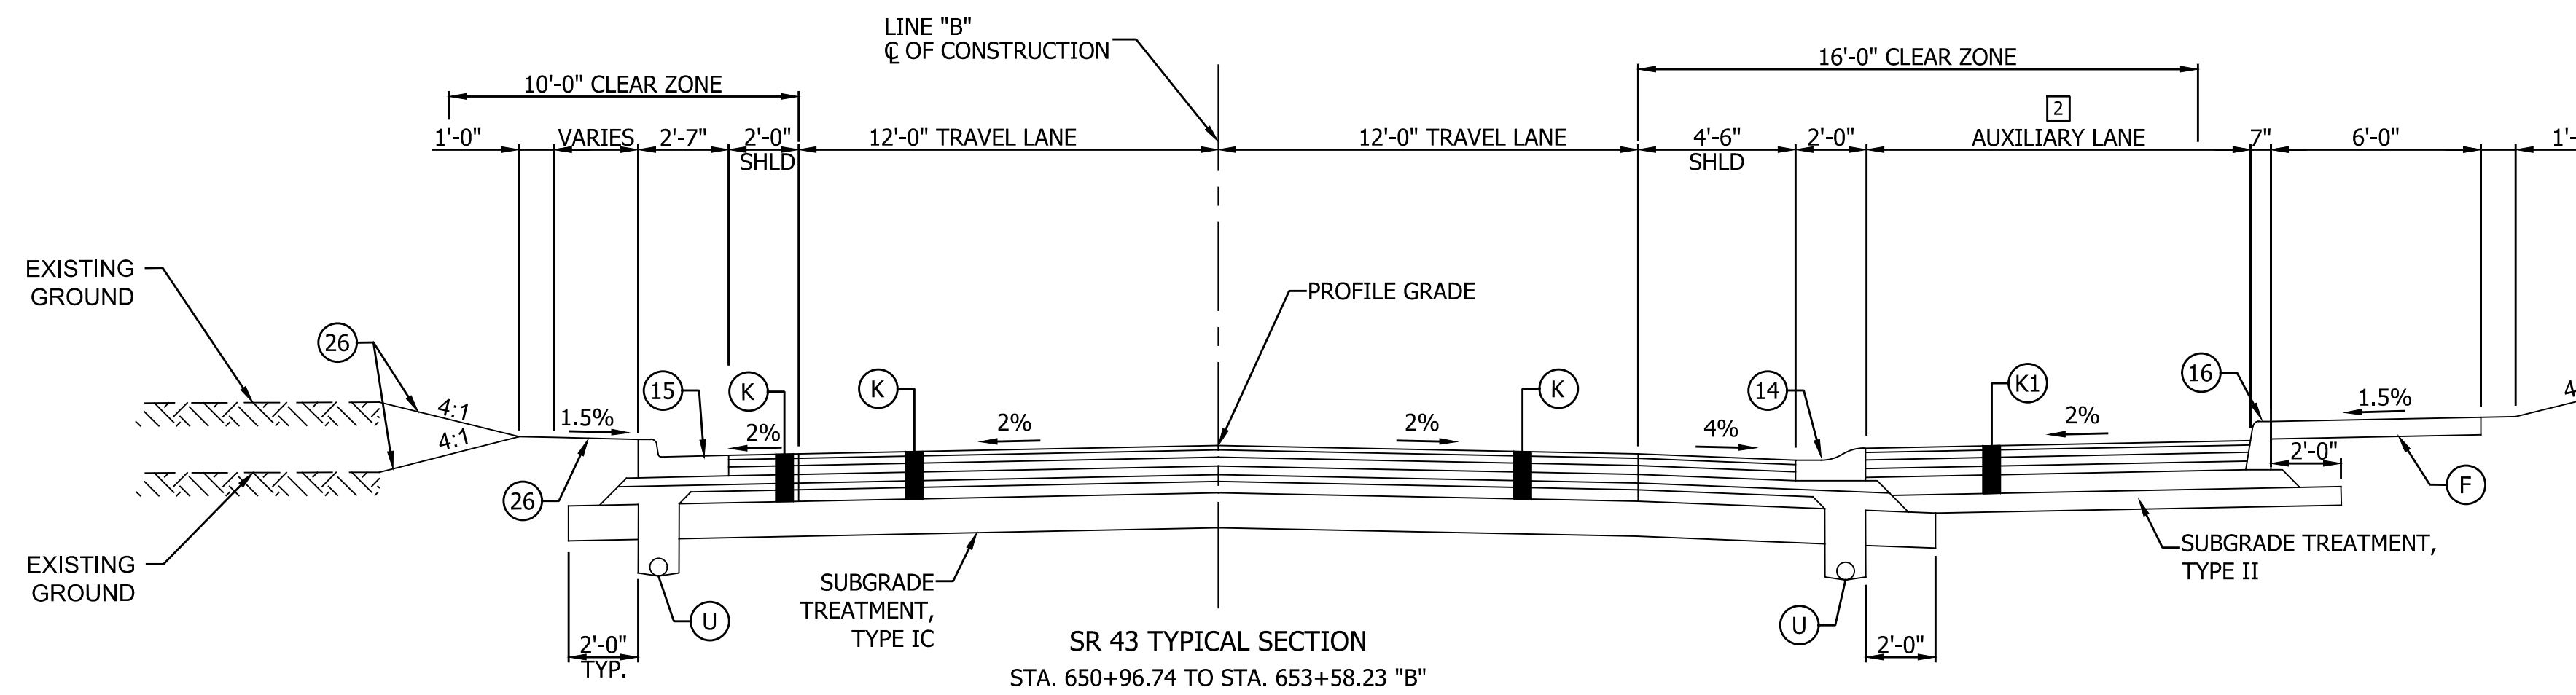


2 VARIES FROM 0'-0" AT STA. 650+96.74 TO 11'-0" AT STA. 651+21.00  
 11'-0" FROM STA. 651+21.00 TO STA. 653+34.62  
 VARIES FROM 11'-0" AT STA. 653+34.62 TO 0'-0" AT STA. 653+58.23

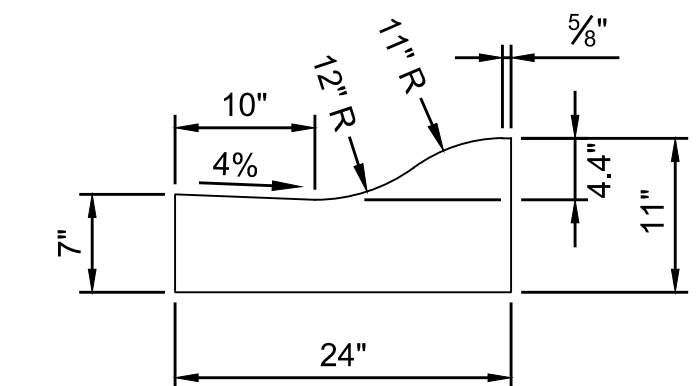

MODIFIED CONCRETE ROLLED CURB (SLOPING)  
 SCALE: NONE

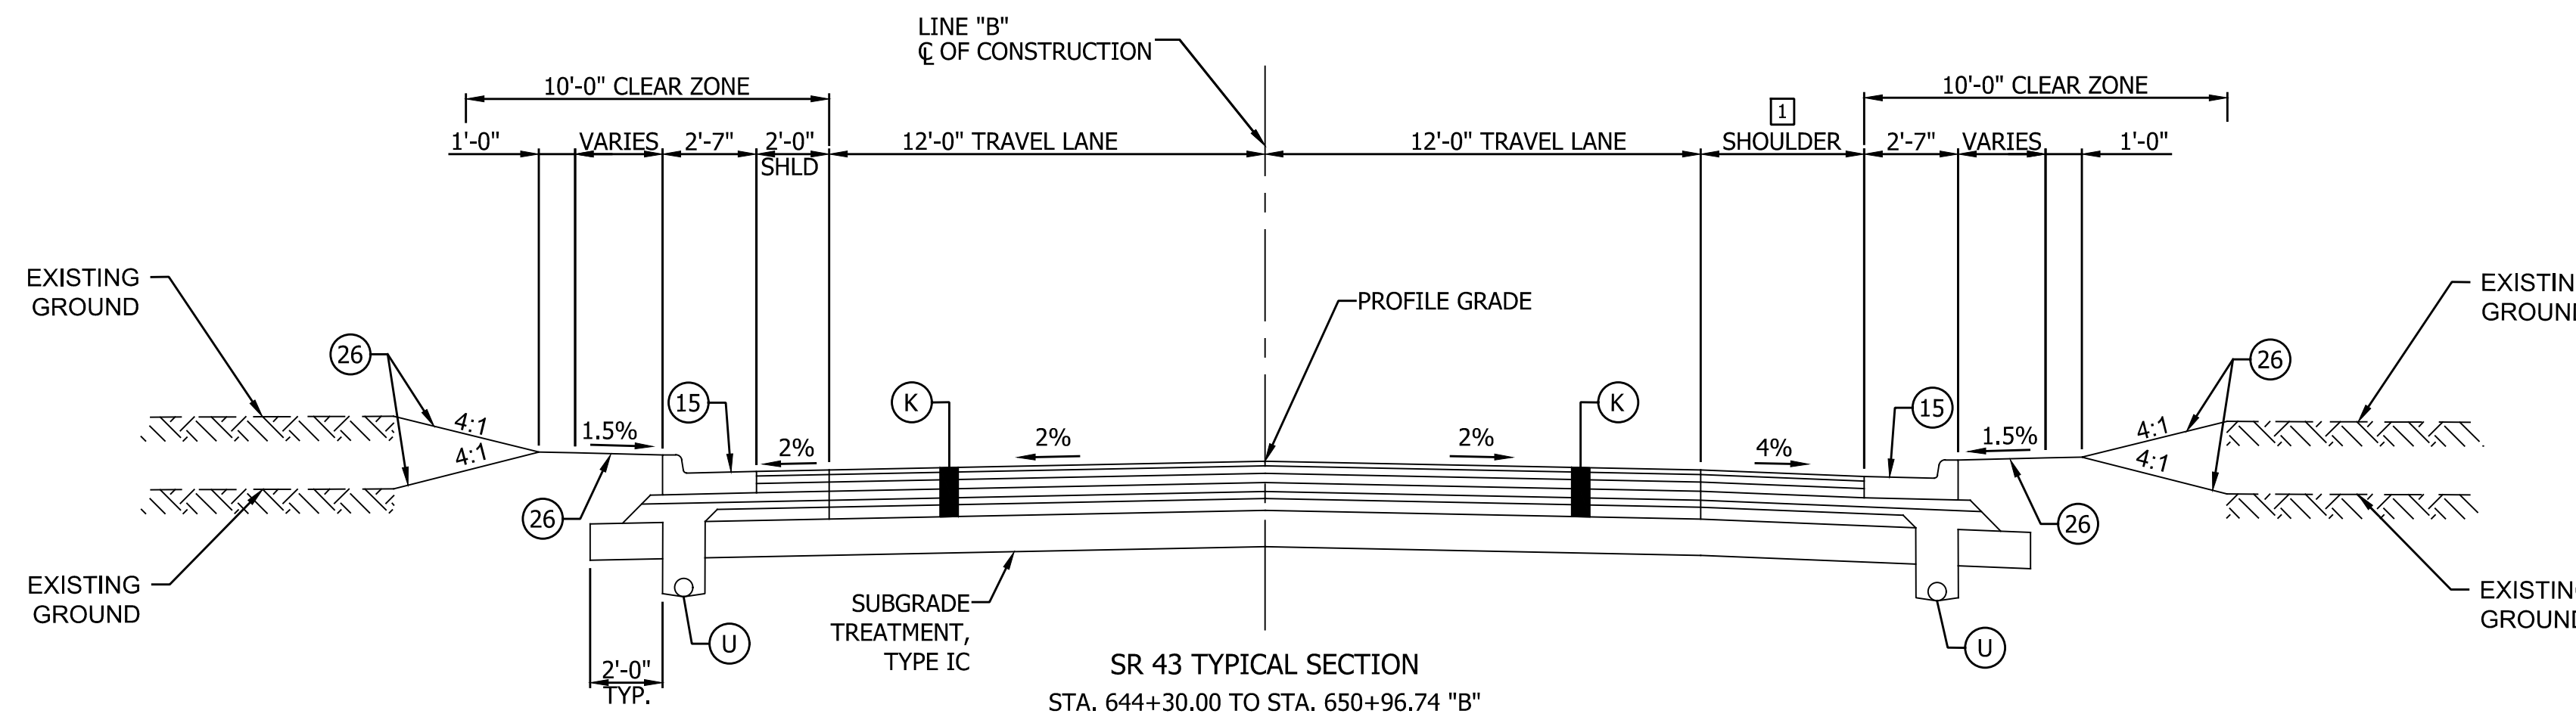

1 VARIES FROM 2'-0" AT STA. 644+30.00 TO 4'-6" AT STA. 644+80.00  
 4'-6" FROM STA. 644+80.00 TO STA. 650+96.74

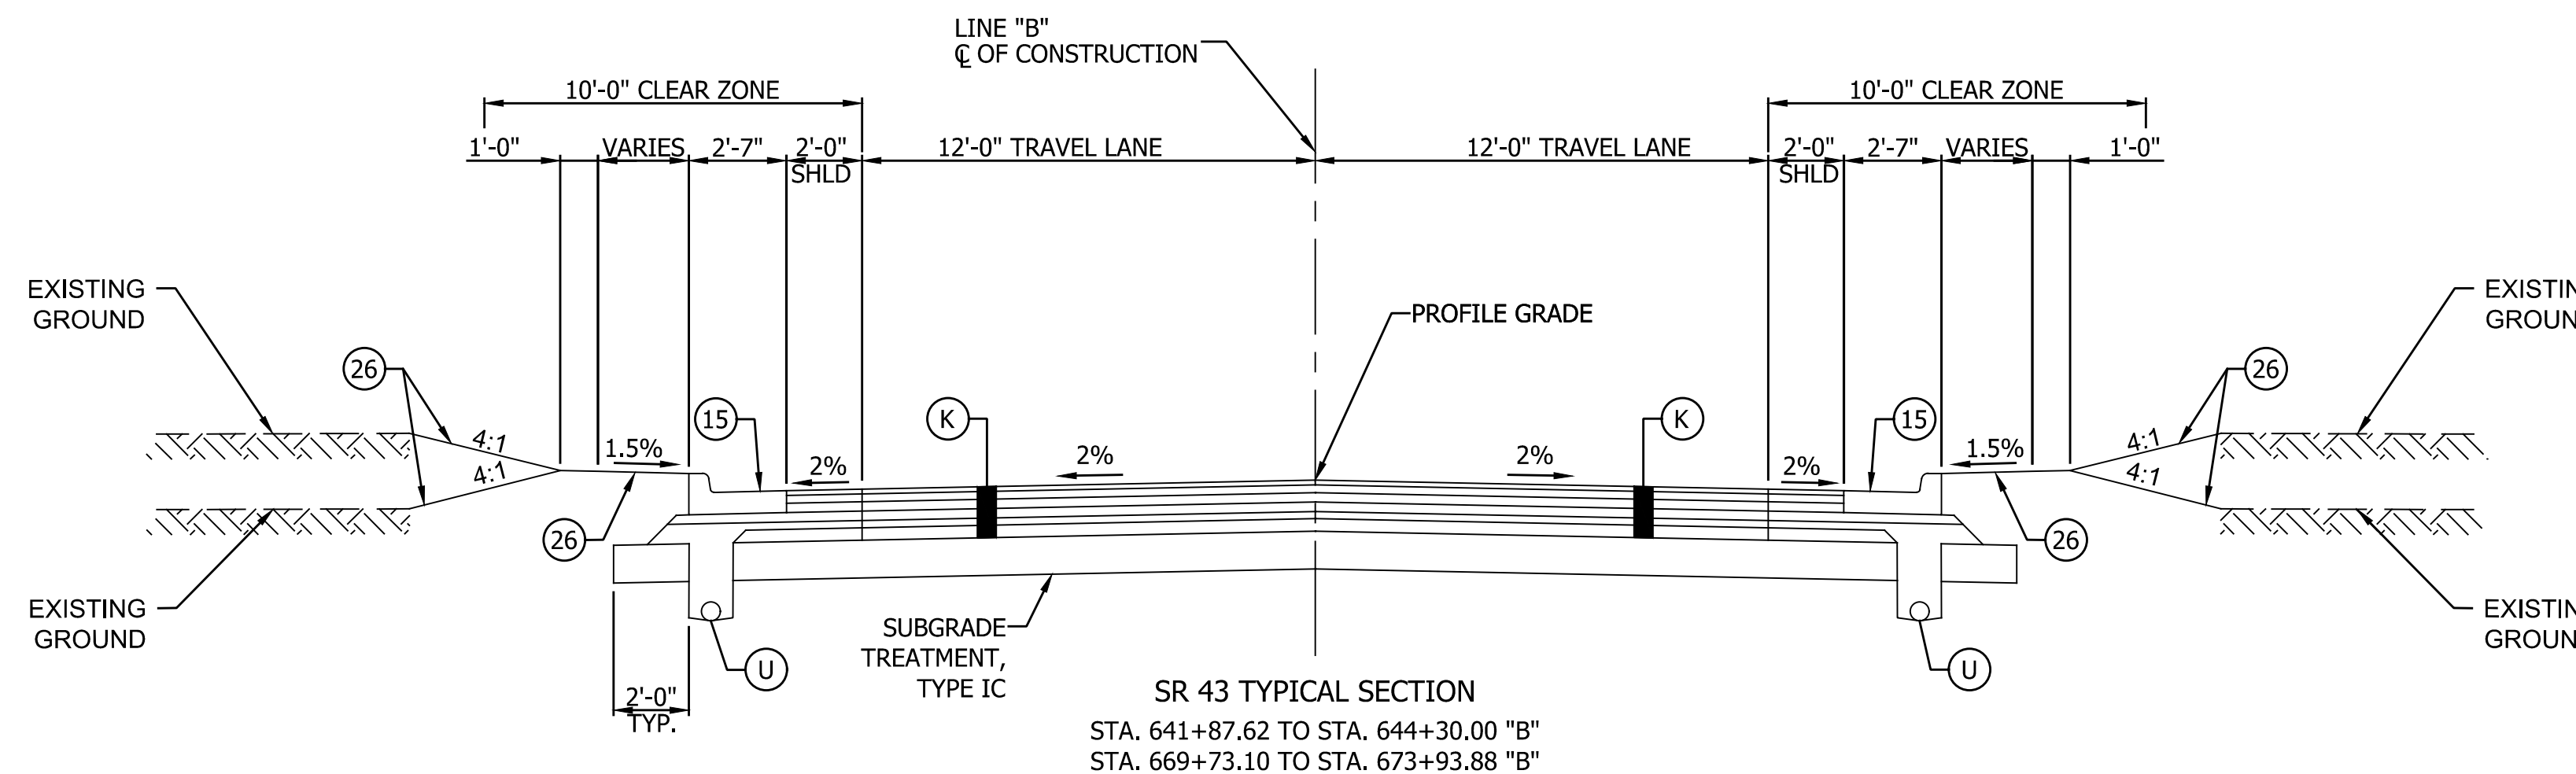

NOTES:  
 Tack Coat to be placed between all HMA layers.  
 Joint Adhesive to be installed at all joints in the surface and intermediate layers.  
 Liquid Asphalt Sealant to be placed centered on all joints.

- LEGEND**
- (F) Concrete Sidewalk, 4"
  - (K) 165 lb/SYS QC/QA HMA, 3, 70, Surface 9.5 mm on 275 lb/SYS QC/QA HMA, 3, 70, Intermediate 19.0 mm on 660 lb/SYS QC/QA HMA, 3, 64, Base 19.0 mm (2 Lifts) on 250 lb/SYS QC/QA HMA, 4, 76, Intermediate OG 19.0 mm on 4" Compacted Aggregate No. 53, Base on Geotextile for Pavement, Type 2A

- (K1) 165 lb/SYS QC/QA HMA, 3, 70, Surface 9.5 mm on 275 lb/SYS QC/QA HMA, 3, 70, Intermediate 19.0 mm on 660 lb/SYS QC/QA HMA, 3, 64, Base 19.0 mm (2 Lifts) on 6" Compacted Aggregate No. 53, Base
- (O) Compacted Aggregate, No. 53
- (R) Milling, Asphalt 1.5" (0 - 1.5" Profile Difference) 165 lb/SYS QC/QA HMA 3, 70, Surface 9.5 mm


- (W) Widening with HMA, Type C
- (14) Mod. Concrete Rolled Curb (Sloping)
- (15) Combined Concrete Curb & Gutter
- (16) Curb, Concrete (Vertical)
- (26) Sodding, Nursery

RECOMMENDED FOR APPROVAL		DESIGN ENGINEER	DATE
DESIGNED: BLW	DRAWN: EJK		
CHECKED: DCK	CHECKED: DCK		


INDIANA  
 DEPARTMENT OF TRANSPORTATION  
 TYPICAL CROSS SECTIONS  
 SR 43

HORIZONTAL SCALE	BRIDGE FILE
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VERTICAL SCALE	DESIGNATION
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SURVEY BOOK	SHEET
	4 of 117
CONTRACT	PROJECT
R-43449	2001828



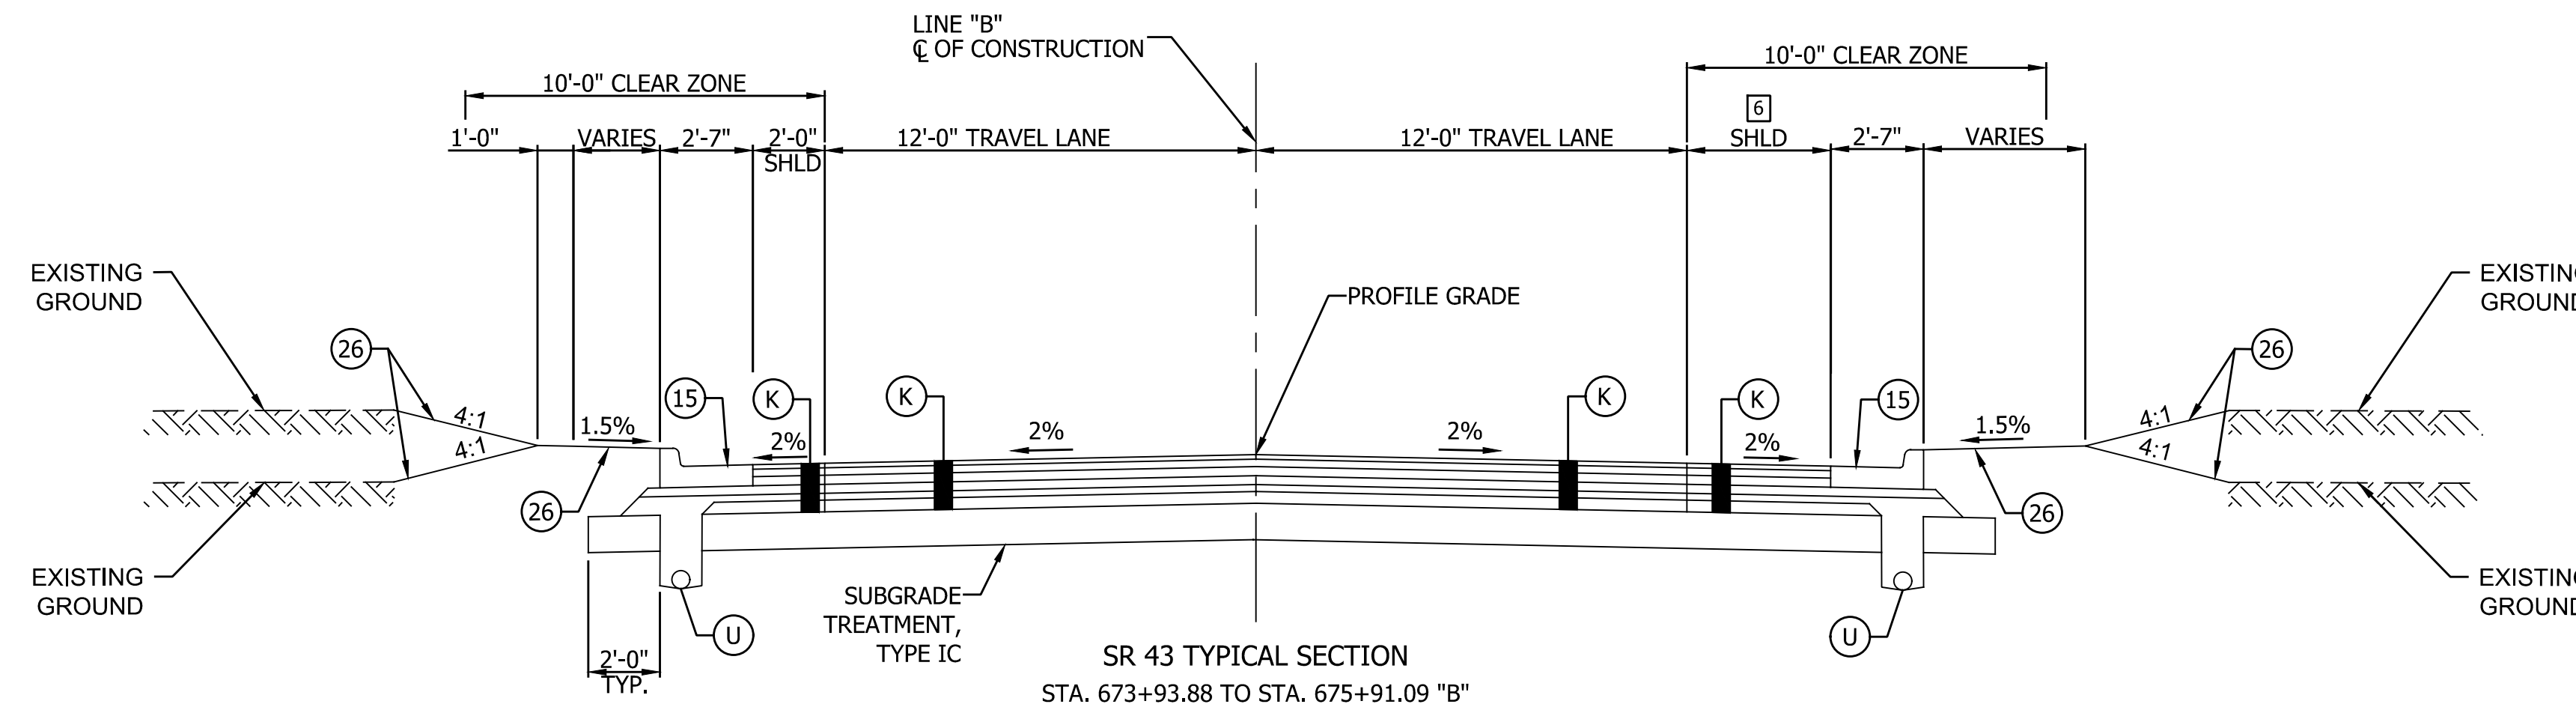


6 VARIES FROM 2'-0" AT STA. 673+93.88 TO 4'-0" AT STA. 674+64.87

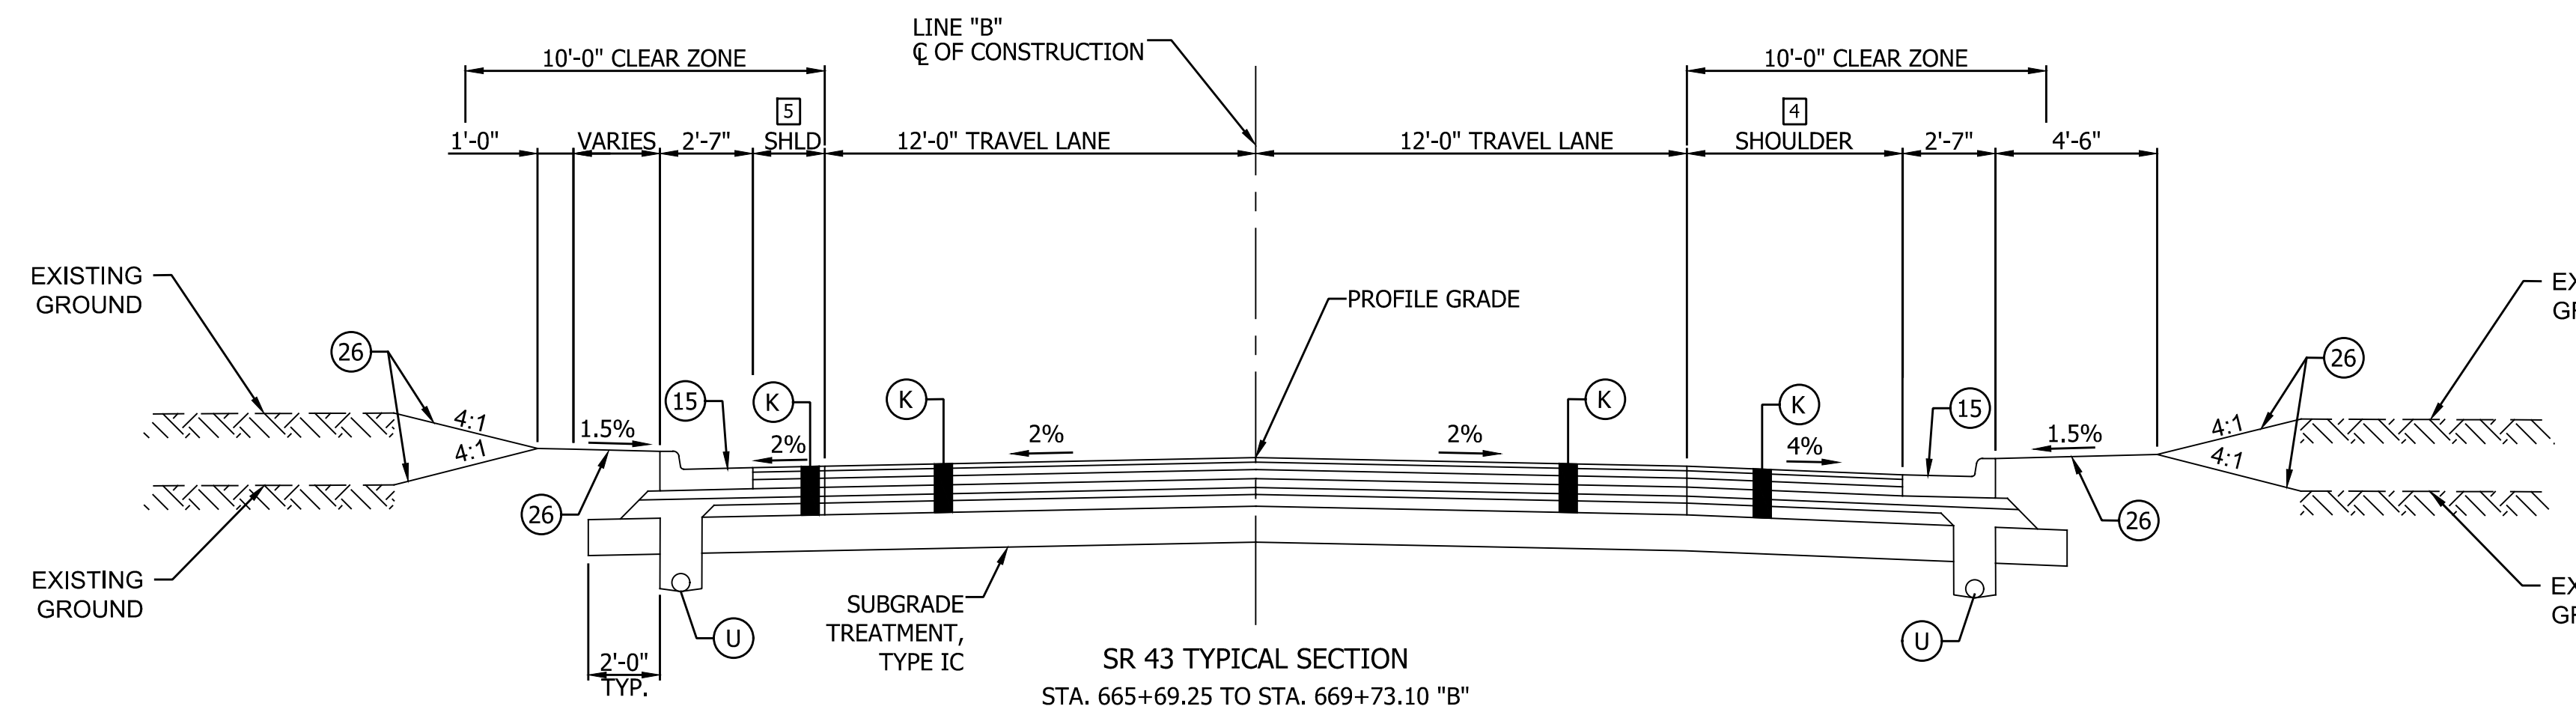

5 2'-0" FROM STA. 665+69.25 TO STA. 667+41.15  
VARIES FROM 2'-0" AT STA. 667+41.15 TO 10'-0" AT STA. 667+68.85  
10'-0" FROM STA. 667+68.85 TO STA. 668+05.17  
VARIES FROM 10'-0" AT STA. 668+05.17 TO 2'-0" AT STA. 668+68.85  
2'-0" FROM STA. 668+68.85 TO STA. 669+73.10

4 VARIES FROM 2'-0" AT STA. 665+69.25 TO 6'-0" AT STA. 667+21.09  
6'-0" FROM STA. 667+21.09 TO STA. 667+94.08  
VARIES FROM 6'-0" AT STA. 667+94.08 TO 7'-6" AT STA. 668+84.07  
7'-6" FROM STA. 668+84.07 TO STA. 669+02.48  
VARIES FROM 7'-6" AT STA. 669+02.48 TO 2'-0" AT STA. 669+73.10

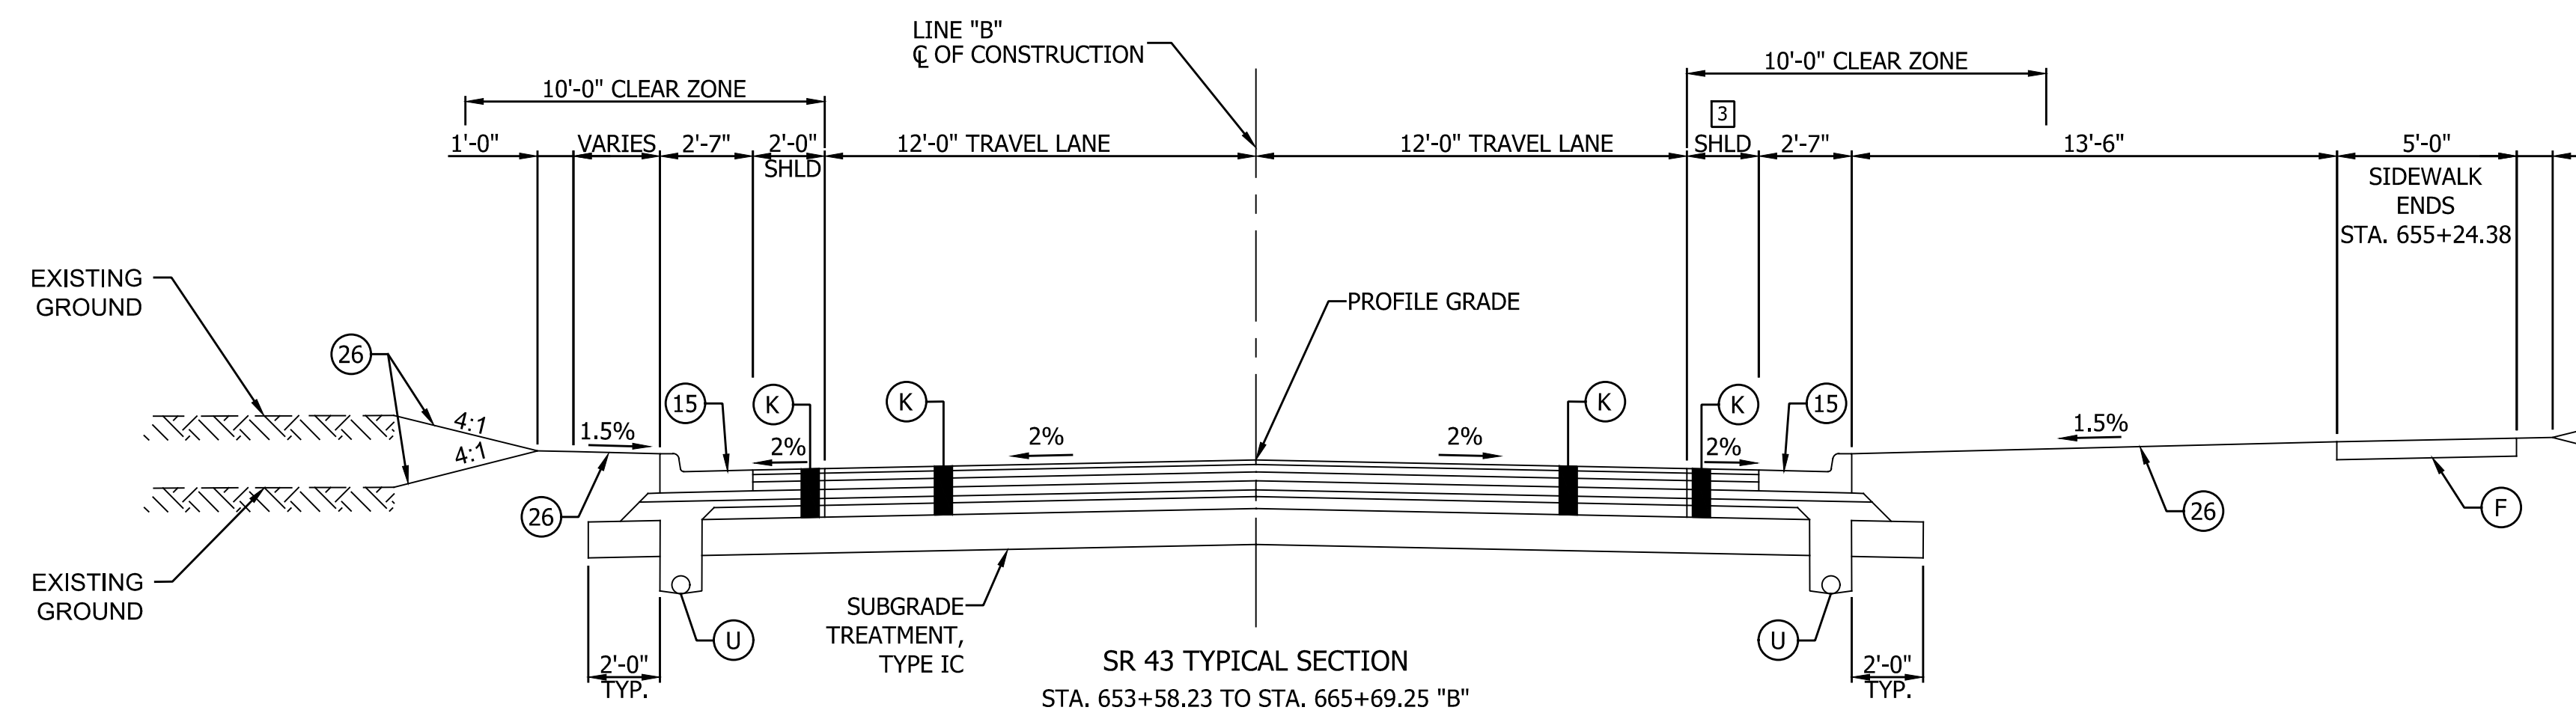

3 VARIES FROM 4'-6" AT STA. 653+58.23 TO 2'-0" AT STA. 654+48.49  
2'-0" FROM STA. 654+48.49 TO STA. 665+69.25

NOTES:  
Tack Coat to be placed between all HMA layers.  
Joint Adhesive to be installed at all joints in the surface and intermediate layers.  
Liquid Asphalt Sealant to be placed centered on all joints.

PRINT DATE: 4/9/23 PLOT SCALE: 1:1 EDIT DATE: 7/12/11 - 7:18 AM EDITED BY: RWILSON DRAWING FILE: P:\21-500-155-1 WHITE CO PAVEMENT REPLACEMENT 210108'S ACAD\03 TYPICALS\TYPICALS.DWG

LEGEND		
(F) Concrete Sidewalk, 4"	(K1) 165 lb/SYS QC/QA HMA, 3, 70, Surface 9.5 mm on 275 lb/SYS QC/QA HMA, 3, 70, Intermediate 19.0 mm on 660 lb/SYS QC/QA HMA, 3, 64, Base 19.0 mm (2 Lifts) on 6" Compacted Aggregate No. 53, Base	(W) Widening with HMA, Type C
(K) 165 lb/SYS QC/QA HMA, 3, 70, Surface 9.5 mm on 275 lb/SYS QC/QA HMA, 3, 70, Intermediate 19.0 mm on 660 lb/SYS QC/QA HMA, 3, 64, Base 19.0 mm (2 Lifts) on 250 lb/SYS QC/QA HMA, 4, 76, Intermediate OG 19.0 mm on 4" Compacted Aggregate No. 53, Base on Geotextile for Pavement, Type 2A	(O) Compacted Aggregate, No. 53	(14) Mod. Concrete Rolled Curb (Sloping)
	(R) Milling, Asphalt 1.5" (0 - 1.5" Profile Difference) 165 lb/SYS QC/QA HMA 3, 70, Surface 9.5 mm	(15) Combined Concrete Curb & Gutter
		(16) Curb, Concrete (Vertical)
		(26) Sodding, Nursery


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CHECKED: DCK	CHECKED: DCK	

**INDIANA DEPARTMENT OF TRANSPORTATION**

**TYPICAL CROSS SECTIONS SR 43**


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SURVEY BOOK	SHEET
	5 of 117
CONTRACT	PROJECT
R-43449	2001828

PRINT DATE: 4/9/23  
 PLOT SCALE: 1:1  
 EDIT DATE: 7/12/11 - 7:18 AM  
 EDITED BY: RWILSON  
 DRAWING FILE: P:\21-500-155-1 WHITE CO PAVEMENT REPLACEMENT 210108'S ACAD\03 TYPICALS\TYPICALS.DWG

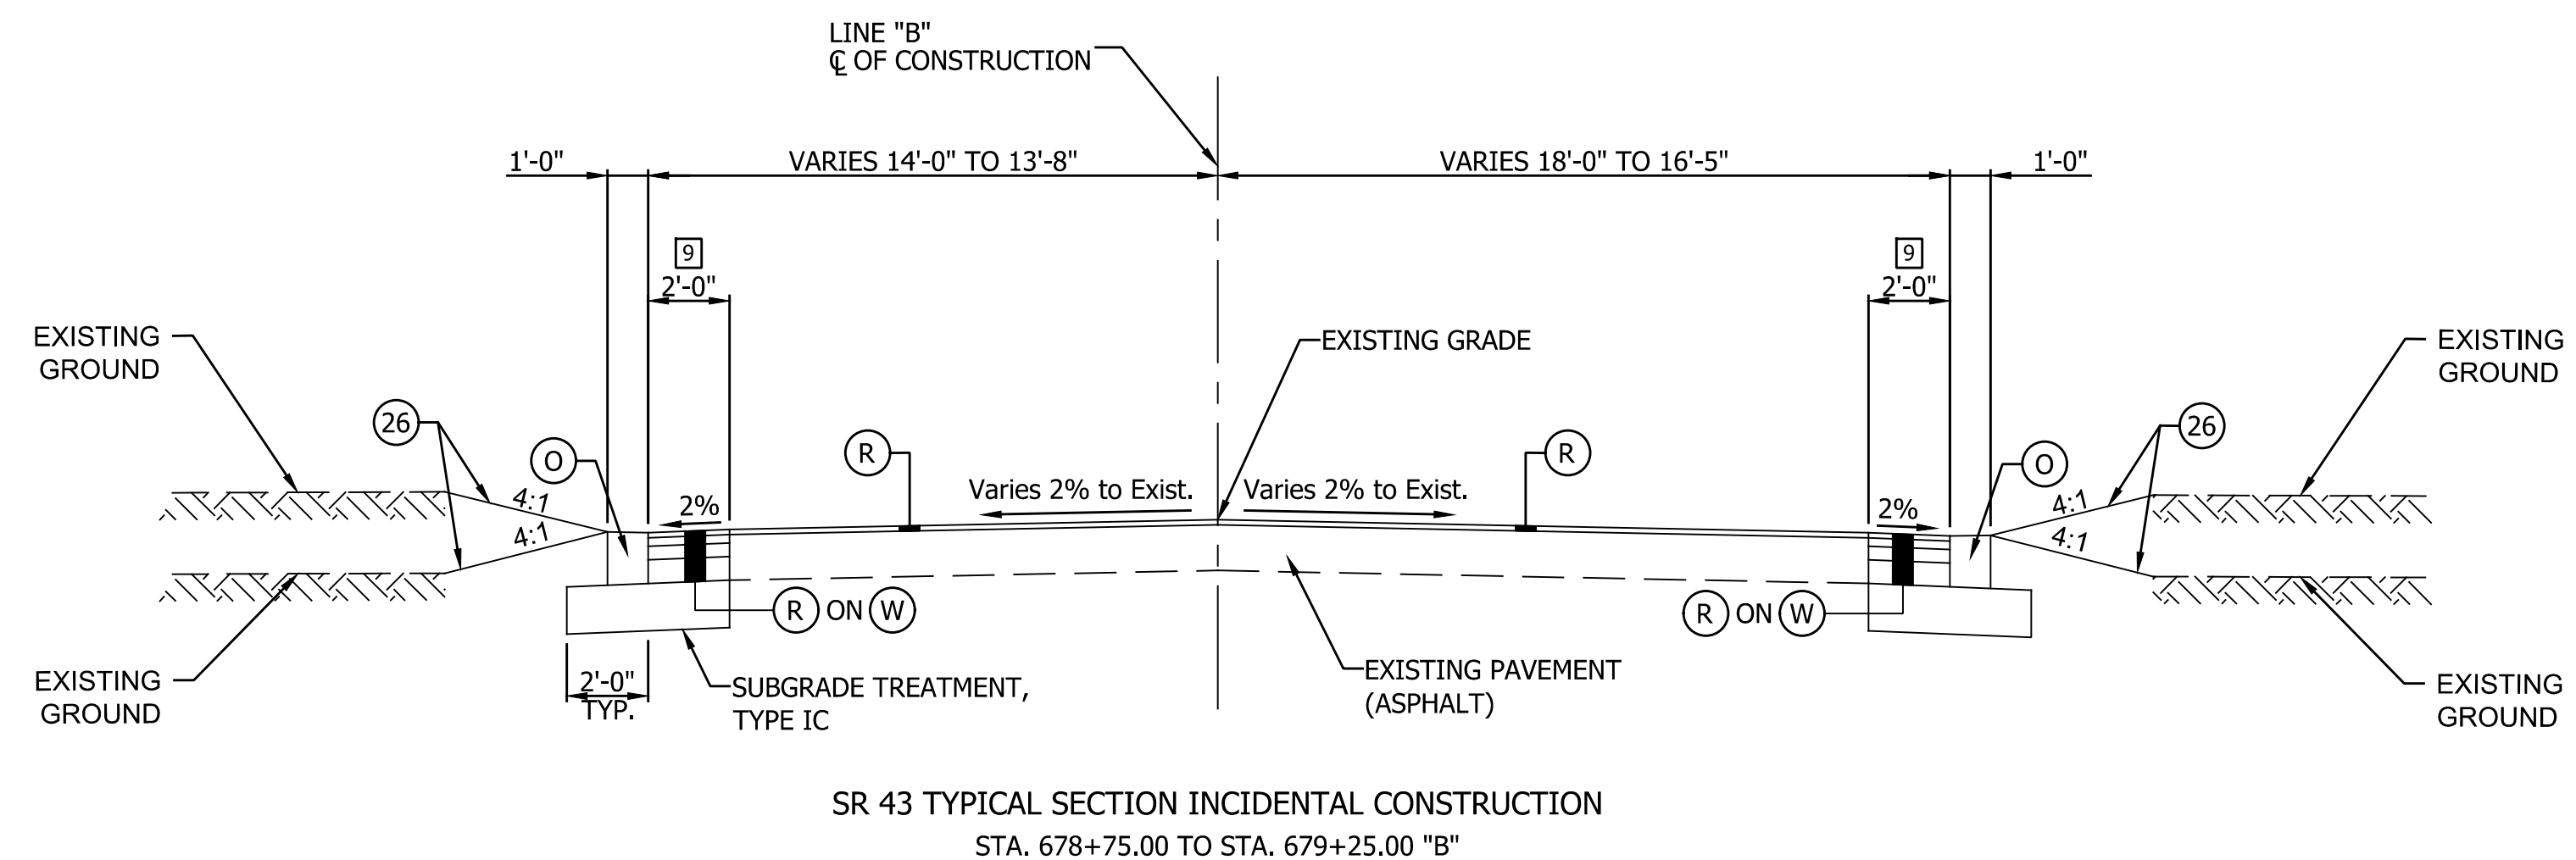

SR 43 TYPICAL SECTION INCIDENTAL CONSTRUCTION  
 STA. 678+75.00 TO STA. 679+25.00 "B"

(9) WIDENING FROM STA. 678+75.00 TO STA. 679+00.00

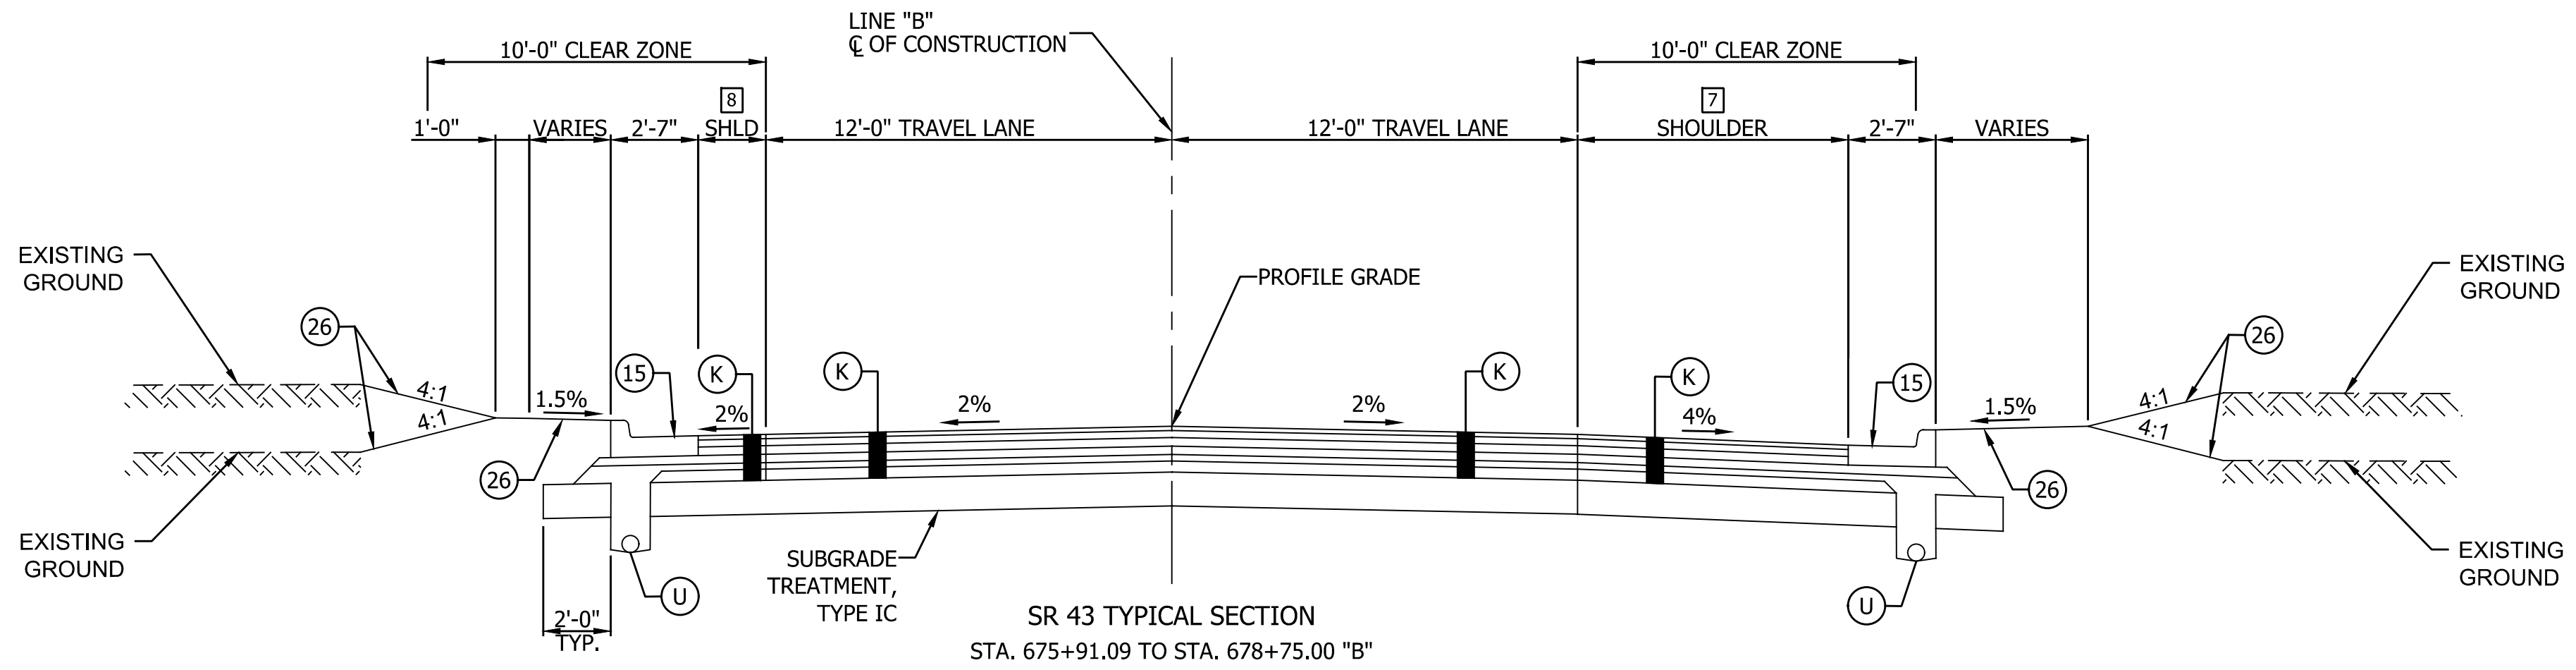

SR 43 TYPICAL SECTION  
 STA. 675+91.09 TO STA. 678+75.00 "B"

(8) 2'-0" FROM STA. 675+91.09 TO STA. 676+67.98  
 VARIES FROM 2'-0" AT STA. 676+67.98 TO 0'-0" AT STA. 678+67.72  
 0'-0" FROM STA. 678+67.72 TO STA. 678+75.00

(7) VARIES FROM 4'-0" AT STA. 675+91.09 TO 8'-0" AT STA. 676+34.00  
 8'-0" FROM STA. 676+34.00 TO STA. 678+21.68  
 VARIES FROM 8'-0" AT STA. 678+21.68 TO 4'-0" AT STA. 678+64.59  
 4'-0" FROM STA. 678+64.59 TO STA. 678+75.00



**NOTES:**  
 Tack Coat to be placed between all HMA layers.  
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 Liquid Asphalt Sealant to be placed centered on all joints.

LEGEND		
(F) Concrete Sidewalk, 4"	(K1) 165 lb/SYS QC/QA HMA, 3, 70, Surface 9.5 mm on 275 lb/SYS QC/QA HMA, 3, 70, Intermediate 19.0 mm on 660 lb/SYS QC/QA HMA, 3, 64, Base 19.0 mm (2 Lifts) on 6" Compacted Aggregate No. 53, Base	(W) Widening with HMA, Type C
(K) 165 lb/SYS QC/QA HMA, 3, 70, Surface 9.5 mm on 275 lb/SYS QC/QA HMA, 3, 70, Intermediate 19.0 mm on 660 lb/SYS QC/QA HMA, 3, 64, Base 19.0 mm (2 Lifts) on 250 lb/SYS QC/QA HMA, 4, 76, Intermediate OG 19.0 mm on 4" Compacted Aggregate No. 53, Base on Geotextile for Pavement, Type 2A	(O) Compacted Aggregate, No. 53	(14) Mod. Concrete Rolled Curb (Sloping)
	(R) Milling, Asphalt 1.5" (0 - 1.5" Profile Difference) 165 lb/SYS QC/QA HMA 3, 70, Surface 9.5 mm	(15) Combined Concrete Curb & Gutter
		(16) Curb, Concrete (Vertical)
		(26) Sodding, Nursery


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DESIGNED: BLW	DRAWN: EJK	
CHECKED: DCK	CHECKED: DCK	

**INDIANA DEPARTMENT OF TRANSPORTATION**  
**TYPICAL CROSS SECTIONS**  
**SR 43**


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VERTICAL SCALE	DESIGNATION
1/4" = 1'-0"	2001828
SURVEY BOOK	SHEET
	6 of 117
CONTRACT	PROJECT
R-43449	2001828

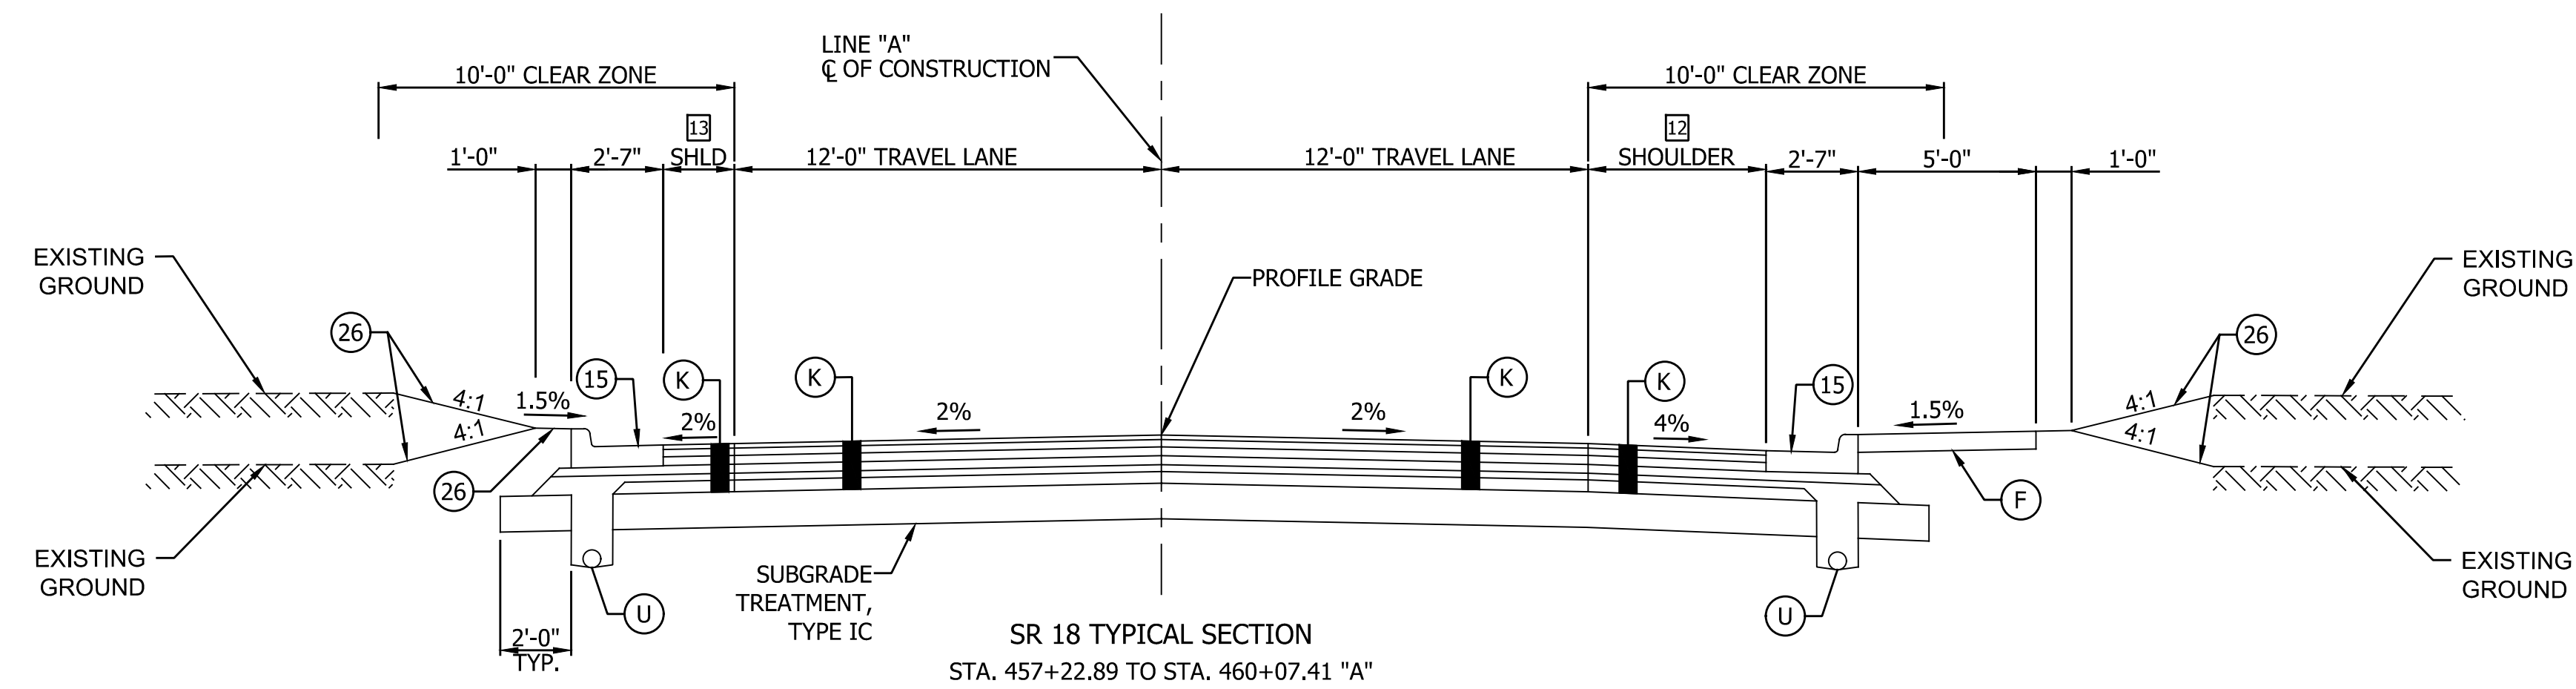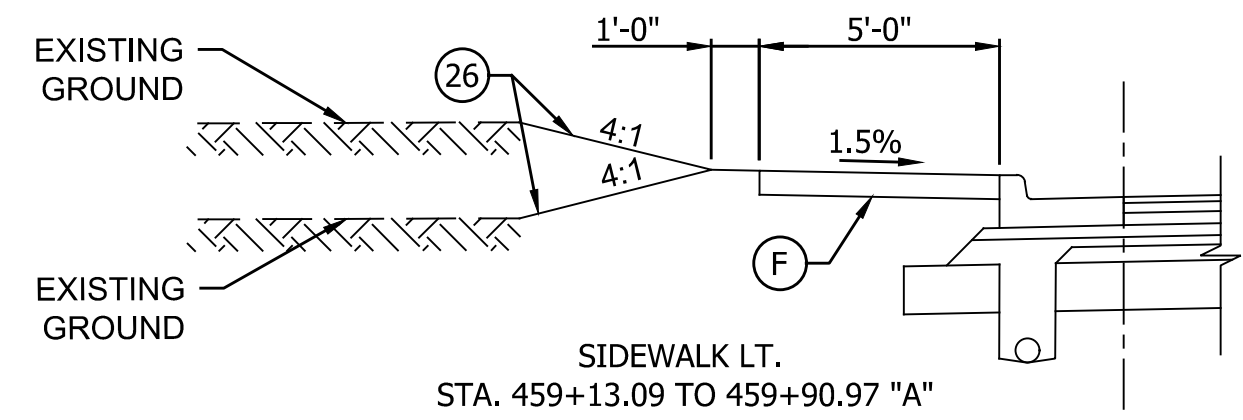

- 13 VARIES FROM 4'-6" AT STA. 457+22.89 TO 2'-0" AT STA. 457+49.76  
2'-0" FROM STA. 457+49.76 TO STA. 459+26.80  
VARIES FROM 2'-0" AT STA. 459+26.80 TO 85'-2" AT STA. 460+07.41
- 12 2'-0" FROM STA. 457+22.89 TO STA. 457+95.87  
VARIES FROM 2'-0" AT STA. 457+95.87 TO 5'-0" AT STA. 458+66.12  
5'-0" FROM STA. 458+66.12 TO STA. 459+32.68  
VARIES FROM 5'-0" AT STA. 459+32.68 TO 114'-7" AT STA. 460+07.41

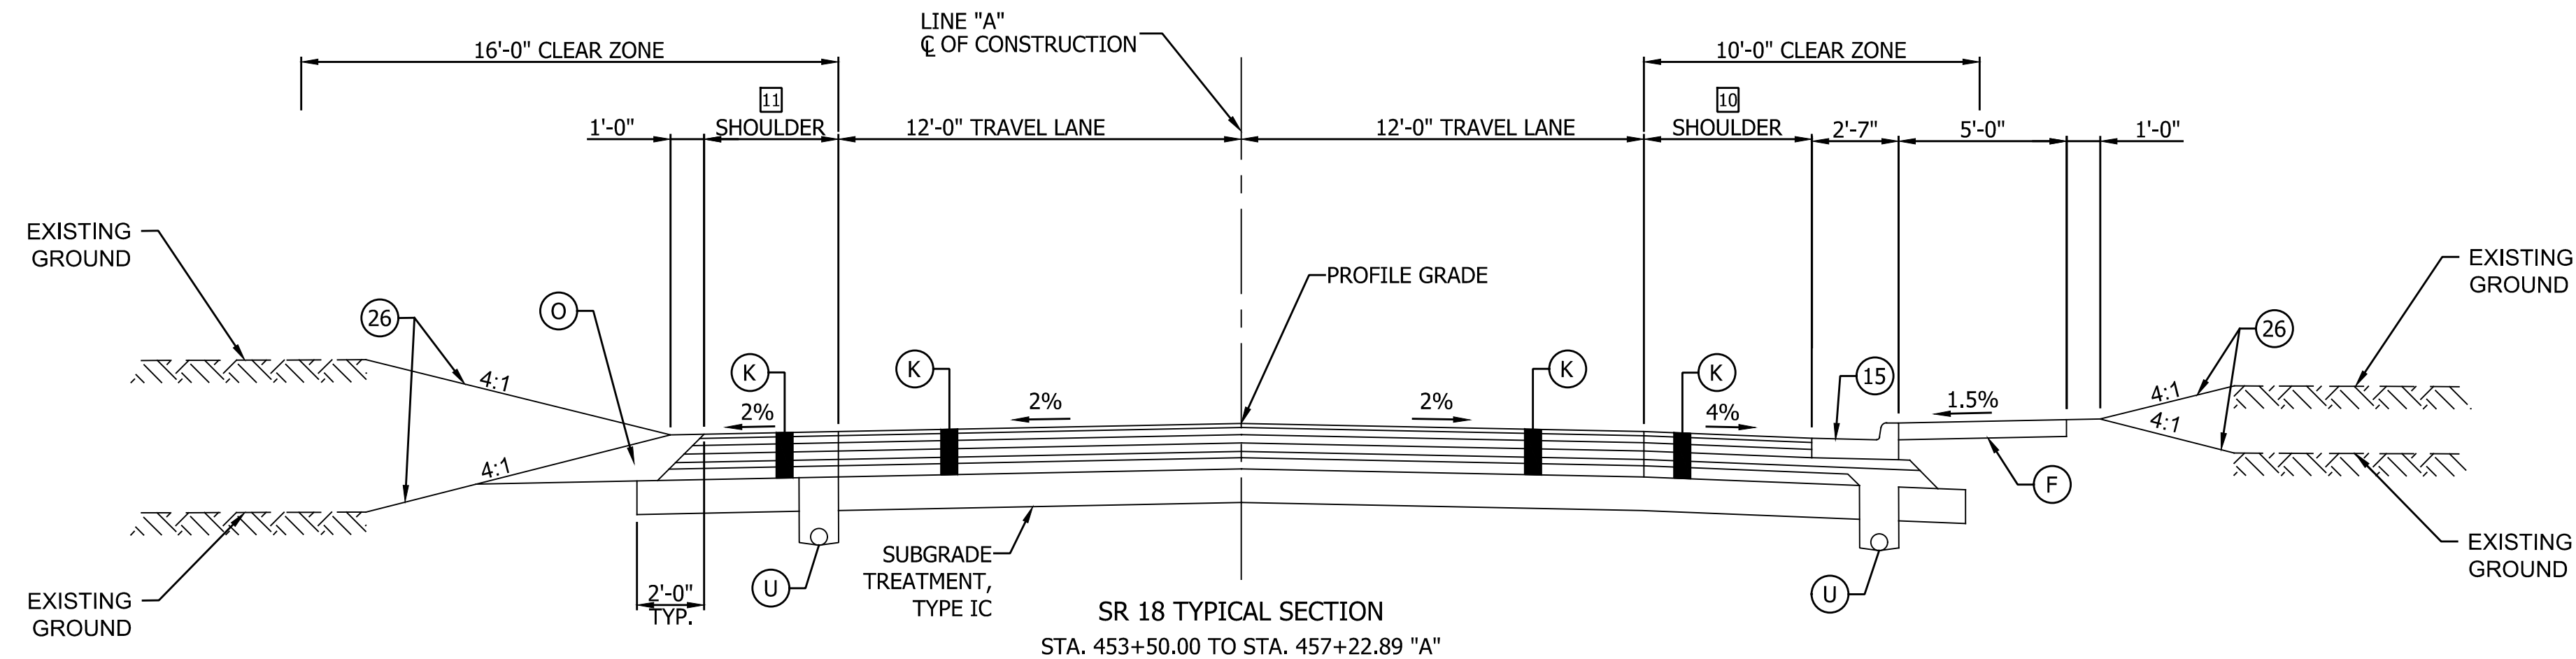

- 11 10'-11" FROM STA. 453+50.00 TO STA. 454+01.15  
VARIES FROM 10'-11" AT STA. 454+01.15 TO 4'-0" AT STA. 454+71.96  
4'-0" FROM STA. 454+71.96 TO STA. 456+33.47  
VARIES FROM 4'-0" AT STA. 456+33.47 TO 4'-6" AT STA. 457+22.89
- 10 0'-0" FROM STA. 453+50.00 TO STA. 454+01.54  
VARIES FROM 0'-0" AT STA. 454+01.54 TO 5'-0" AT STA. 454+13.41  
5'-0" FROM STA. 454+13.41 TO STA. 455+80.00  
VARIES FROM 5'-0" AT STA. 455+80.00 TO 2'-0" AT STA. 456+46.18  
2'-0" FROM STA. 456+46.18 TO STA. 457+22.89

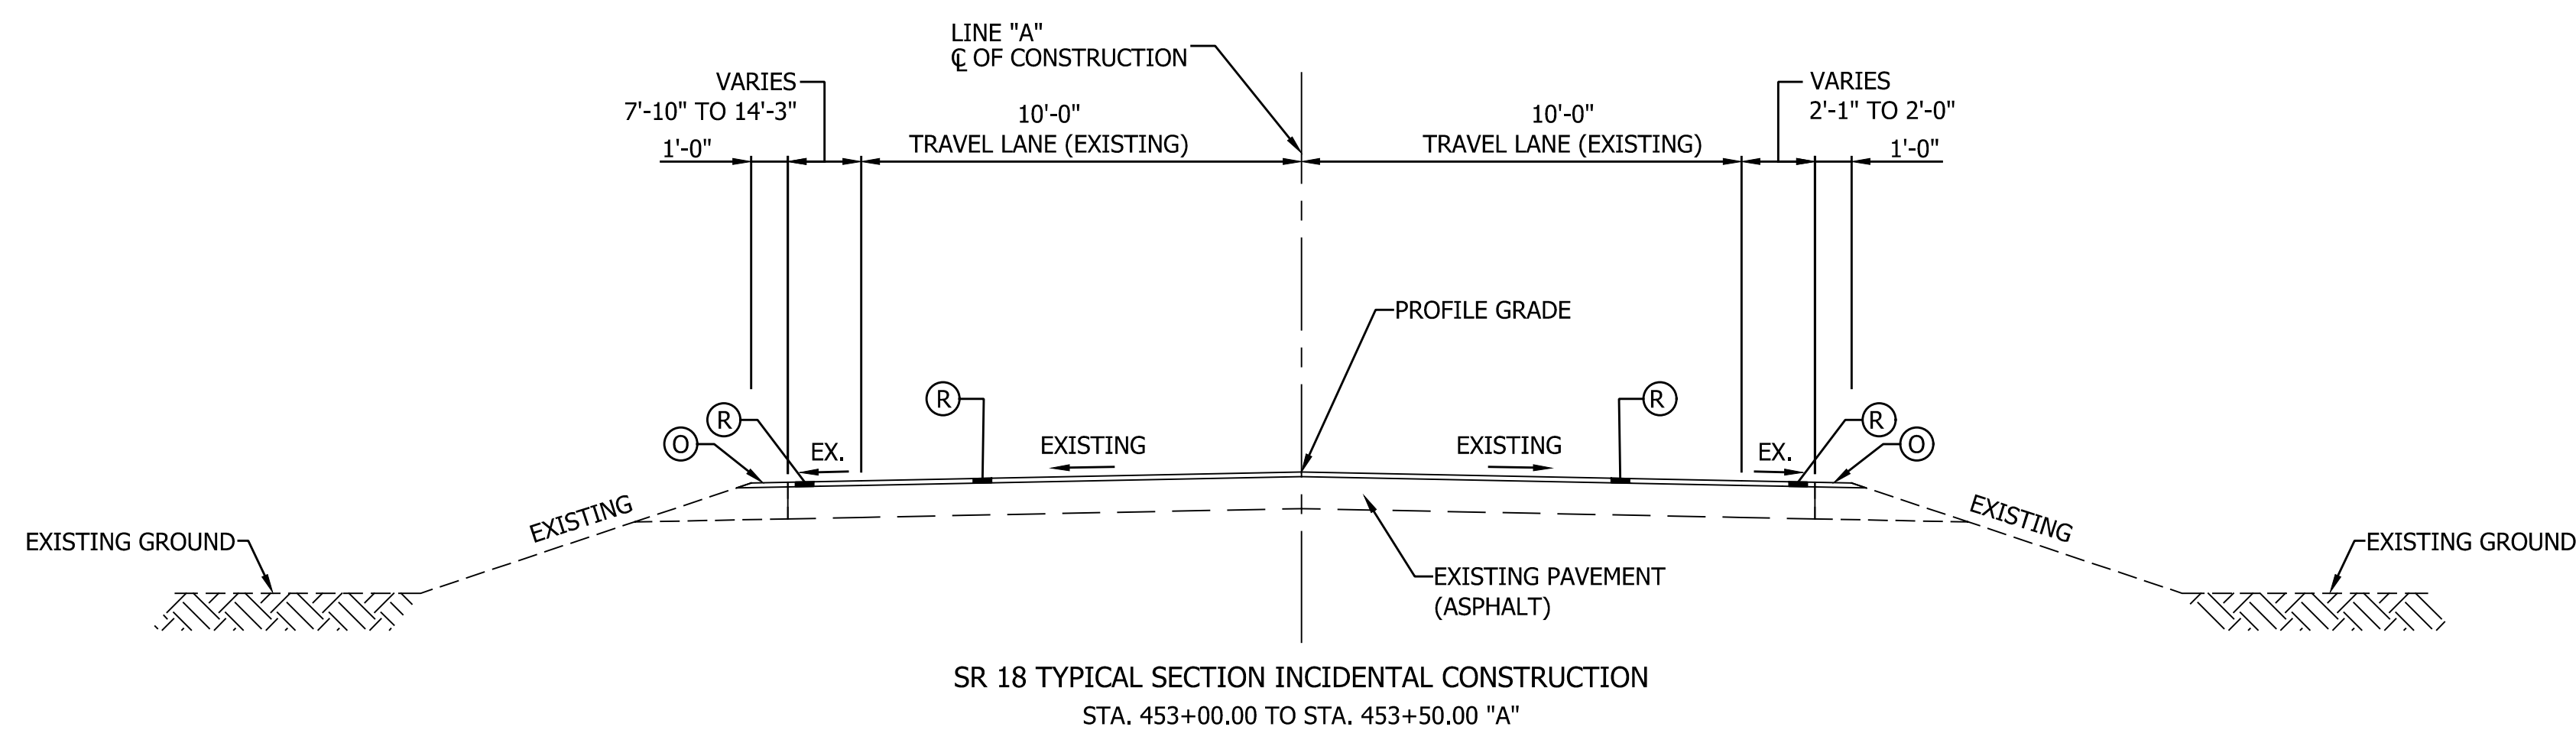

**NOTES:**  
Tack Coat to be placed between all HMA layers.  
Joint Adhesive to be installed at all joints in the surface and intermediate layers.  
Liquid Asphalt Sealant to be placed centered on all joints.

LEGEND		
(F) Concrete Sidewalk, 4"	(K1) 165 lb/SYS QC/QA HMA, 3, 70, Surface 9.5 mm on 275 lb/SYS QC/QA HMA, 3, 70, Intermediate 19.0 mm on 660 lb/SYS QC/QA HMA, 3, 64, Base 19.0 mm (2 Lifts) on 6" Compacted Aggregate No. 53, Base	(W) Widening with HMA, Type C
(K) 165 lb/SYS QC/QA HMA, 3, 70, Surface 9.5 mm on 275 lb/SYS QC/QA HMA, 3, 70, Intermediate 19.0 mm on 660 lb/SYS QC/QA HMA, 3, 64, Base 19.0 mm (2 Lifts) on 250 lb/SYS QC/QA HMA, 4, 76, Intermediate OG 19.0 mm on 4" Compacted Aggregate No. 53, Base on Geotextile for Pavement, Type 2A	(O) Compacted Aggregate, No. 53	(14) Mod. Concrete Rolled Curb (Sloping)
	(R) Milling, Asphalt 1.5" (0 - 1.5" Profile Difference) 165 lb/SYS QC/QA HMA 3, 70, Surface 9.5 mm	(15) Combined Concrete Curb & Gutter
		(16) Curb, Concrete (Vertical)
		(26) Sodding, Nursery

RECOMMENDED FOR APPROVAL	DESIGN ENGINEER	DATE
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CHECKED: DCK	CHECKED: DCK	


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CONTRACT	PROJECT
R-43449	2001828

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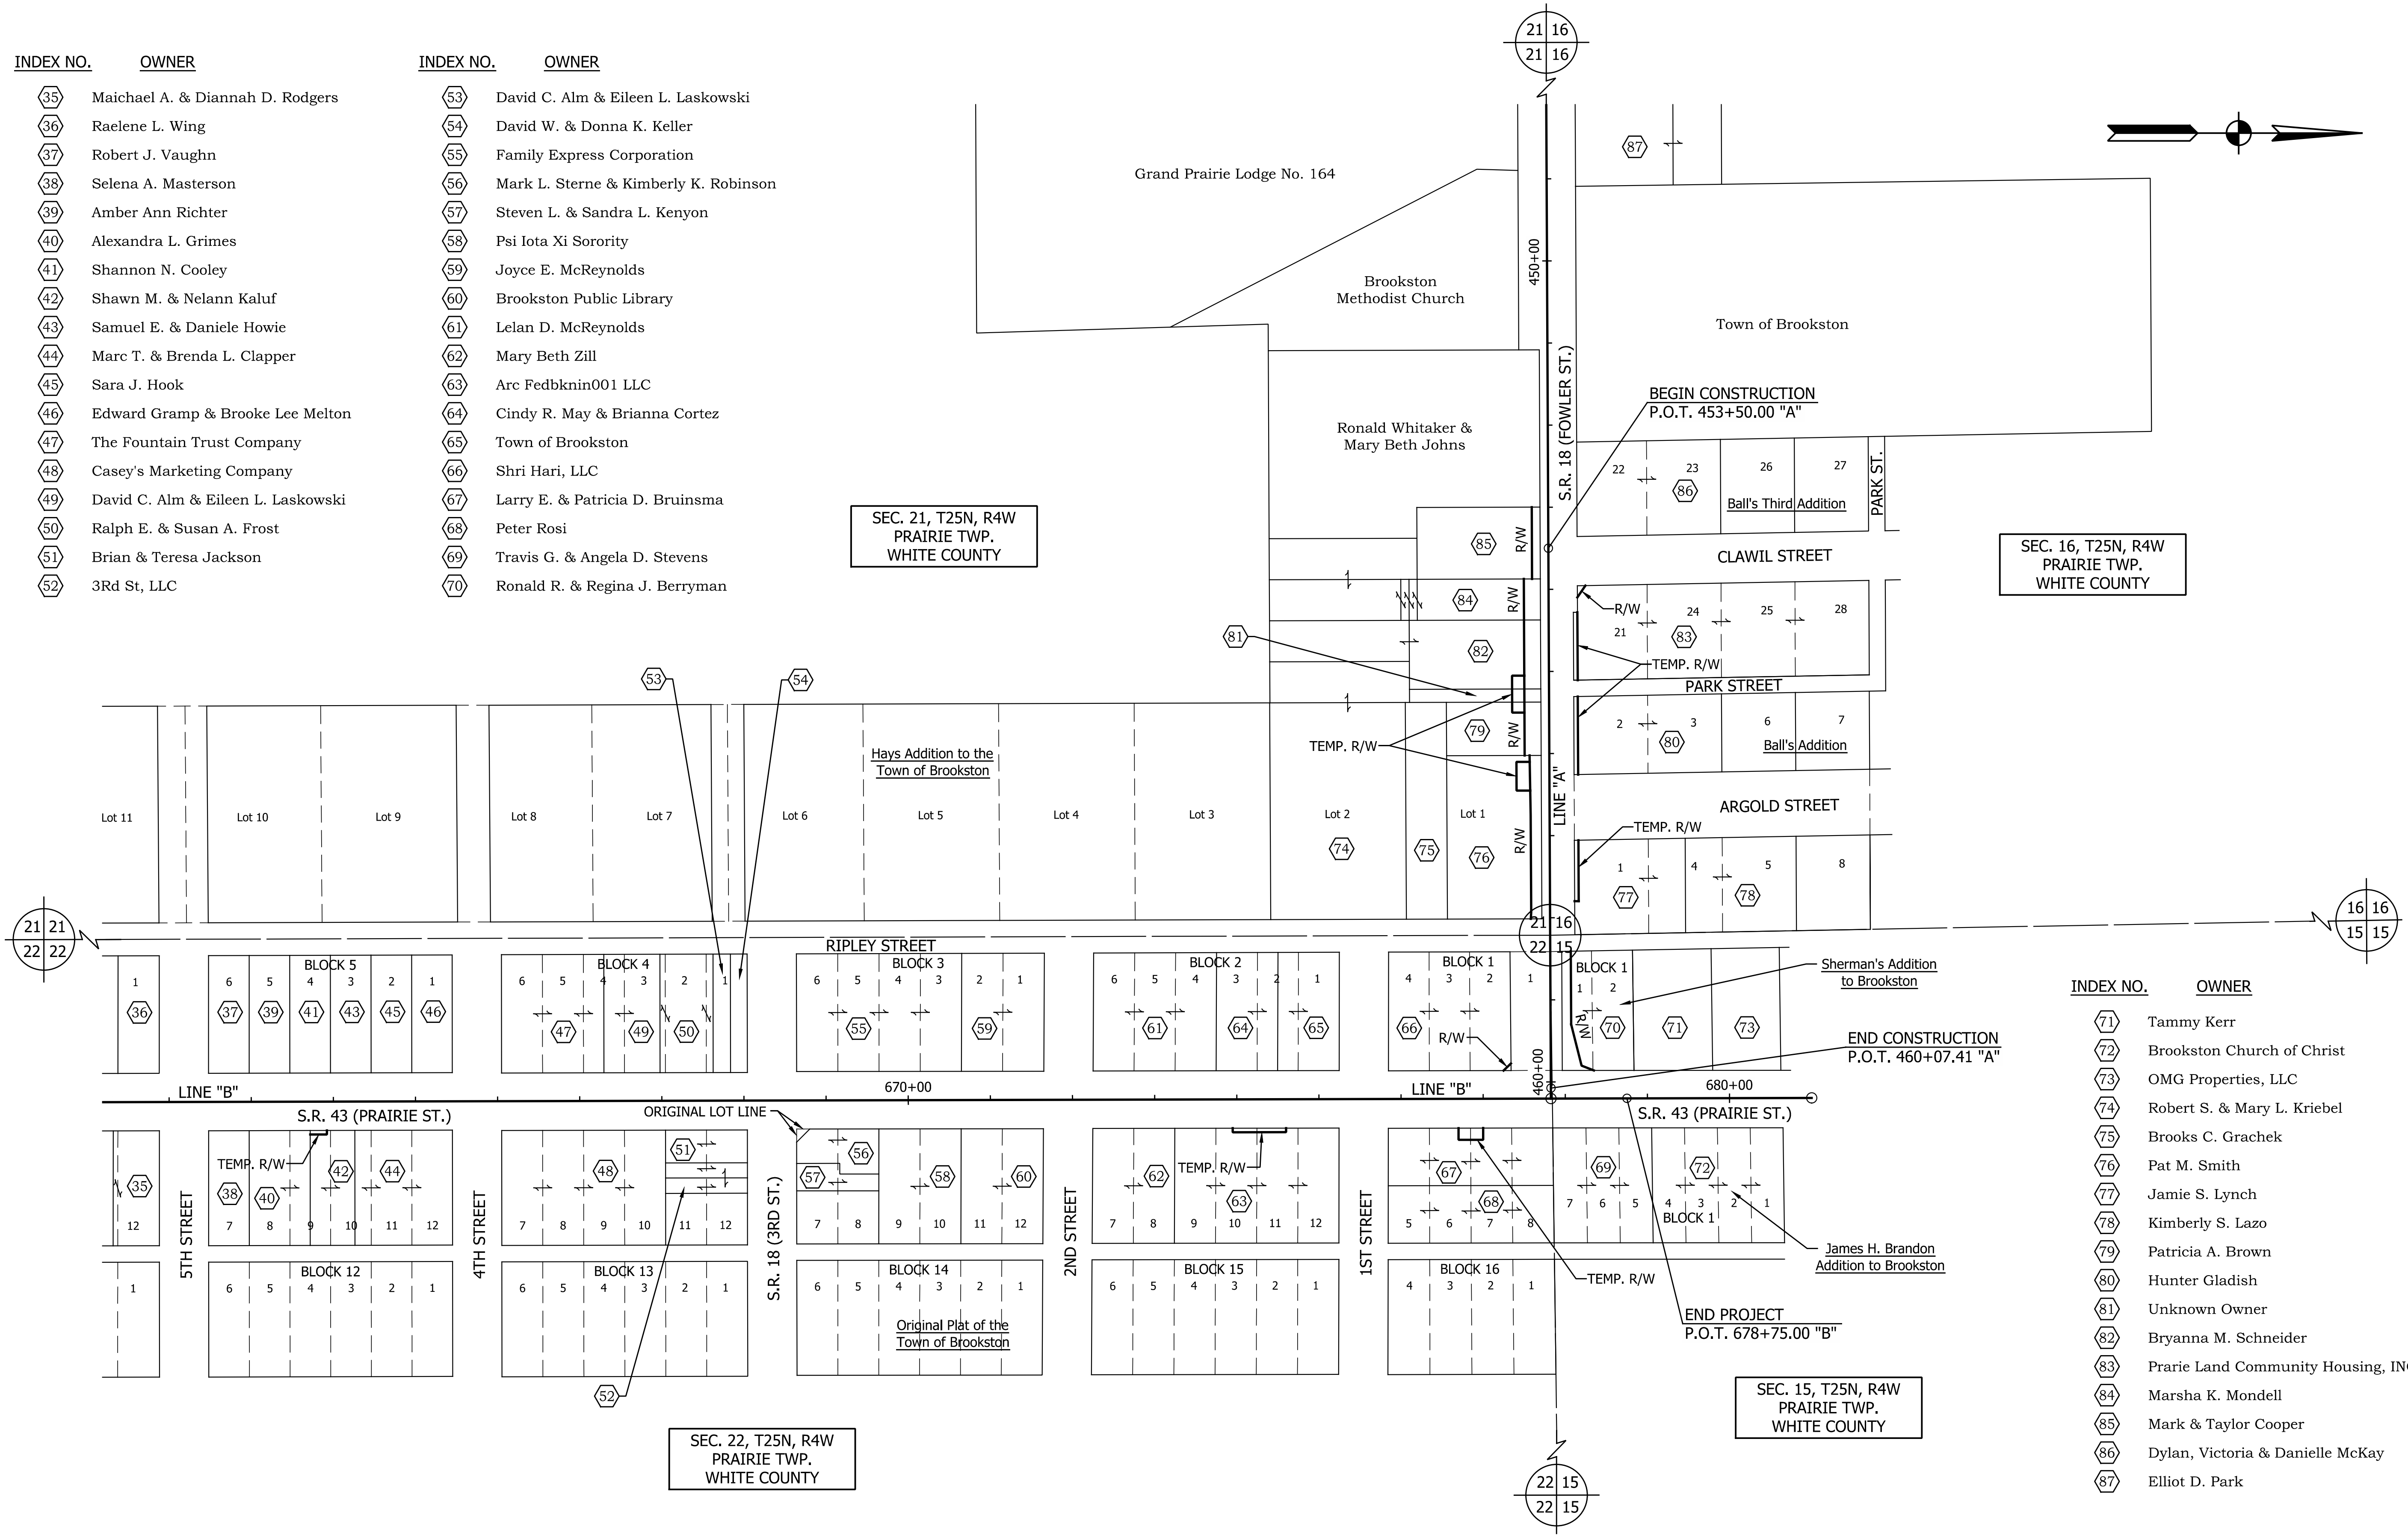
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INDEX NO.	OWNER	INDEX NO.	OWNER	INDEX NO.	OWNER	INDEX NO.	OWNER
1	Edward & Stacy Jacobs	8	Harry L. Bartlett	15	Clarence Lee & Denise Ann Lopp	23	James L. & Deborah S. Longfellow
2	Raelene L. Wing	9	Steven Morgan Jr.	16	Clarence L. & Denise A. Lopp	24	Brilee Meacham
3	Terrence D. & Sherry L. Banes	10	Jerry E. & Leona A. Amick	17	Mandi Altman	25	Cody W. Stinnett
4	Steven Stein	11	Allyson Dawn Franklin	18	Administrator Assistance, LLC	26	Bruce & Nancy A. Harmon
5	Casey W. Allen	12	Laurel A. Eakin	19	Gladys A. Van Voorst	27	Trent L. Judy
6	Ryan M. & Mandy L. Altman	13	Judith M. Jr. & Jewell D. Dees	20	Lawrence A. & Jane E. Horstman	28	Colby & Jaime Reel
7	Jeffrey L. McKay	14	Bradly J. Reid	21	Connor J. Schuster	29	Jeremy A. & Heather M. Miller
				22	Bette Bilyeu	30	Jerry Joe Donnoe, III
						31	Jacob A. & Evelyn Sue Rhoda
						32	Matthew Lee Neal
						33	Mark Pattenglae, Jr. & Marissa B. Alwine
						34	Christopher Sallee & Gwynne Oliver
						35	Maichael A. & Diannah D. Rodgers
						36	Raelene L. Wing
						37	Robert J. Vaughn
						38	Selena A. Masterson

	RECOMMENDED FOR APPROVAL	DESIGN ENGINEER	DATE	<b>INDIANA DEPARTMENT OF TRANSPORTATION</b>  <b>PLAT NO. 1</b>	HORIZONTAL SCALE	BRIDGE FILE
					1" = 100'	N/A
					N/A	DESIGNATION
	DESIGNED: <u>BLW</u>	DRAWN: <u>REW</u>			SURVEY BOOK	SHEET
	CHECKED: <u>DCK</u>	CHECKED: <u>DCK</u>			8	of 117
					CONTRACT	PROJECT
					R-43449	2001828

INDEX NO.	OWNER	INDEX NO.	OWNER
35	Maichael A. & Diannah D. Rodgers	53	David C. Alm & Eileen L. Laskowski
36	Raelene L. Wing	54	David W. & Donna K. Keller
37	Robert J. Vaughn	55	Family Express Corporation
38	Selena A. Masterson	56	Mark L. Sterne & Kimberly K. Robinson
39	Amber Ann Richter	57	Steven L. & Sandra L. Kenyon
40	Alexandra L. Grimes	58	Psi Iota Xi Sorority
41	Shannon N. Cooley	59	Joyce E. McReynolds
42	Shawn M. & Nelann Kaluf	60	Brookston Public Library
43	Samuel E. & Daniele Howie	61	Lelan D. McReynolds
44	Marc T. & Brenda L. Clapper	62	Mary Beth Zill
45	Sara J. Hook	63	Arc Fedbknn001 LLC
46	Edward Gramp & Brooke Lee Melton	64	Cindy R. May & Brianna Cortez
47	The Fountain Trust Company	65	Town of Brookston
48	Casey's Marketing Company	66	Shri Hari, LLC
49	David C. Alm & Eileen L. Laskowski	67	Larry E. & Patricia D. Bruinsma
50	Ralph E. & Susan A. Frost	68	Peter Rosi
51	Brian & Teresa Jackson	69	Travis G. & Angela D. Stevens
52	3Rd St, LLC	70	Ronald R. & Regina J. Berryman


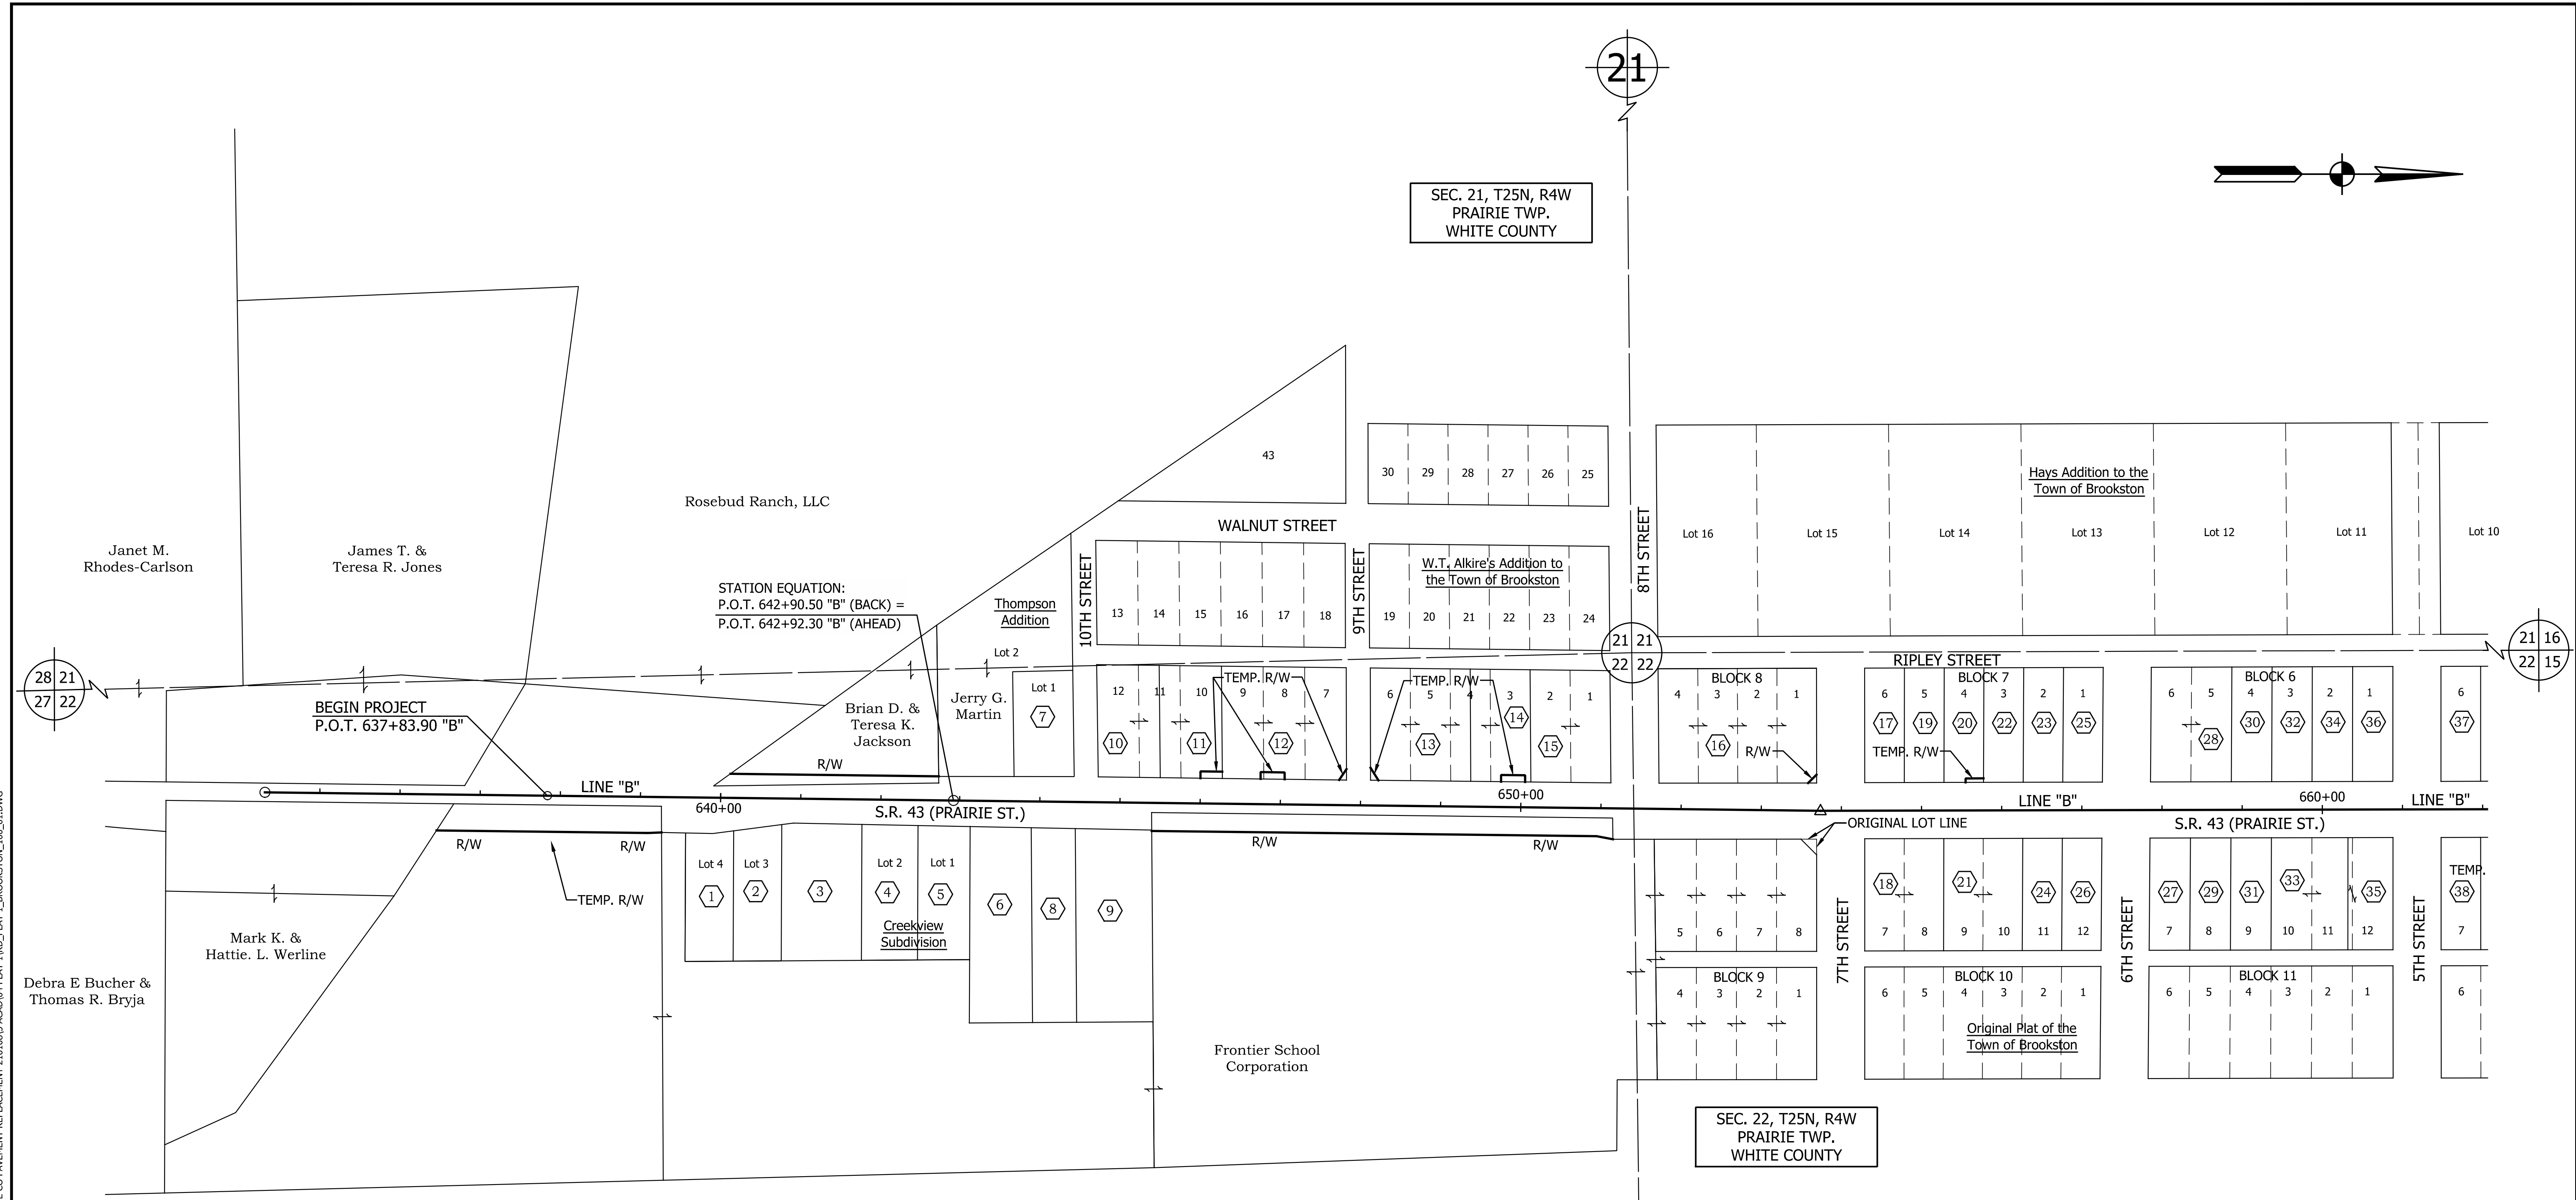


INDEX NO.	OWNER
71	Tammy Kerr
72	Brookston Church of Christ
73	OMG Properties, LLC
74	Robert S. & Mary L. Kriebel
75	Brooks C. Grachek
76	Pat M. Smith
77	Jamie S. Lynch
78	Kimberly S. Lazo
79	Patricia A. Brown
80	Hunter Gladish
81	Unknown Owner
82	Bryanna M. Schneider
83	Prairie Land Community Housing, INC
84	Marsha K. Mondell
85	Mark & Taylor Cooper
86	Dylan, Victoria & Danielle McKay
87	Elliot D. Park

PRINT DATE: 4/5/23  
 PLOT SCALE: 1:1  
 EDIT DATE: 2/16/23 - 1:31 PM  
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RECOMMENDED FOR APPROVAL _____ DESIGN ENGINEER _____ DATE _____	INDIANA DEPARTMENT OF TRANSPORTATION  PLAT NO. 1		HORIZONTAL SCALE	BRIDGE FILE
			1" = 100'	N/A
	DESIGNED: <u>BLW</u> CHECKED: <u>DCK</u>	DRAWN: <u>REW</u> CHECKED: <u>DCK</u>	VERTICAL SCALE N/A	DESIGNATION 2001828
		SURVEY BOOK _____	SHEET 9 of 117	
		CONTRACT R-43449	PROJECT 2001828	

PRINT DATE: 4/5/23  
 EDIT DATE: 2/22/23 - 11:52 AM  
 EDITOR: EKOWALSKI  
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 PLOT SCALE: 1:1

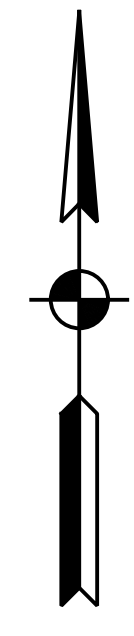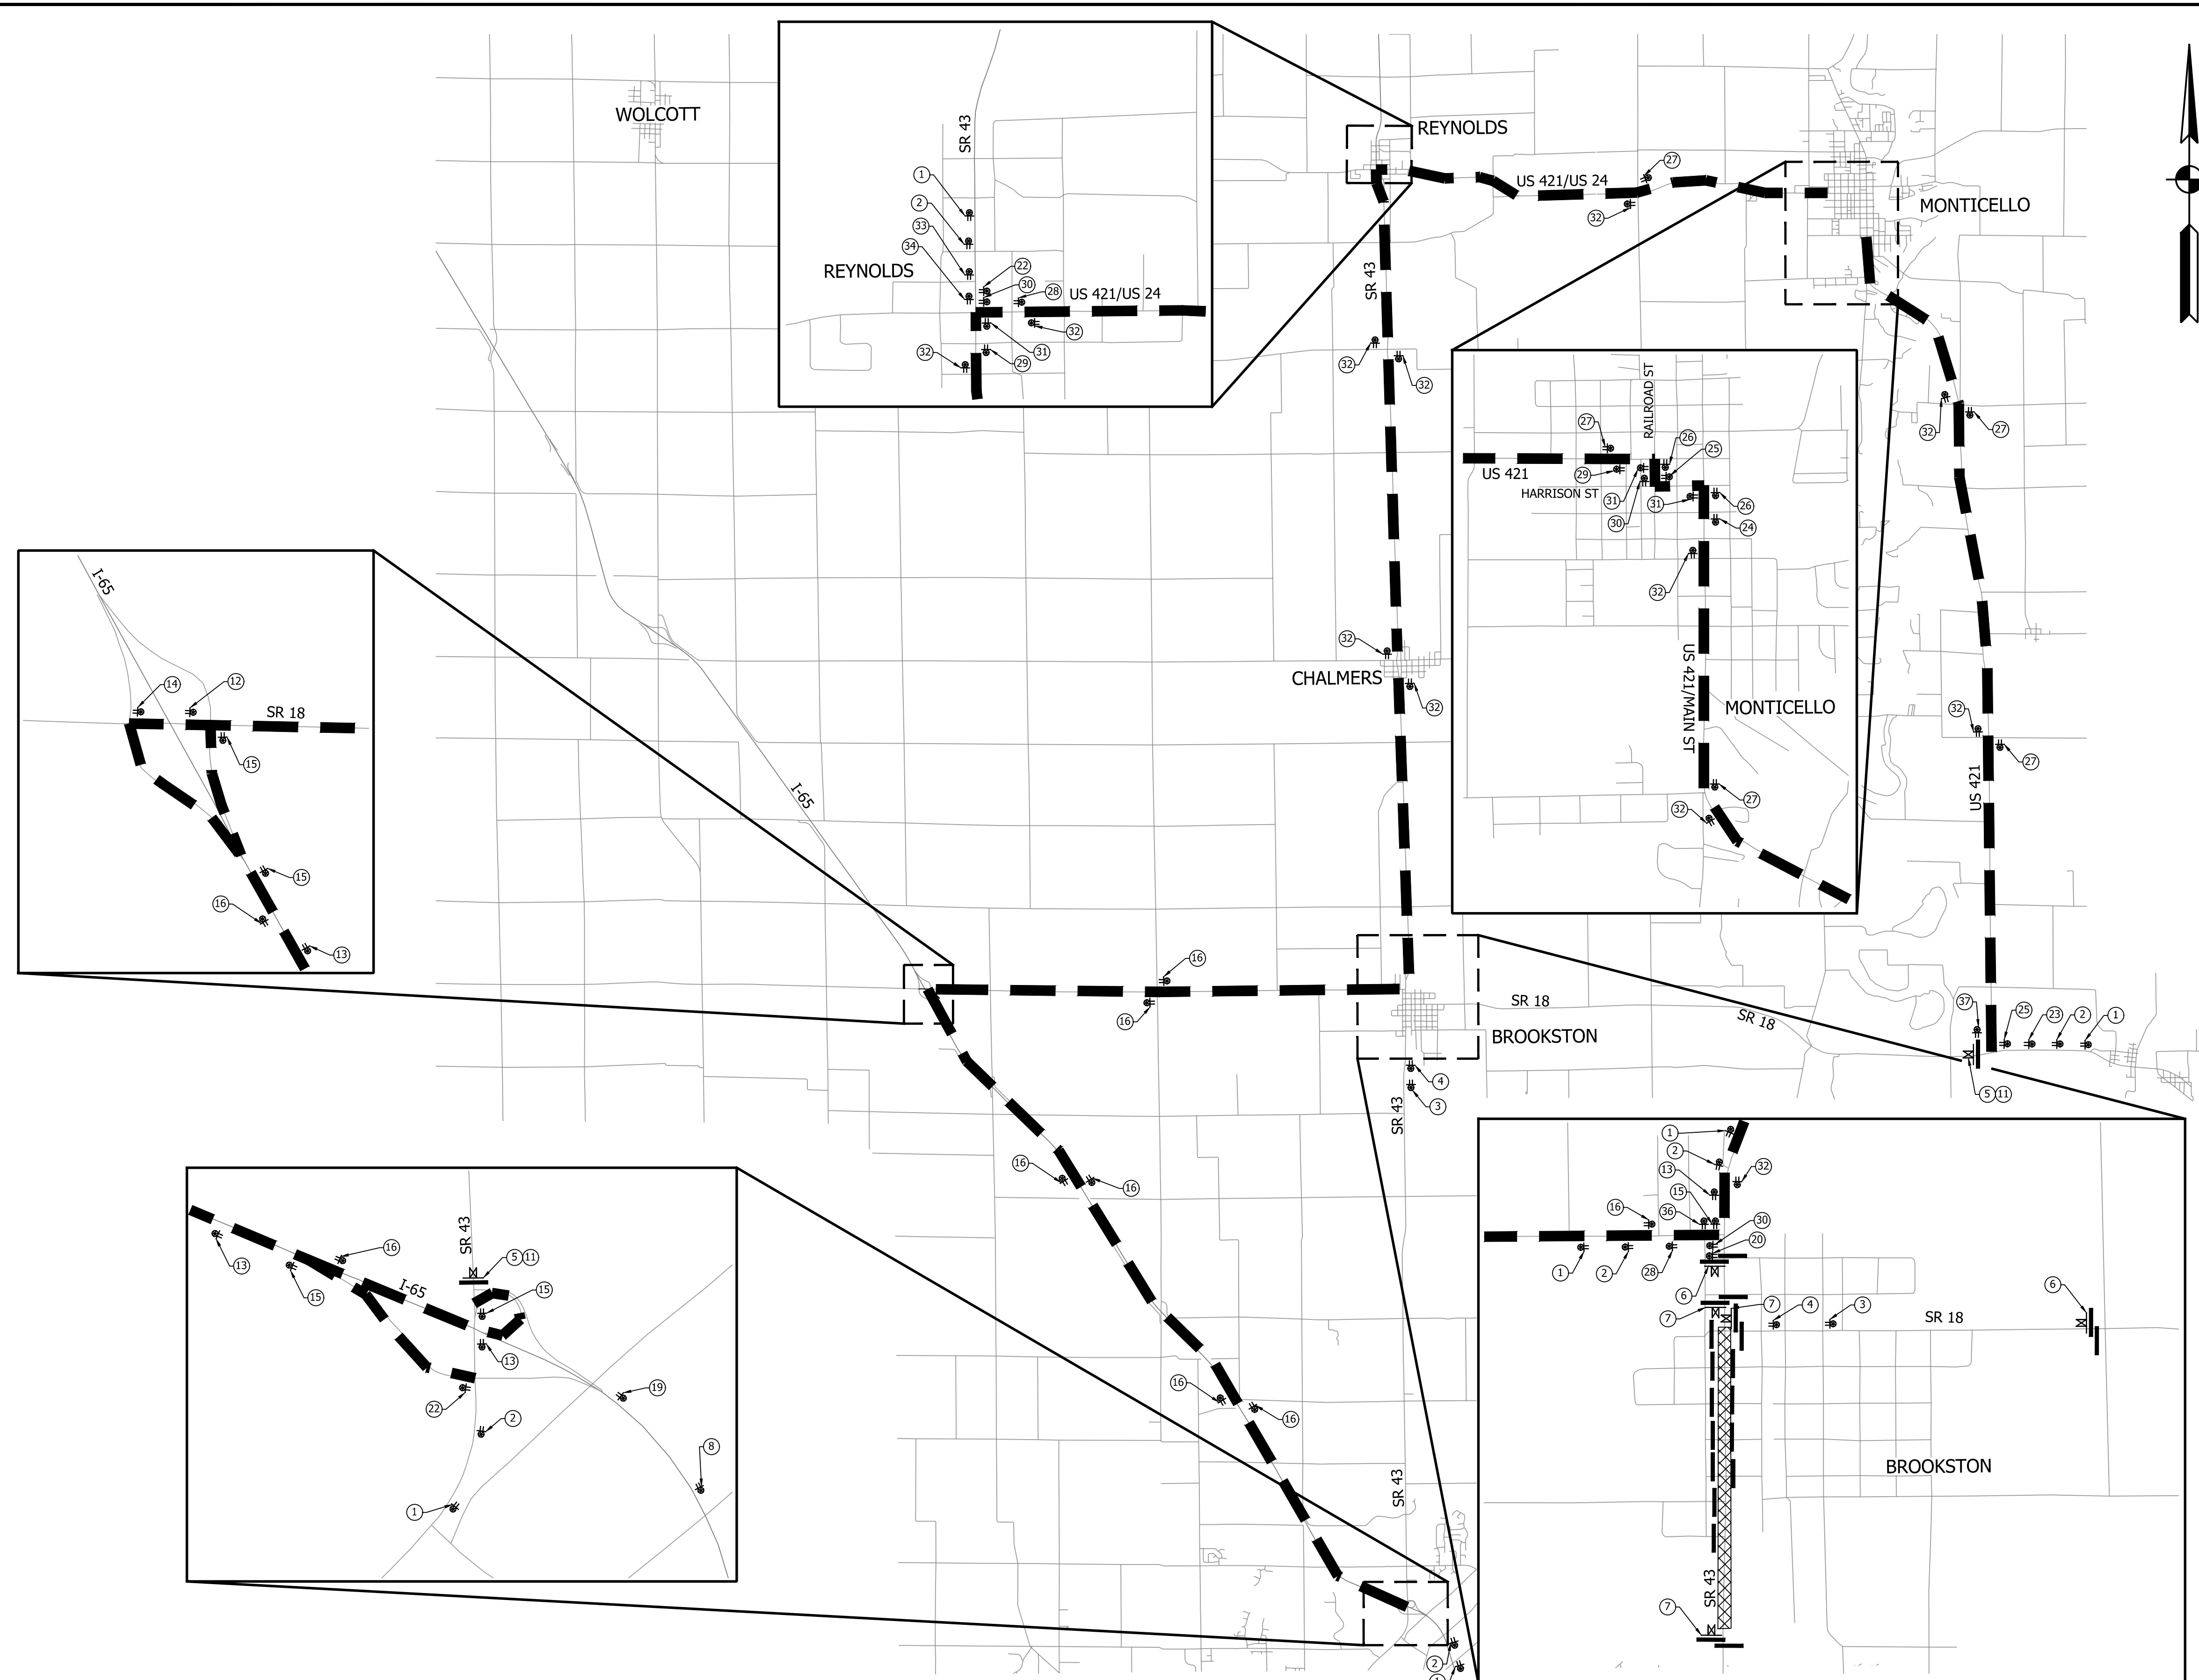








- LEGEND**
- ⊗ Construction Sign w/ Type "A" Light
  - TT Construction Sign
  - TT Road Closure Sign Assembly
  - Barricade Type III A or B (10')
  - ▨ Construction Area
  - Low Intensity Light
  - ⊗ High Intensity Light

NOTE: FOR DETOUR ROUTE SIGNS & ASSEMBLIES, SEE SHEET NO. 12

	RECOMMENDED FOR APPROVAL _____ DESIGN ENGINEER DATE	<b>INDIANA DEPARTMENT OF TRANSPORTATION</b>	HORIZONTAL SCALE	BRIDGE FILE
			NONE	N/A
			VERTICAL SCALE	DESIGNATION
			N/A	2001828
			SURVEY BOOK	SHEET
				10 of 117
			CONTRACT	PROJECT
			R-43449	2001828
DESIGNED: <u>BLW</u> DRAWN: <u>REW</u> CHECKED: <u>DCK</u> CHECKED: <u>DCK</u>		<b>DETOUR ROUTE PHASE I</b>		





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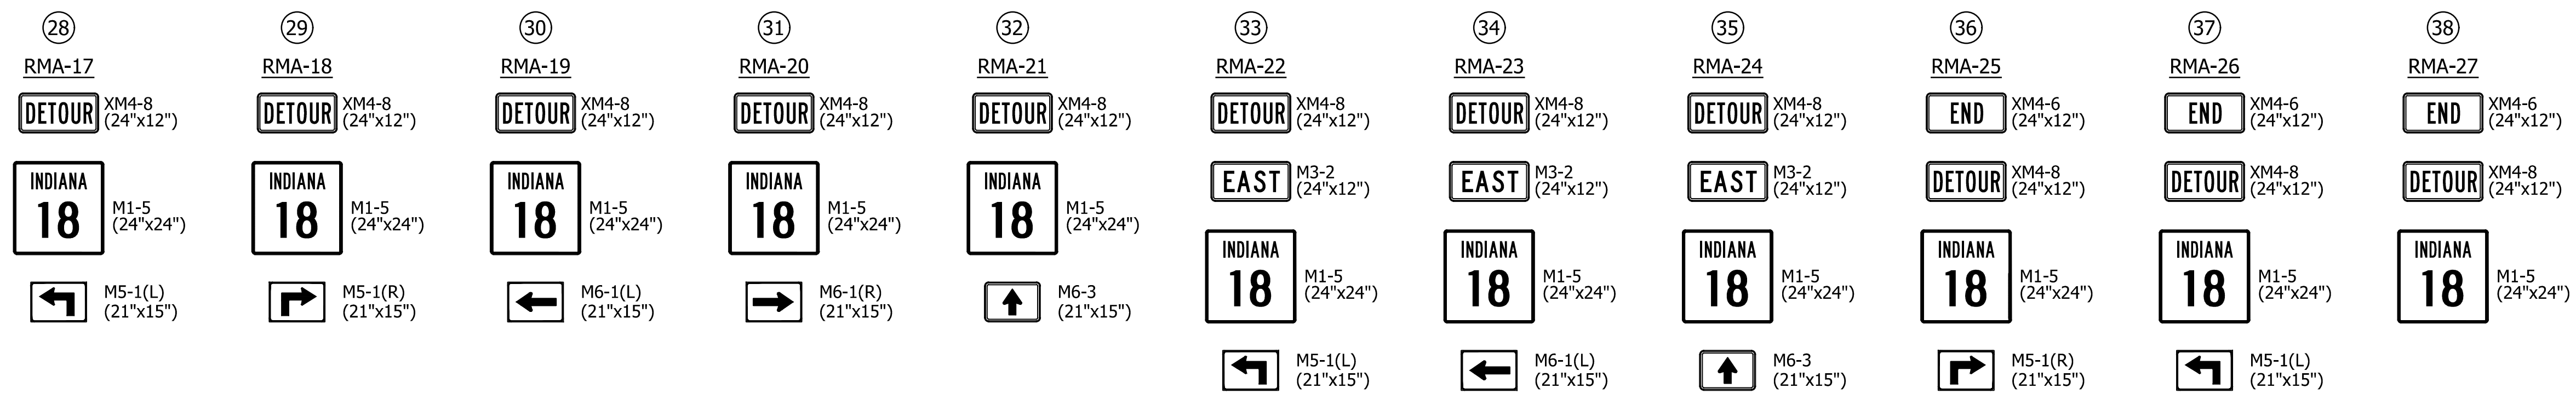
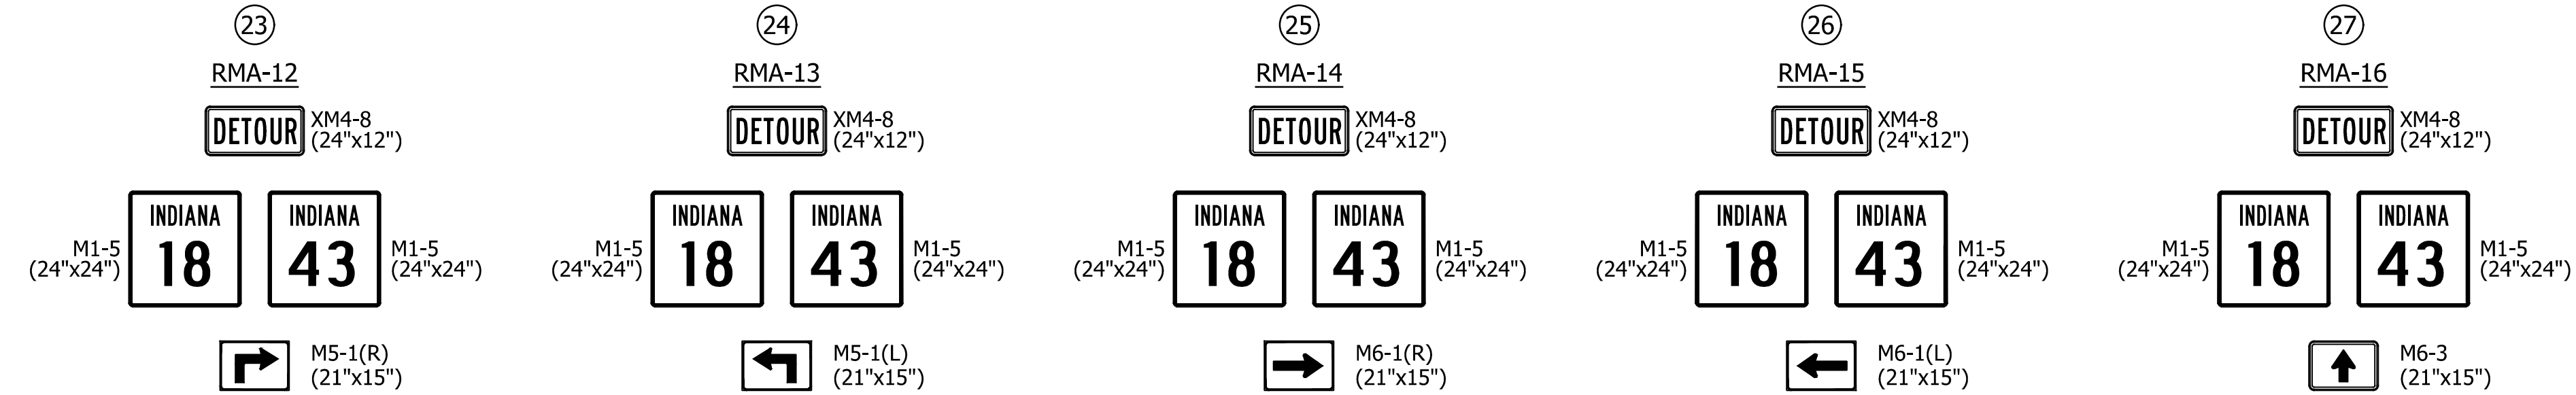
- LEGEND**
- ⊗ Construction Sign w/ Type "A" Light
  - ⊕ Construction Sign
  - ⊘ Road Closure Sign Assembly
  - Barricade Type III A or B (10')
  - ▨ Construction Area
  - Low Intensity Light
  - ⊗ High Intensity Light

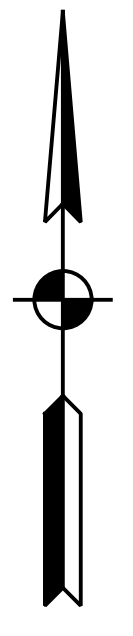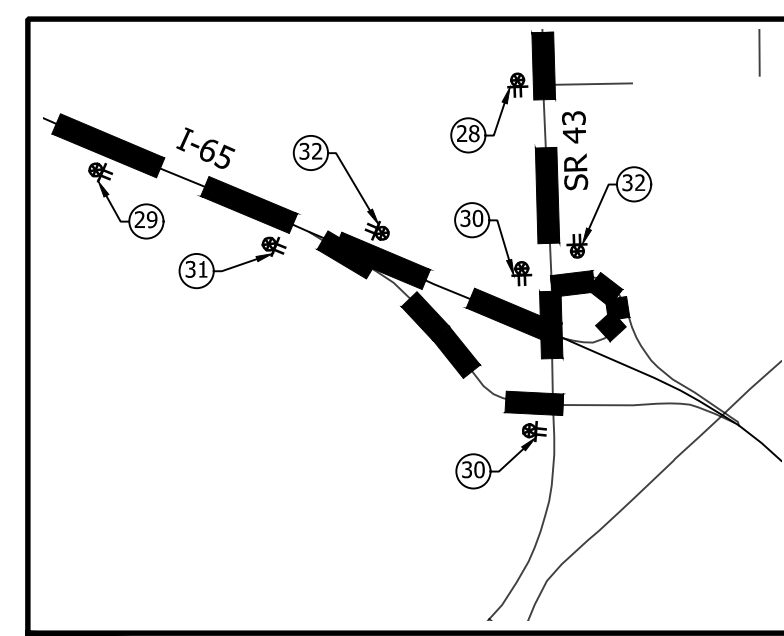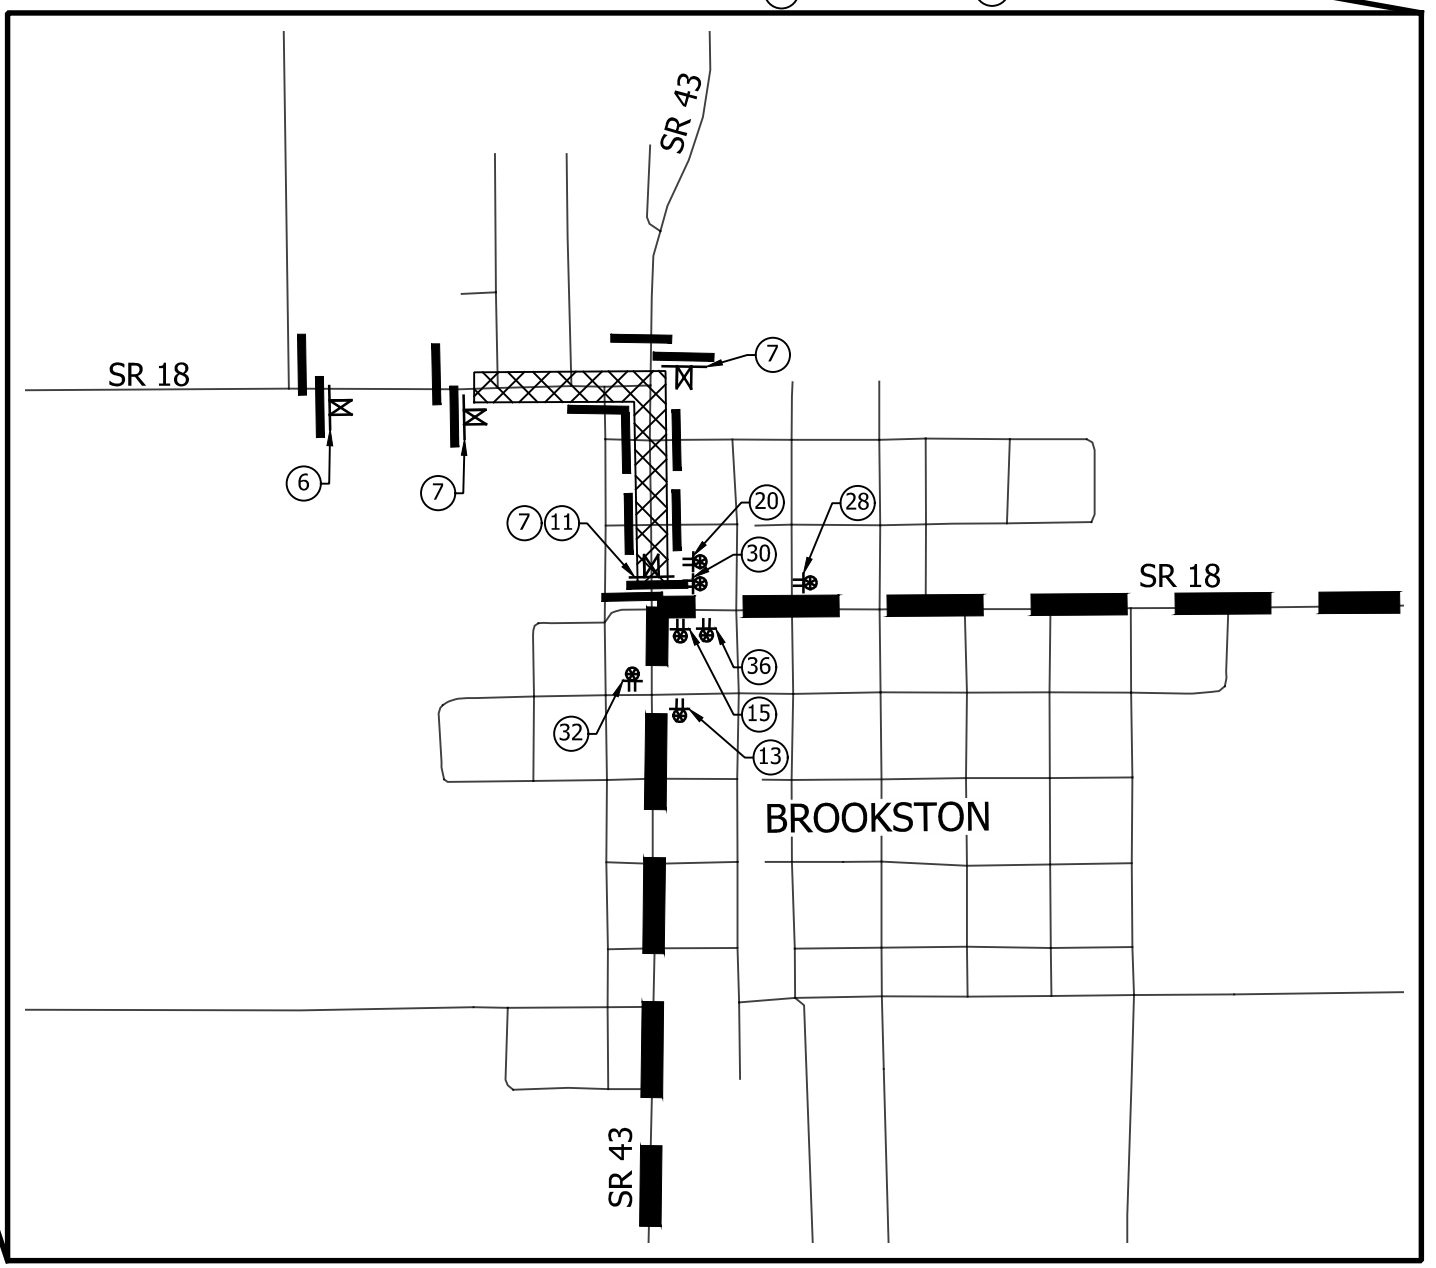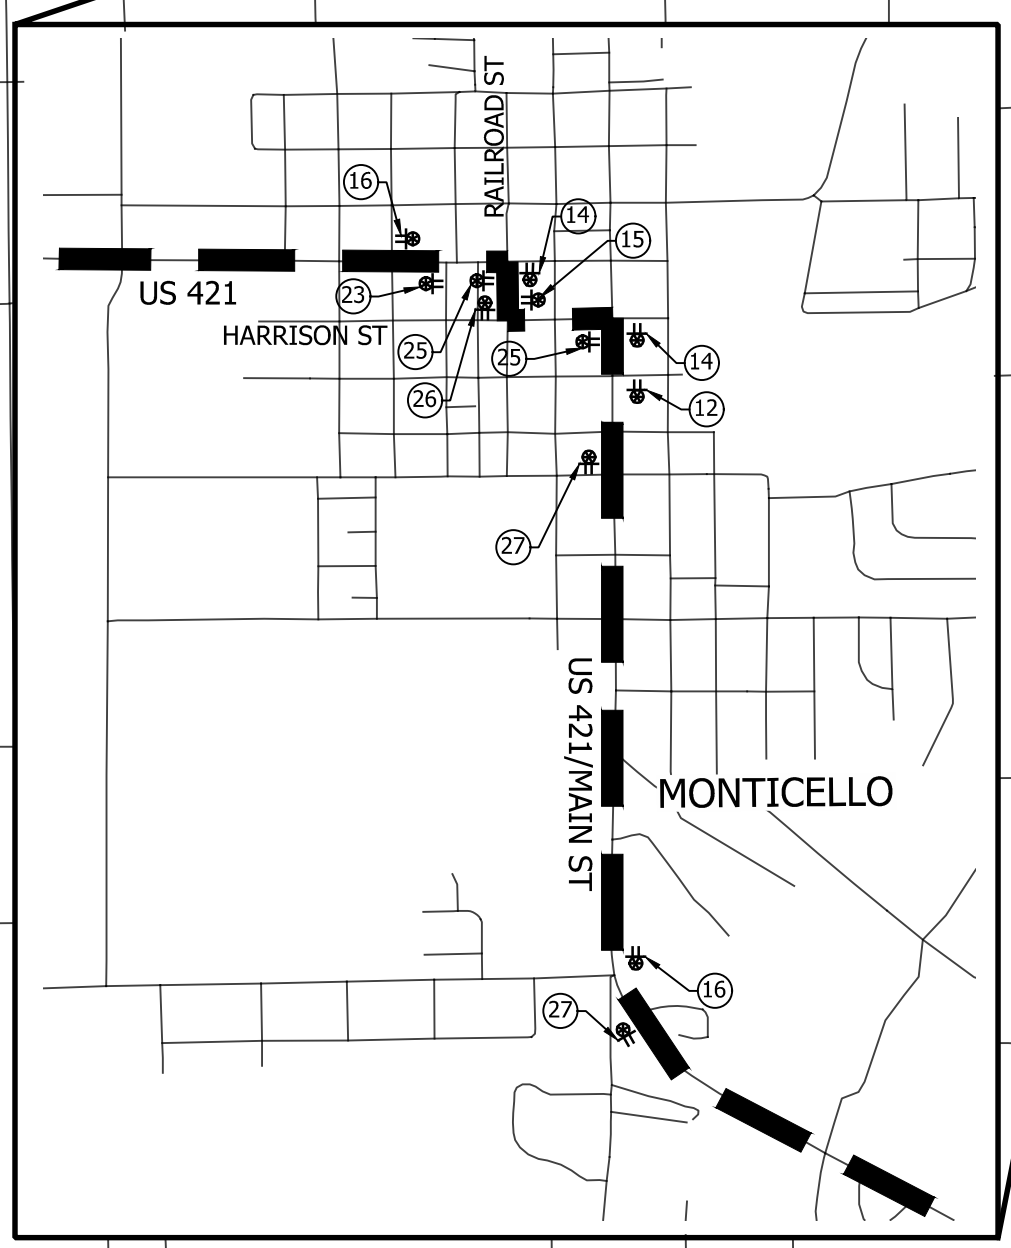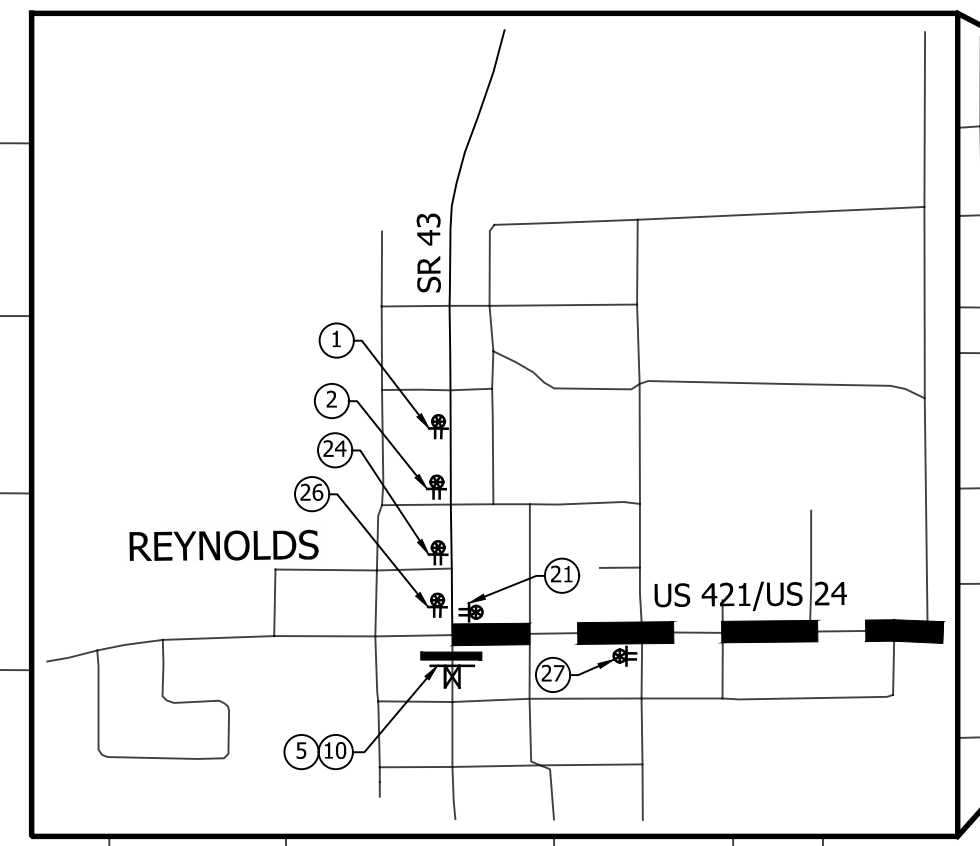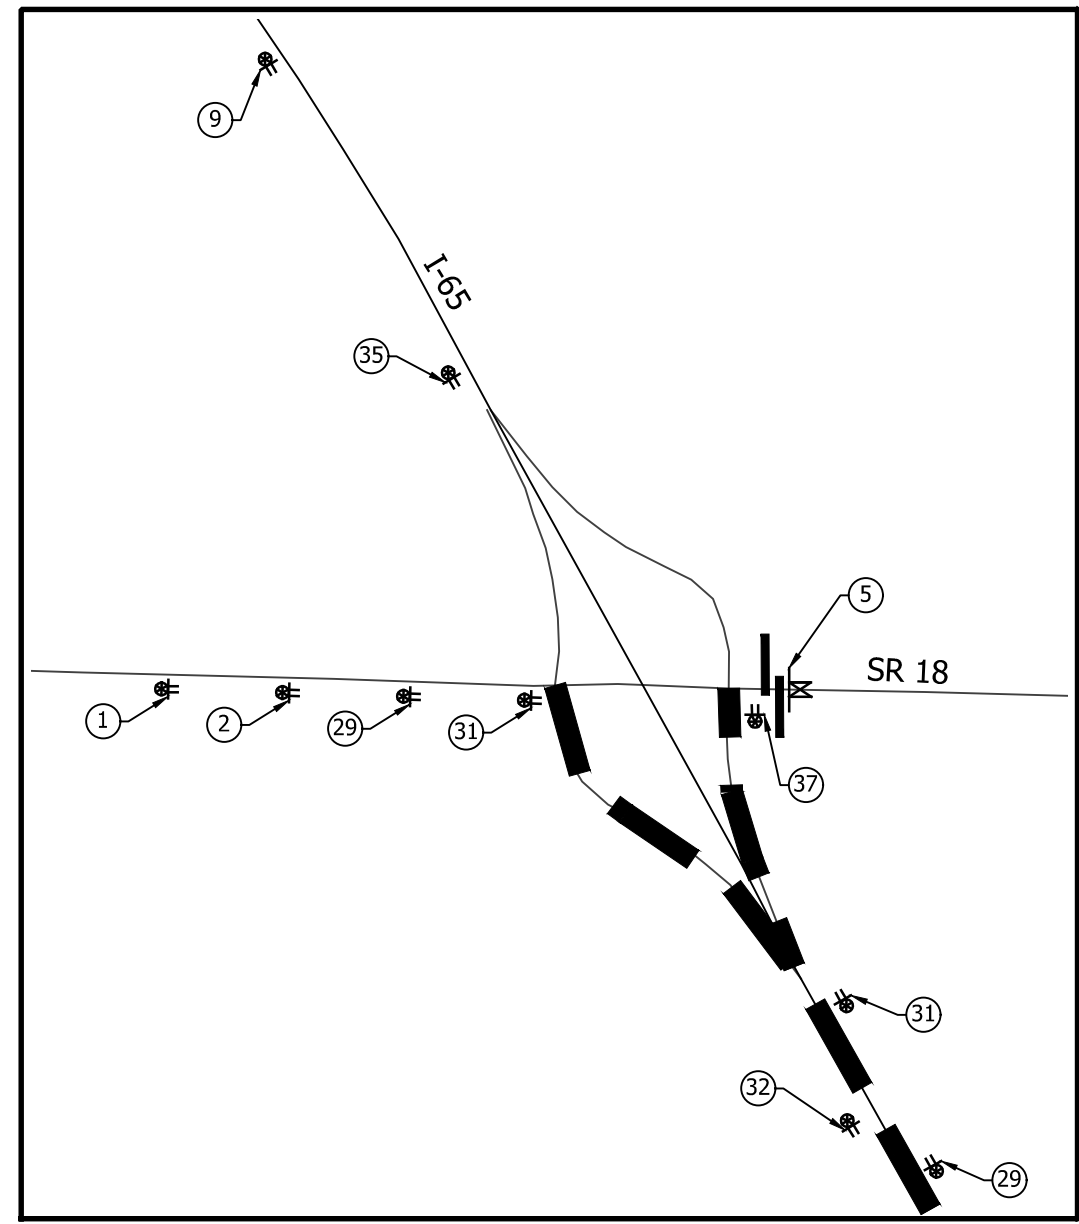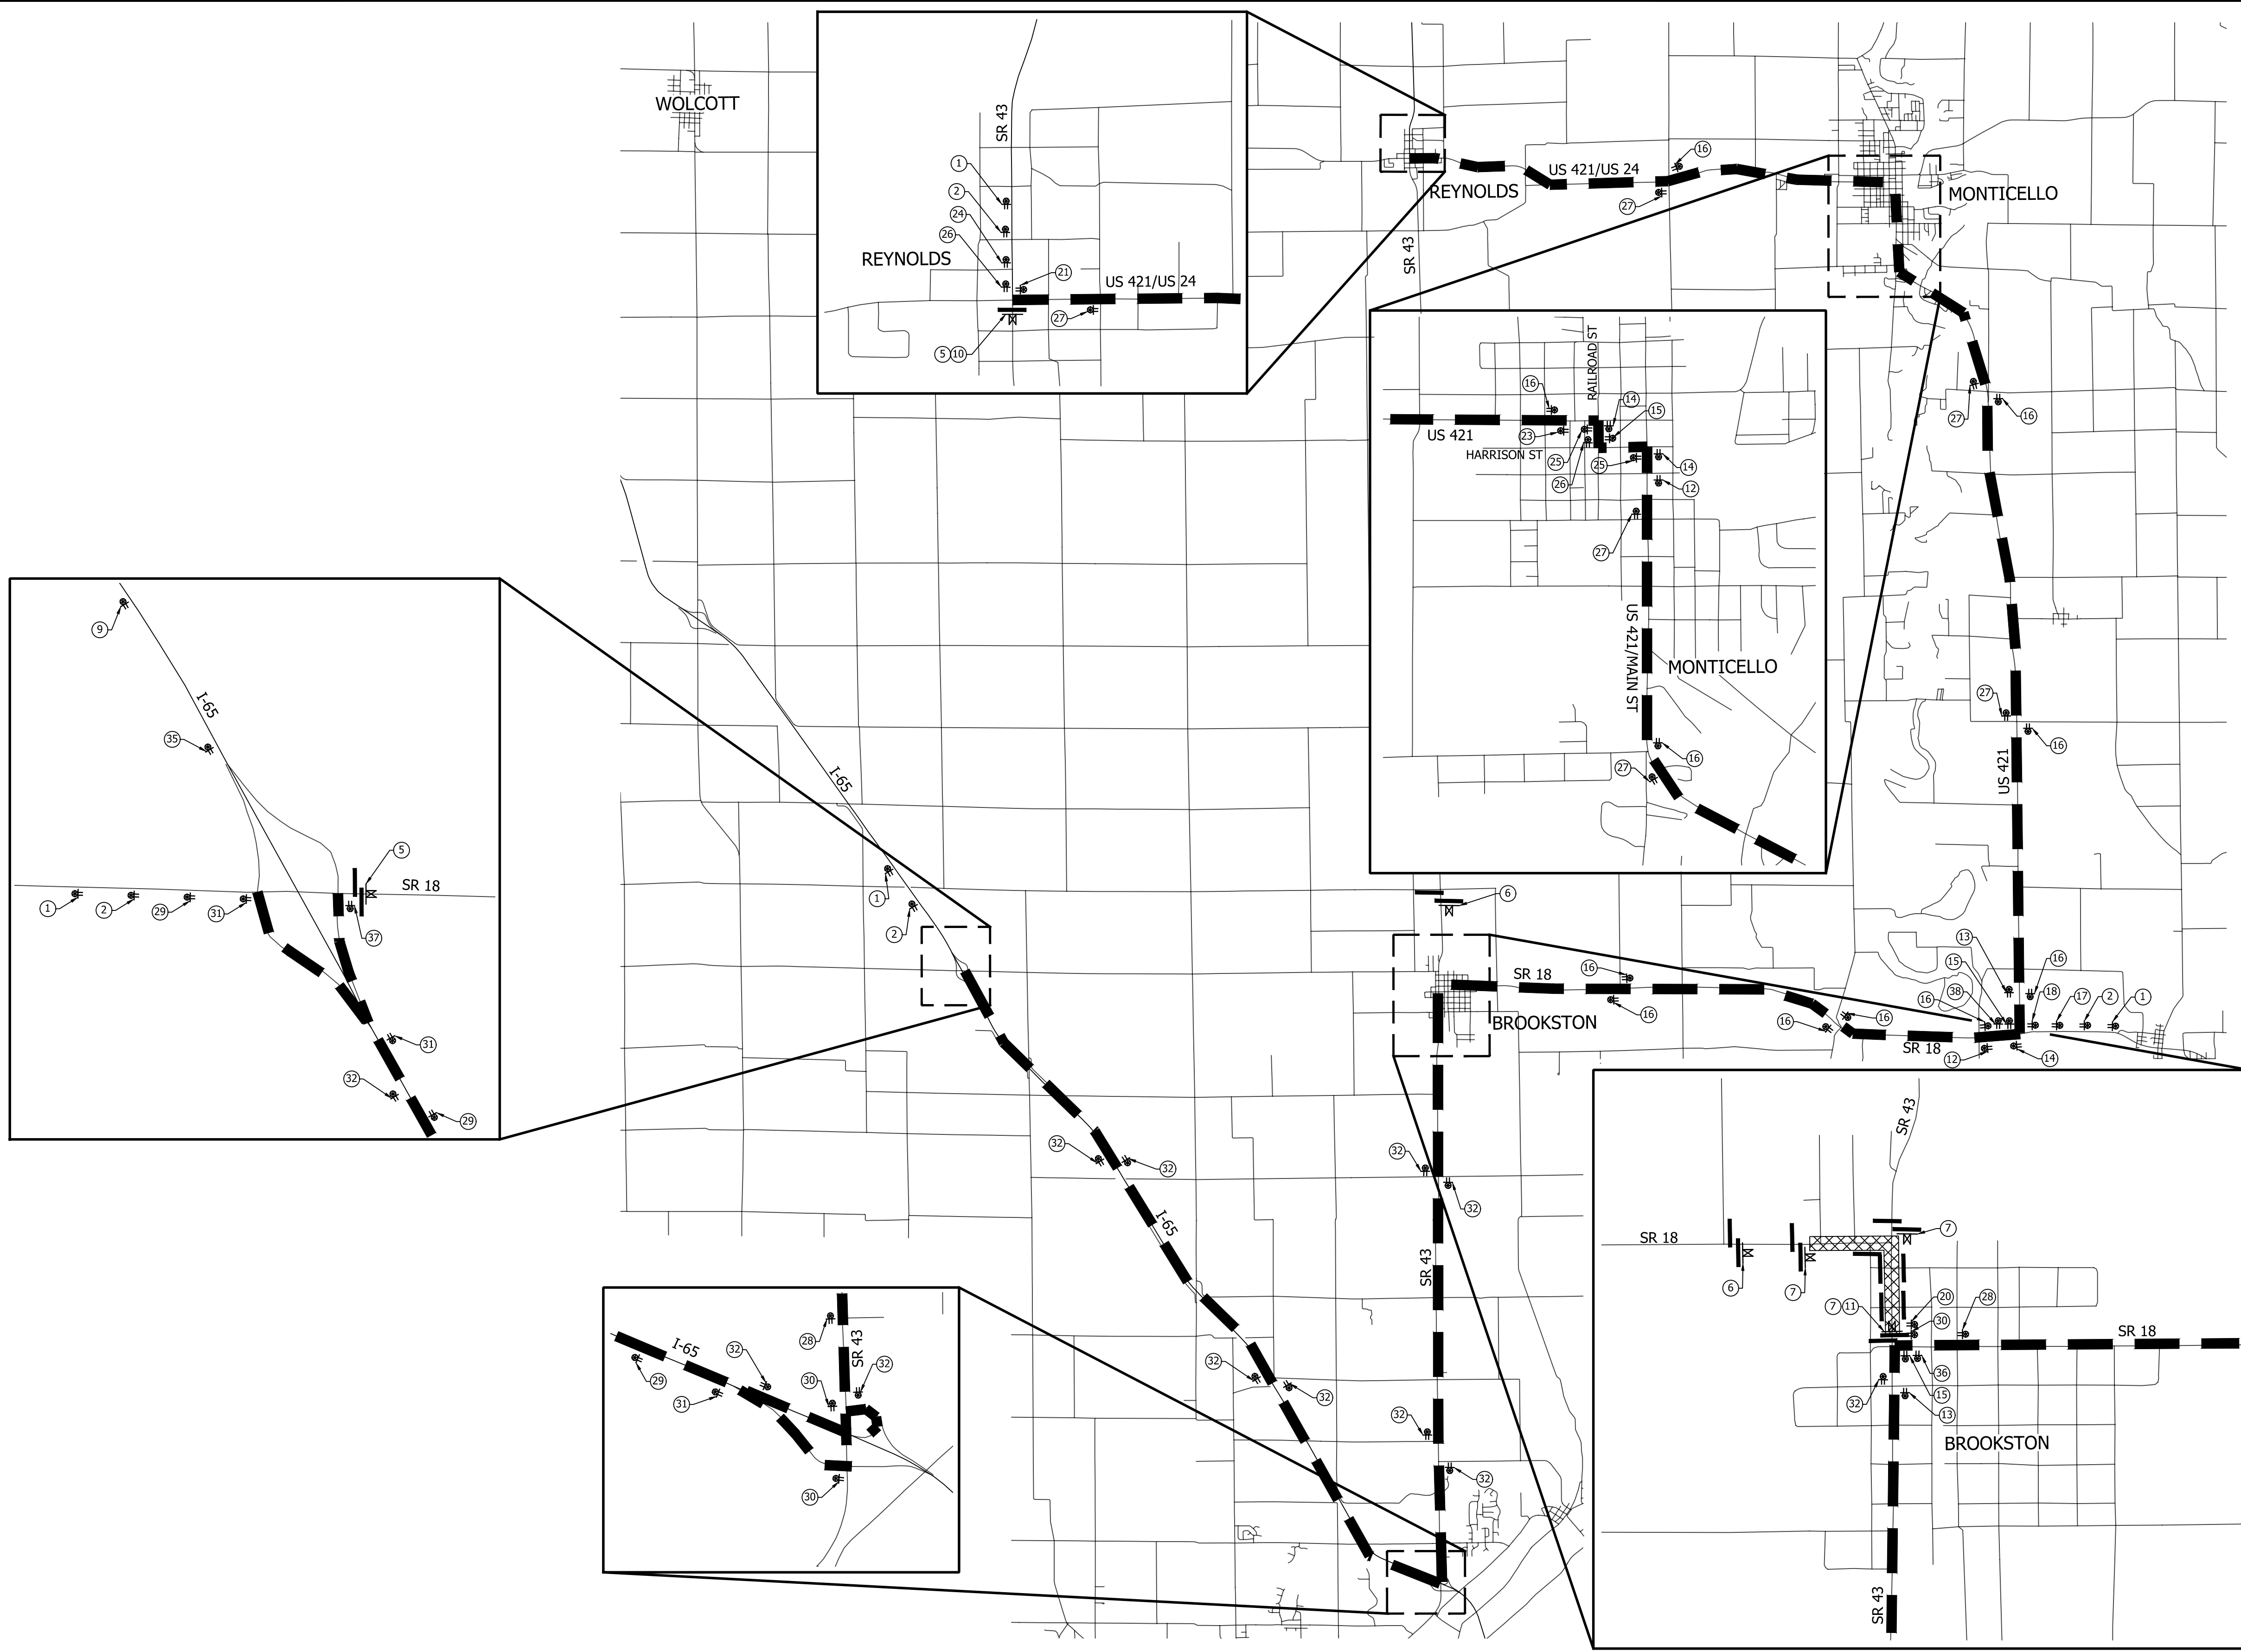NOTE: FOR DETOUR ROUTE SIGNS & ASSEMBLIES, SEE SHEET NO. 12

	RECOMMENDED FOR APPROVAL _____ DESIGN ENGINEER DATE	<b>INDIANA DEPARTMENT OF TRANSPORTATION</b>	HORIZONTAL SCALE N/A BRIDGE FILE N/A
	DESIGNED: <u>BLW</u> DRAWN: <u>REW</u>	<b>DETOUR ROUTE PHASE II</b>	VERTICAL SCALE N/A DESIGNATION 2001828
	CHECKED: <u>DCK</u> CHECKED: <u>DCK</u>		SURVEY BOOK SHEET _____ 11 of 117
			CONTRACT PROJECT R-43449 2001828




MAINTENANCE OF TRAFFIC QUANTITIES								
	Vehicular Phase I	Vehicular Phase II	Pedestrian E. Parallel Only	Pedestrian W. Parallel Only	Pedestrian E. Parallel & Perpendicular	Pedestrian W. Parallel & Perpendicular	Quantity	Unit
Road Closure Sign Assembly	8	8					8	EACH
Detour Route Marker Assembly	61	64					125	EACH
Construction Sign, Type A	16	8					16	EACH
Construction Sign, Type B			6	6	16	16	16	EACH
Type III-B Barricade (6')			12	12	36	36	36	LFT
Type III-B Barricade (10')	230	180					230	LFT

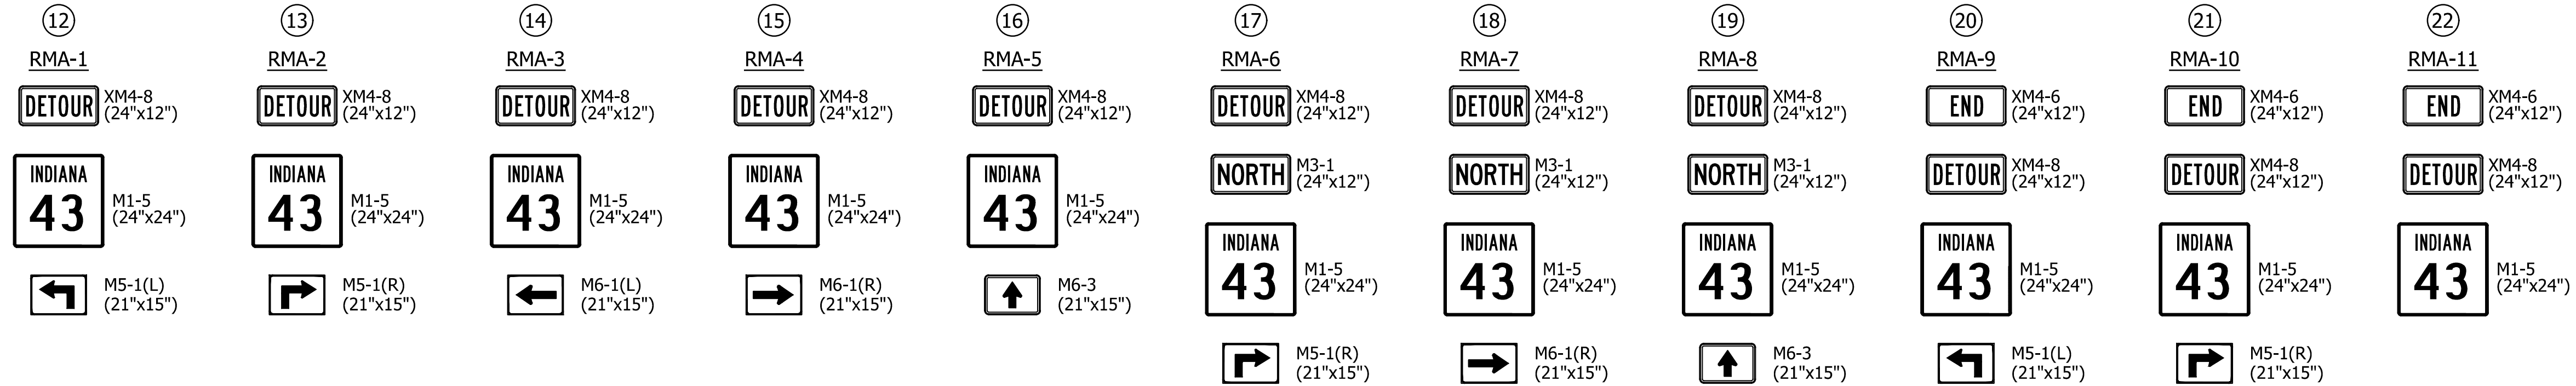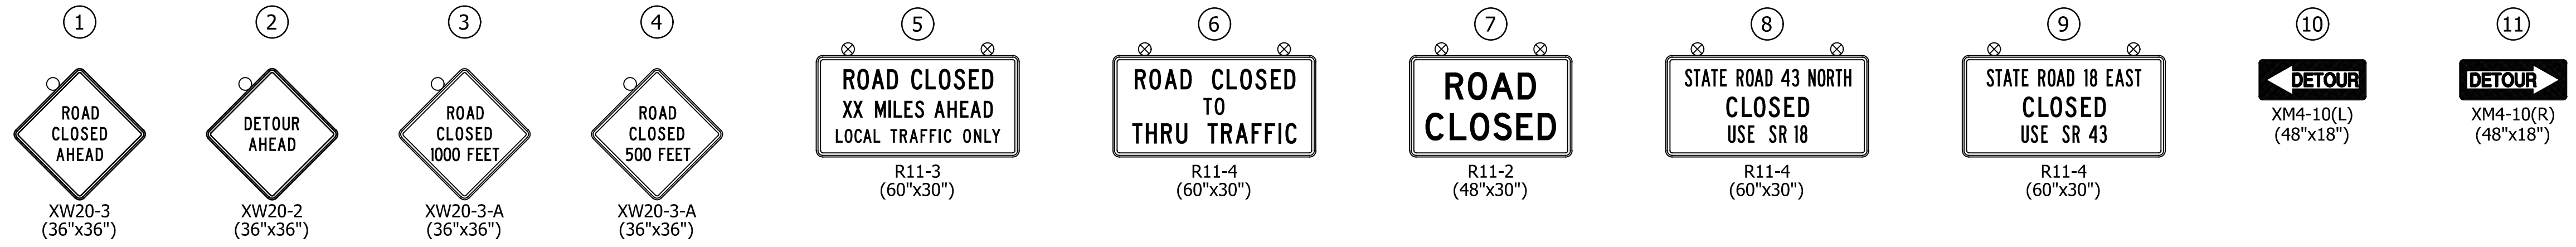


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RECOMMENDED FOR APPROVAL _____ DESIGN ENGINEER DATE		INDIANA DEPARTMENT OF TRANSPORTATION	HORIZONTAL SCALE	BRIDGE FILE
DESIGNED: <u>BLW</u> DRAWN: <u>REW</u>			NONE	N/A
CHECKED: <u>DCK</u> CHECKED: <u>DCK</u>		DETOUR ROUTE SIGNS & ASSEMBLIES	VERTICAL SCALE	DESIGNATION
			N/A	2001828
			SURVEY BOOK	SHEET
			12 of 117	
		CONTRACT	PROJECT	
		R-43449	2001828	

PRINT DATE: 4/5/23  
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**EAST SIDE CONSTRUCTION WITH PARALLEL SIDEWALKS ONLY**

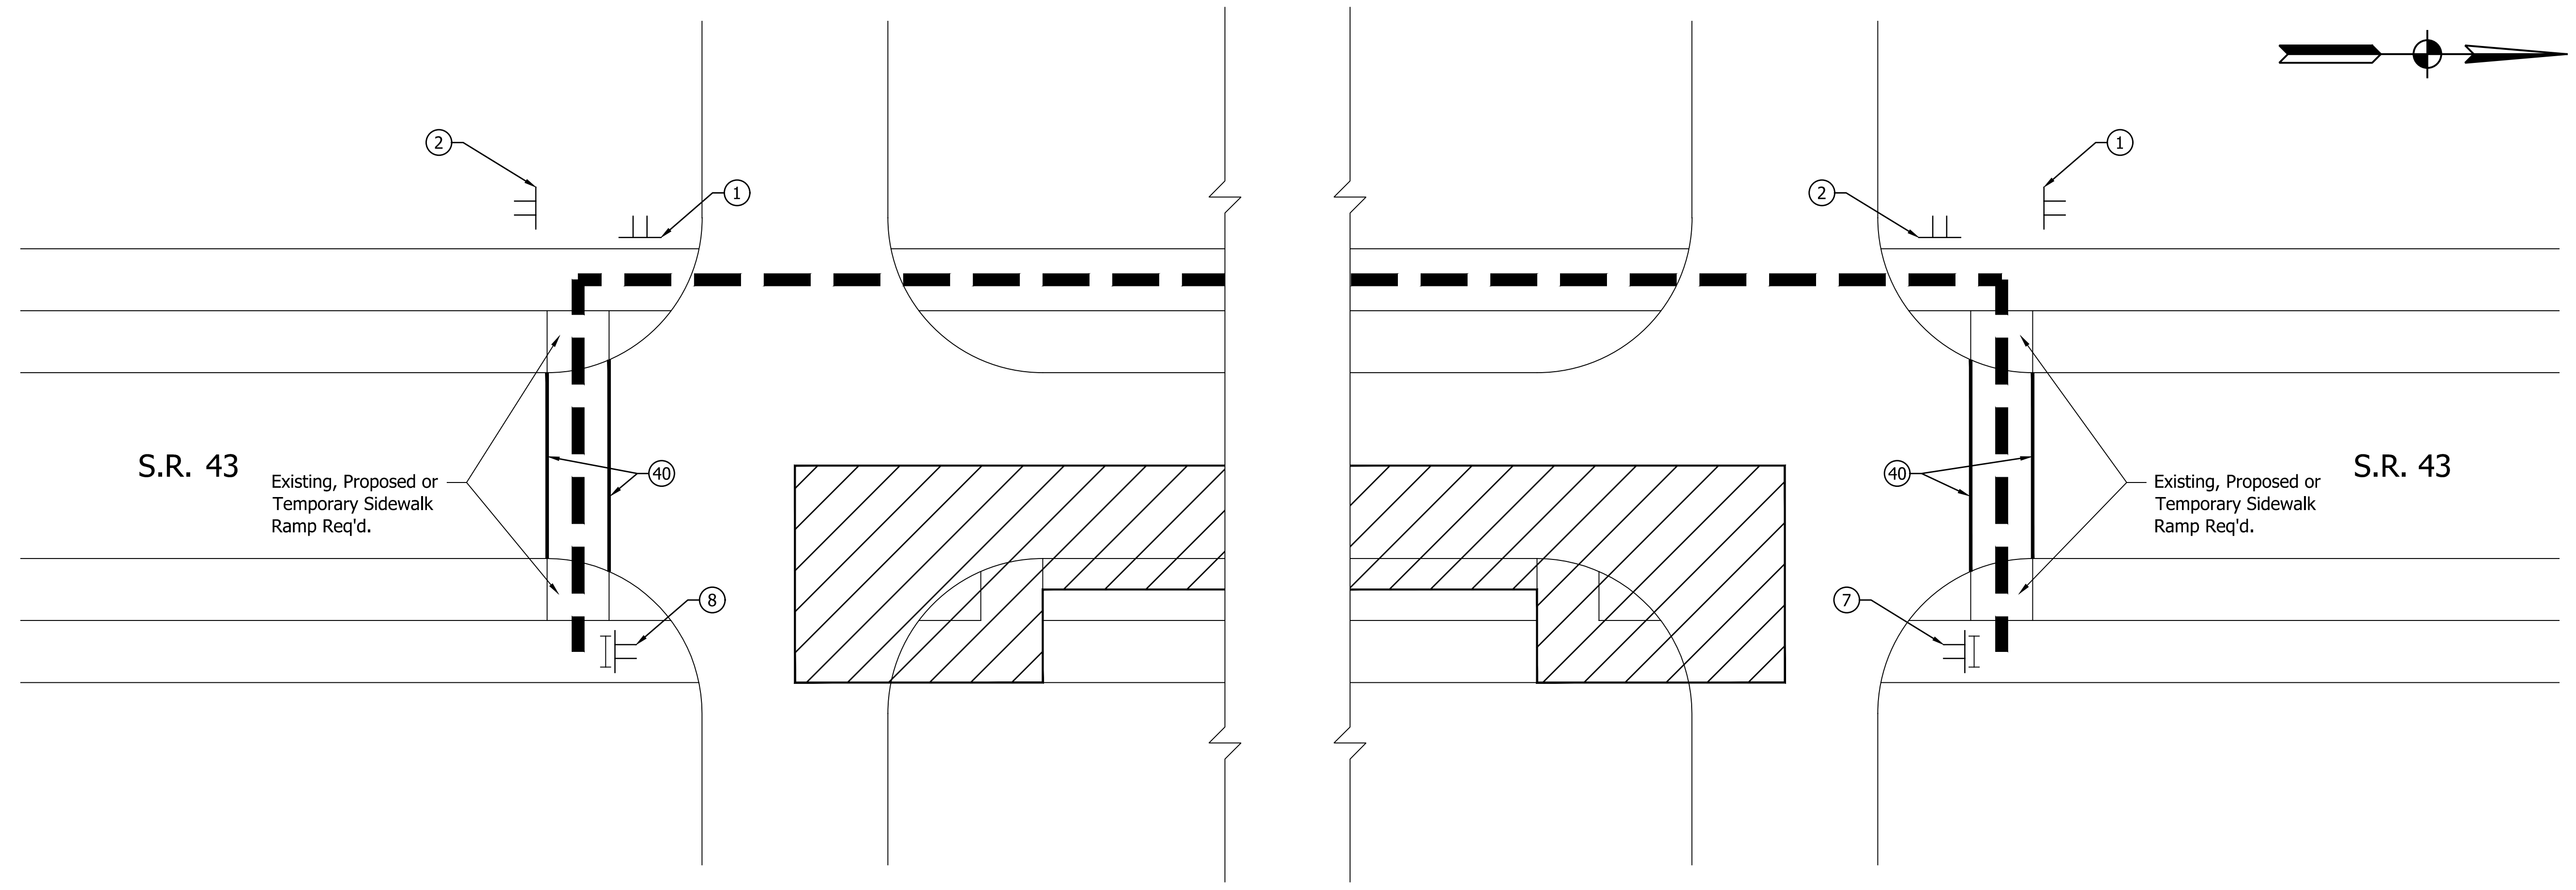


- LEGEND**
- AREA OF CONSTRUCTION
  - TEMPORARY CURB RAMP
  - PEDESTRIAN DETOUR ROUTE
  - TYPE III-B BARRICADE (6')
  - CONSTRUCTION SIGN
  - TEMPORARY PAVEMENT MARKING, REMOVABLE 6" (WHITE)

- NOTES:**
1. ONLY ONE RAMP PER BLOCK SHALL BE CLOSED AT ANY GIVEN TIME.
  2. THIS TYPICAL APPLIES TO THE ENTIRE CORRIDOR WHERE APPLICABLE.

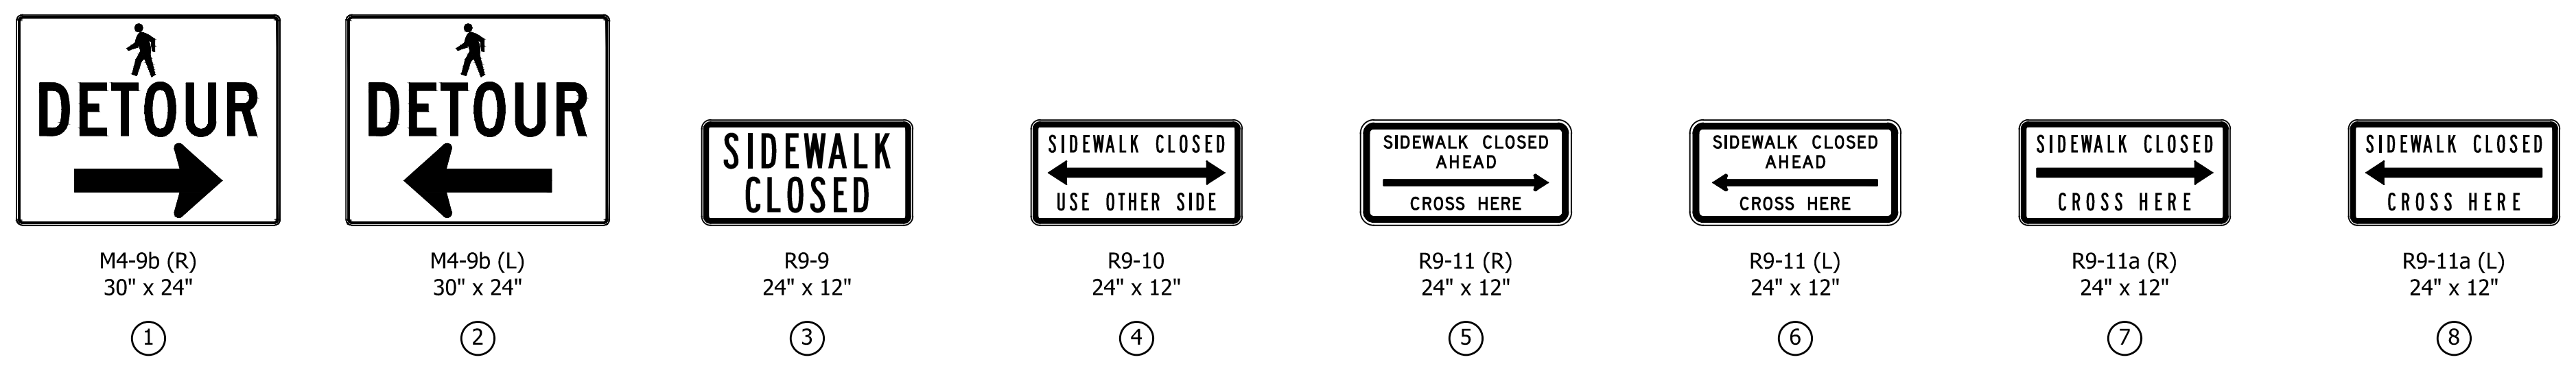	RECOMMENDED FOR APPROVAL _____ DESIGN ENGINEER DATE	<b>INDIANA DEPARTMENT OF TRANSPORTATION</b>	HORIZONTAL SCALE NONE BRIDGE FILE N/A
	DESIGNED: <u>BLW</u> DRAWN: <u>REW</u>	<b>MAINTENANCE OF TRAFFIC TYPICAL PEDESTRIAN DETOUR</b>	VERTICAL SCALE N/A DESIGNATION 2001828
	CHECKED: <u>DCK</u> CHECKED: <u>DCK</u>		SURVEY BOOK SHEET 13 of 117
			CONTRACT PROJECT R-43449 2001828



PRINT DATE: 4/5/23  
 PLOT SCALE: 1:1  
 EDIT DATE: 8/9/22 - 10:55 AM  
 EDITED BY: RWILSON  
 DRAWING FILE: P:\21-500-155-1 WHITE CO PAVEMENT REPLACEMENT 21010815 ACADUS MOTRD\_MOT\_PEDESTRIAN.DWG

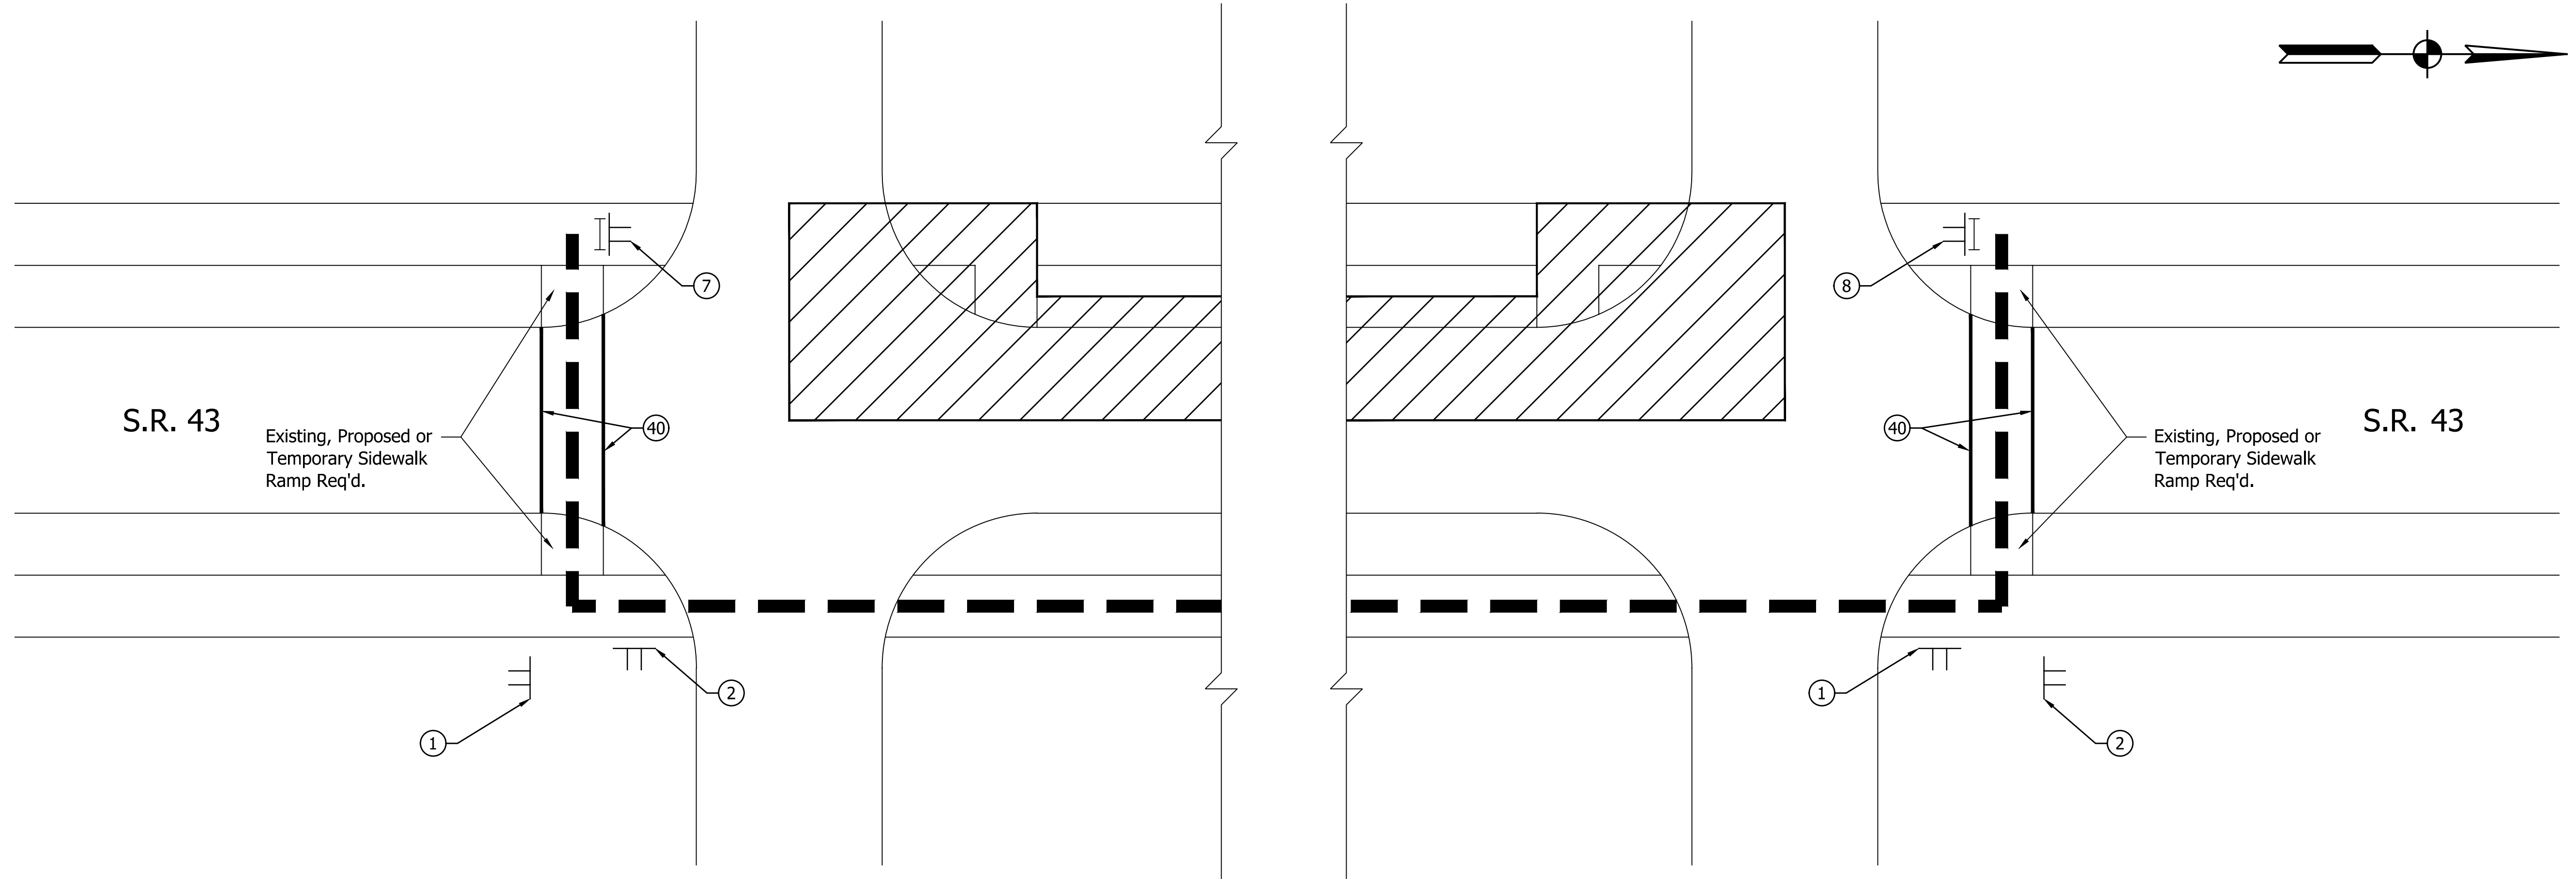

**WEST SIDE CONSTRUCTION WITH PARALLEL SIDEWALKS ONLY**


- ①
- ②
- ③
- ④
- ⑤
- ⑥
- ⑦
- ⑧

- LEGEND**
- AREA OF CONSTRUCTION
  - TEMPORARY CURB RAMP
  - PEDESTRIAN DETOUR ROUTE
  - TYPE III-B BARRICADE (6')
  - CONSTRUCTION SIGN
  - TEMPORARY PAVEMENT MARKING, REMOVABLE 6" (WHITE)

- NOTES:**
1. ONLY ONE RAMP PER BLOCK SHALL BE CLOSED AT ANY GIVEN TIME.
  2. THIS TYPICAL APPLIES TO THE ENTIRE CORRIDOR WHERE APPLICABLE.

	RECOMMENDED FOR APPROVAL _____ DESIGN ENGINEER DATE	<b>INDIANA DEPARTMENT OF TRANSPORTATION</b>	HORIZONTAL SCALE NONE	BRIDGE FILE N/A
	DESIGNED: <u>BLW</u> DRAWN: <u>REW</u>	<b>MAINTENANCE OF TRAFFIC TYPICAL PEDESTRIAN DETOUR</b>	VERTICAL SCALE N/A	DESIGNATION 2001828
	CHECKED: <u>DCK</u> CHECKED: <u>DCK</u>		SURVEY BOOK	SHEET 14 of 117
			CONTRACT R-43449	PROJECT 2001828

PRINT DATE: 4/5/23  
 PLOT SCALE: 1:1  
 DRAWING FILE: P:\121-500-155-1 WHITE CO PAVEMENT REPLACEMENT 21010815 ACADUS MOTRD\_MOT\_PEDSTRAN.DWG  
 EDITED BY: RWILSON  
 DATE: 8/9/22 - 10:55 AM

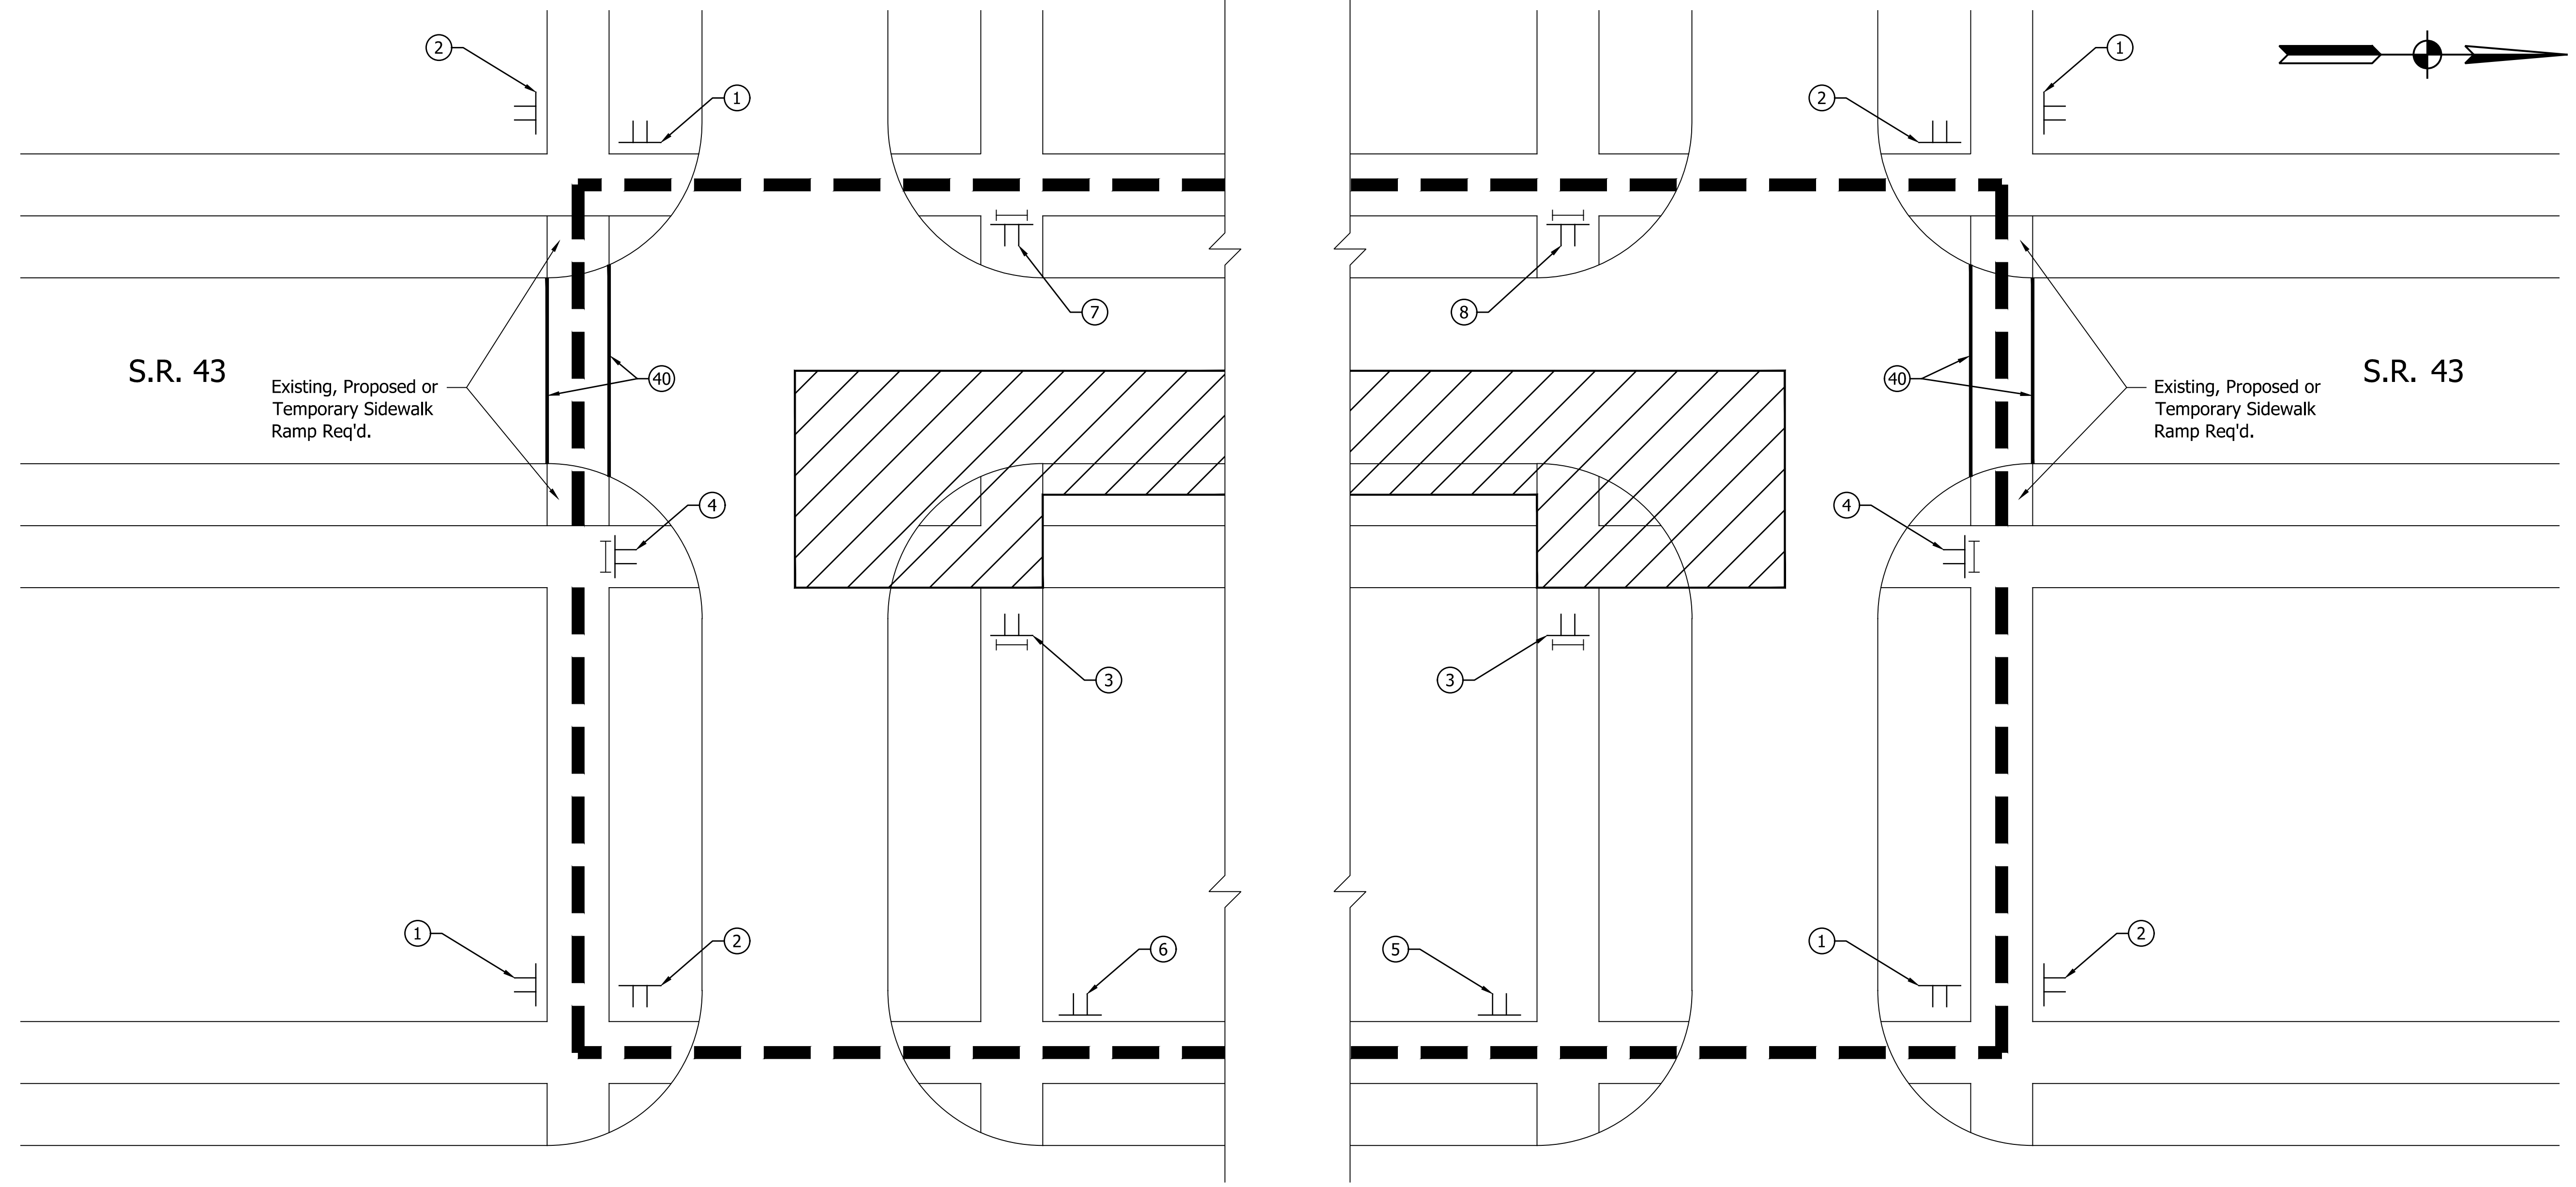

**EAST SIDE CONSTRUCTION WITH PARALLEL & PERPENDICULAR SIDEWALKS**

- NOTES:**
- ONLY ONE RAMP PER BLOCK SHALL BE CLOSED AT ANY GIVEN TIME.
  - THIS TYPICAL APPLIES TO THE ENTIRE CORRIDOR WHERE APPLICABLE.


①	②	③	④	⑤	⑥	⑦	⑧

**LEGEND**

- AREA OF CONSTRUCTION
- TEMPORARY CURB RAMP
- PEDESTRIAN DETOUR ROUTE
- TYPE III-B BARRICADE (6')
- CONSTRUCTION SIGN
- TEMPORARY PAVEMENT MARKING, REMOVABLE 6" (WHITE)

	RECOMMENDED FOR APPROVAL	DESIGN ENGINEER	DATE	<b>INDIANA DEPARTMENT OF TRANSPORTATION</b>  <b>MAINTENANCE OF TRAFFIC</b> <b>TYPICAL PEDESTRIAN DETOUR</b>	HORIZONTAL SCALE	BRIDGE FILE
	DESIGNED: <u>BLW</u>	DRAWN: <u>REW</u>	CHECKED: <u>DCK</u>		CHECKED: <u>DCK</u>	NONE
					VERTICAL SCALE	DESIGNATION
					N/A	2001828
					SURVEY BOOK	SHEET
					CONTRACT	15 of 117
					R-43449	PROJECT
						2001828

PRINT DATE: 4/5/23  
 PLOT SCALE: 1:1  
 EDIT DATE: 8/9/22 - 10:55 AM  
 EDITED BY: RWILSON  
 DRAWING FILE: P:\121-500-155-1 WHITE CO PAVEMENT REPLACEMENT 21010815 ACADUS MOTRD\_MOT\_PEDSTRAN.DWG

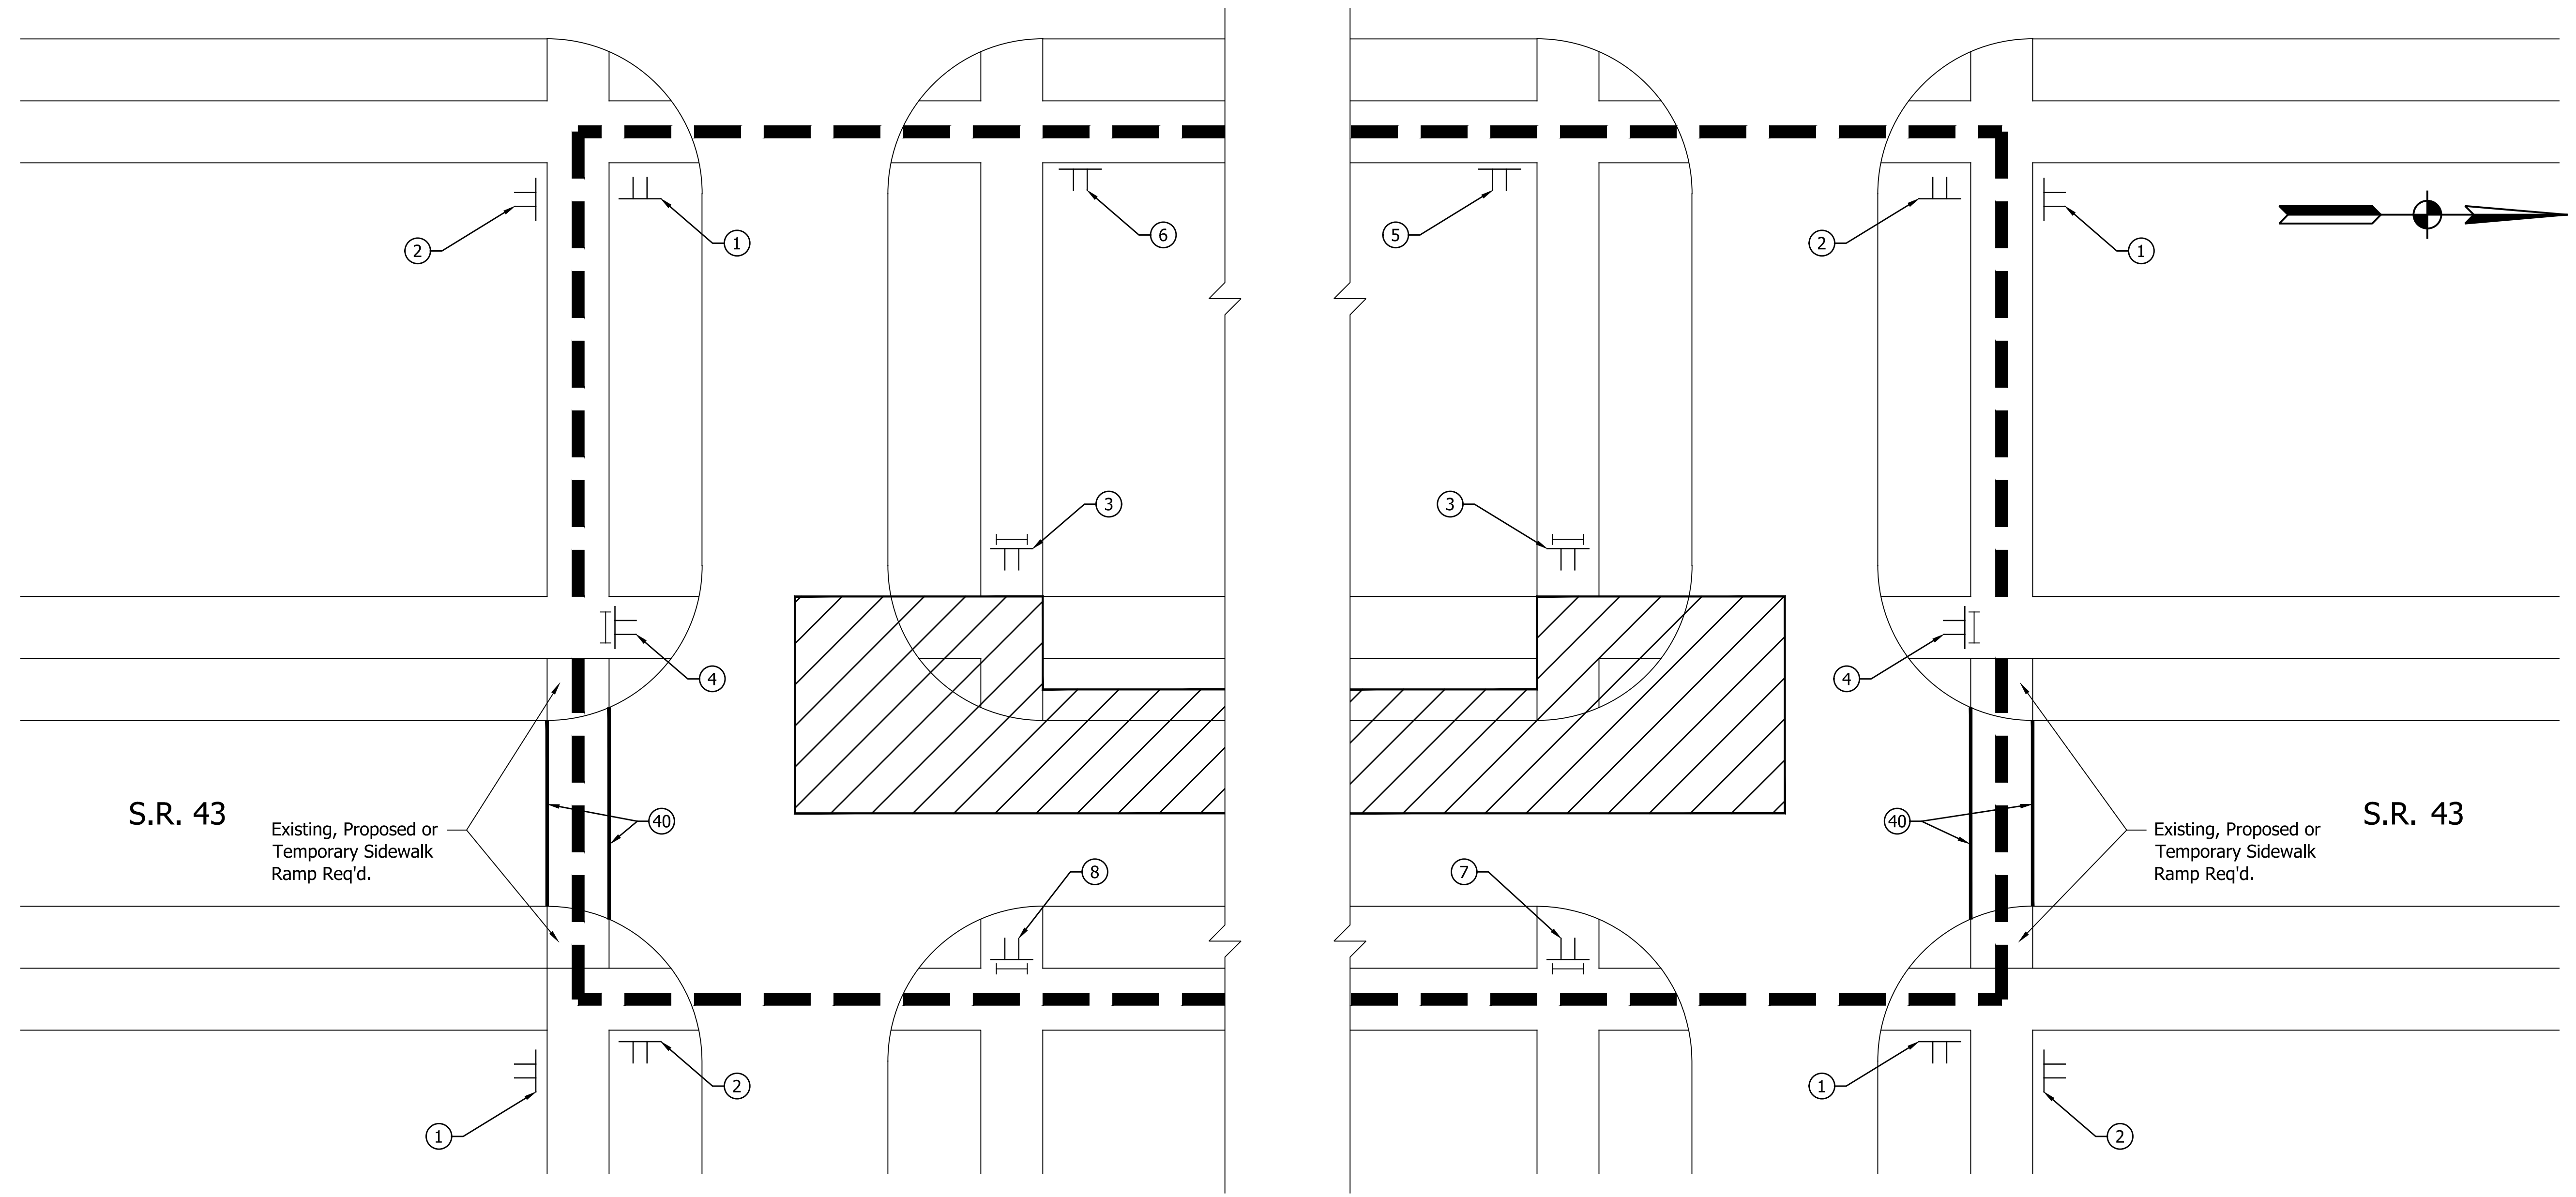

**WEST SIDE CONSTRUCTION WITH PARALLEL & PERPENDICULAR SIDEWALKS**

- NOTES:**
- ONLY ONE RAMP PER BLOCK SHALL BE CLOSED AT ANY GIVEN TIME.
  - THIS TYPICAL APPLIES TO THE ENTIRE CORRIDOR WHERE APPLICABLE.



M4-9b (R)  
30" x 24"  
①




M4-9b (L)  
30" x 24"  
②




R9-9  
24" x 12"  
③



R9-10  
24" x 12"  
④

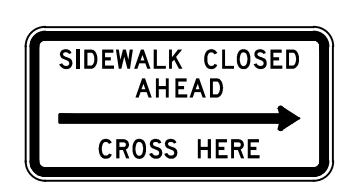

R9-11 (R)  
24" x 12"  
⑤

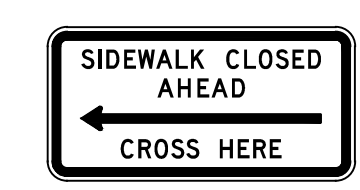

R9-11 (L)  
24" x 12"  
⑥




R9-11a (R)  
24" x 12"  
⑦




R9-11a (L)  
24" x 12"  
⑧

- LEGEND**
- AREA OF CONSTRUCTION
  - TEMPORARY CURB RAMP
  - PEDESTRIAN DETOUR ROUTE
  - TYPE III-B BARRICADE (6')
  - CONSTRUCTION SIGN
  - TEMPORARY PAVEMENT MARKING, REMOVABLE 6" (WHITE)

	RECOMMENDED FOR APPROVAL _____ DESIGN ENGINEER DATE	<b>INDIANA DEPARTMENT OF TRANSPORTATION</b>	<table border="1" style="width: 100%; border-collapse: collapse;"> <tr> <td>HORIZONTAL SCALE</td> <td>BRIDGE FILE</td> </tr> <tr> <td>NONE</td> <td>N/A</td> </tr> <tr> <td>VERTICAL SCALE</td> <td>DESIGNATION</td> </tr> <tr> <td>N/A</td> <td>2001828</td> </tr> <tr> <td>SURVEY BOOK</td> <td>SHEET</td> </tr> <tr> <td></td> <td>16 of 117</td> </tr> <tr> <td>CONTRACT</td> <td>PROJECT</td> </tr> <tr> <td>R-43449</td> <td>2001828</td> </tr> </table>	HORIZONTAL SCALE	BRIDGE FILE	NONE	N/A	VERTICAL SCALE	DESIGNATION	N/A	2001828	SURVEY BOOK	SHEET		16 of 117	CONTRACT	PROJECT	R-43449	2001828
HORIZONTAL SCALE	BRIDGE FILE																		
NONE	N/A																		
VERTICAL SCALE	DESIGNATION																		
N/A	2001828																		
SURVEY BOOK	SHEET																		
	16 of 117																		
CONTRACT	PROJECT																		
R-43449	2001828																		
	<table border="1" style="width: 100%; border-collapse: collapse;"> <tr> <td>DESIGNED: <u>BLW</u></td> <td>DRAWN: <u>REW</u></td> </tr> <tr> <td>CHECKED: <u>DCK</u></td> <td>CHECKED: <u>DCK</u></td> </tr> </table>	DESIGNED: <u>BLW</u>	DRAWN: <u>REW</u>	CHECKED: <u>DCK</u>	CHECKED: <u>DCK</u>	<b>MAINTENANCE OF TRAFFIC TYPICAL PEDESTRIAN DETOUR</b>													
DESIGNED: <u>BLW</u>	DRAWN: <u>REW</u>																		
CHECKED: <u>DCK</u>	CHECKED: <u>DCK</u>																		

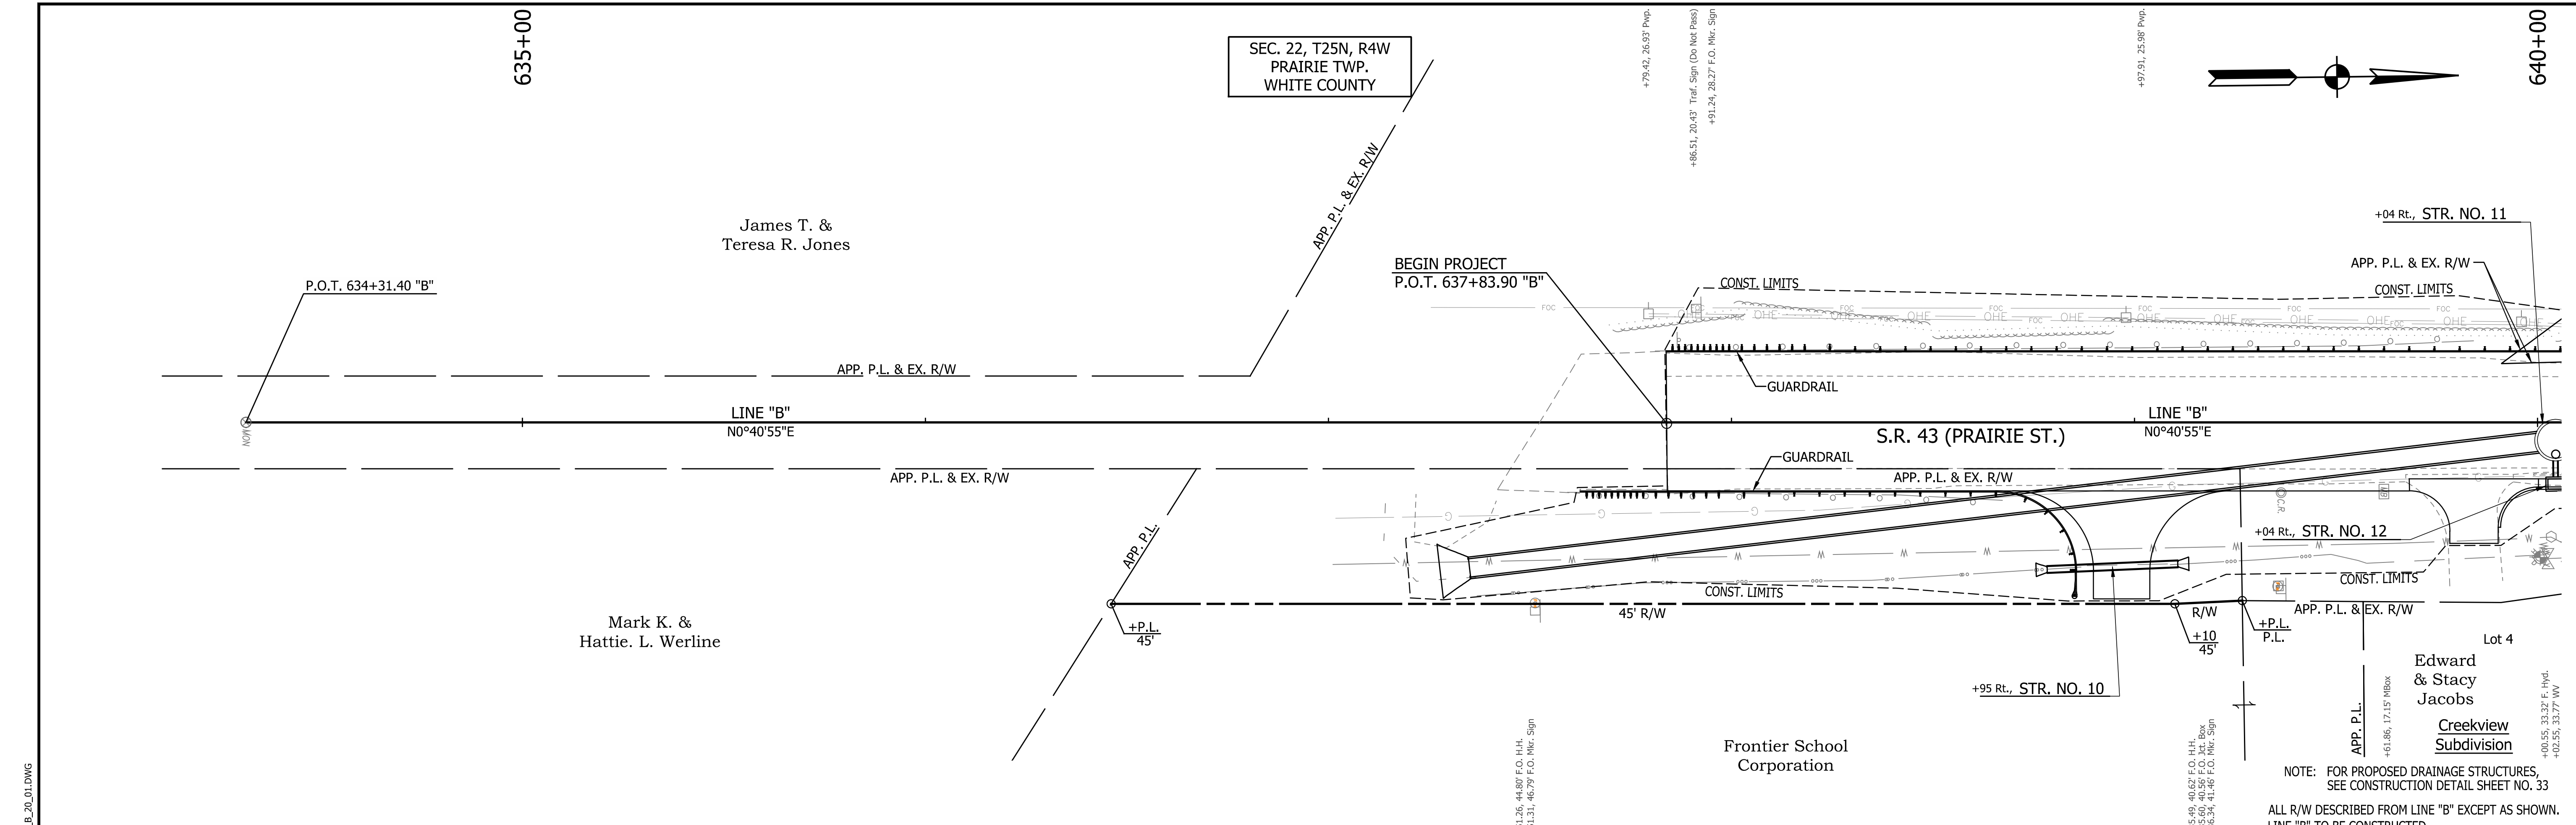


NOTE: FOR PROPOSED DRAINAGE STRUCTURES, SEE CONSTRUCTION DETAIL SHEET NO. 33  
 ALL R/W DESCRIBED FROM LINE "B" EXCEPT AS SHOWN. LINE "B" TO BE CONSTRUCTED.

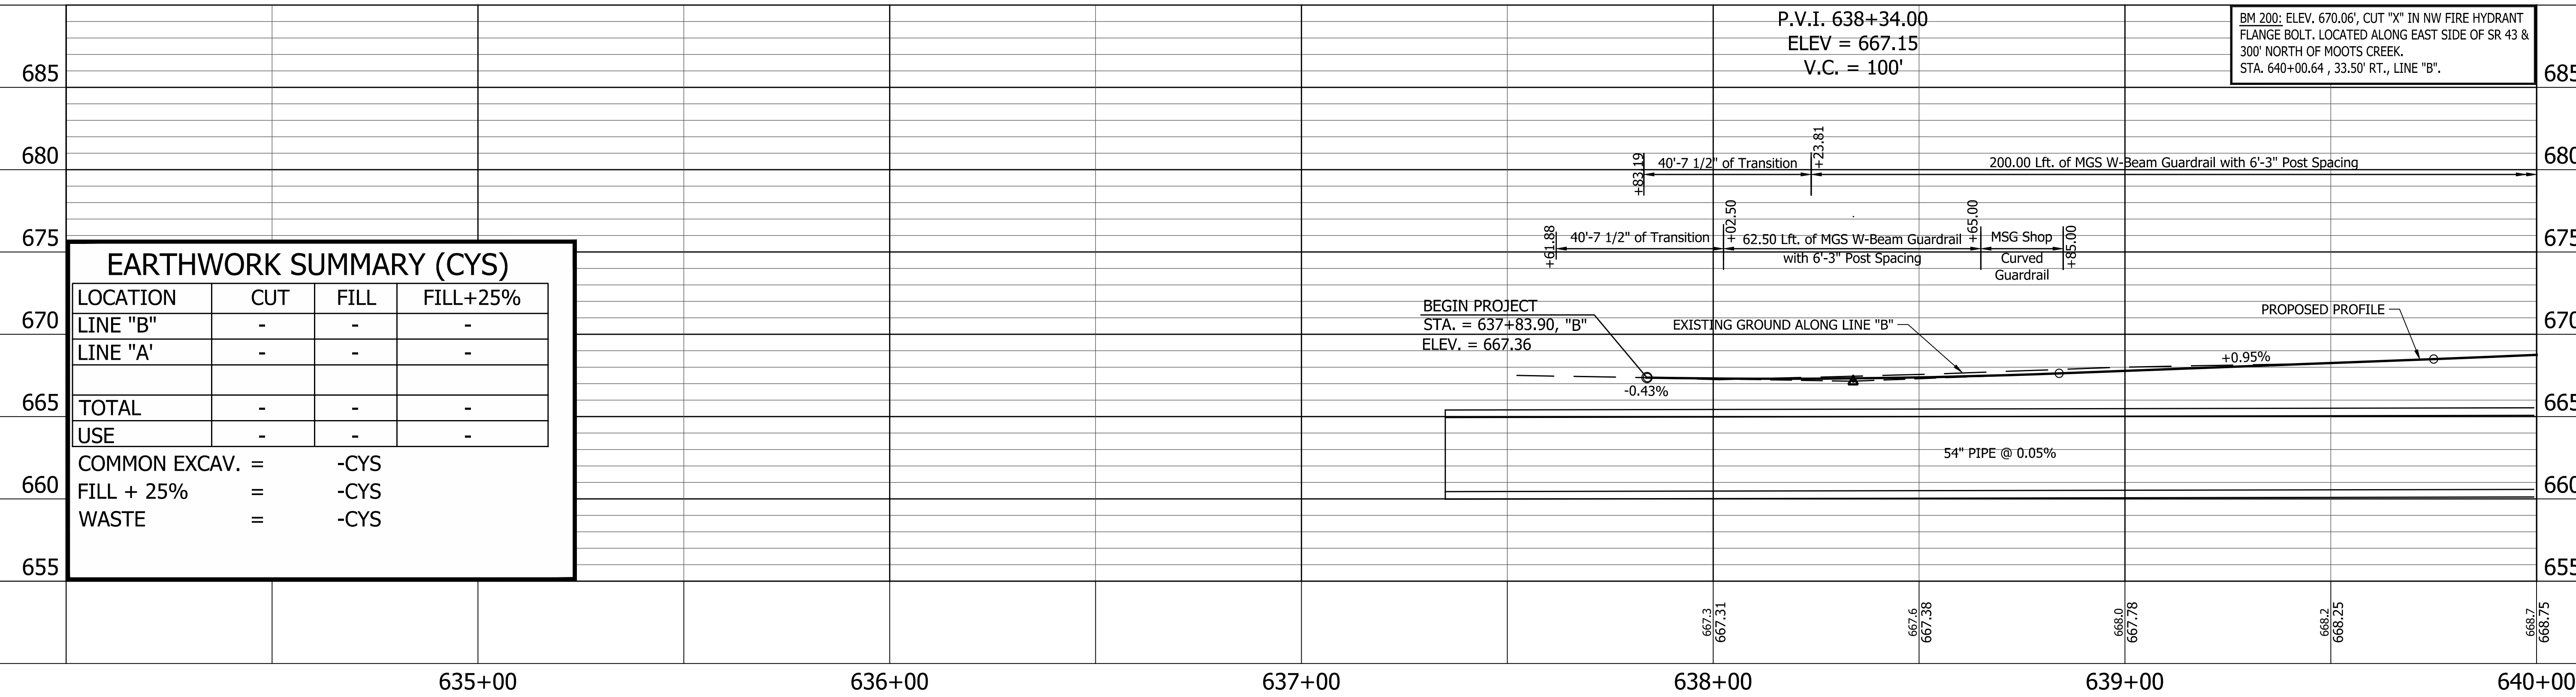

EARTHWORK SUMMARY (CYS)			
LOCATION	CUT	FILL	FILL+25%
LINE "B"	-	-	-
LINE "A"	-	-	-
TOTAL	-	-	-
USE	-	-	-
COMMON EXCAV.	=	-CYS	
FILL + 25%	=	-CYS	
WASTE	=	-CYS	

PRINT DATE: 4/5/23  
 PLOT SCALE: 1:1  
 EDIT DATE: 2/22/23 - 2:27 PM  
 EDITED BY: RWILSON  
 DRAWING FILE: P:\21-500-155-1 WHITE CO PAVEMENT REPLACEMENT 210108\ACAD\06 PLAN PROF\RD\_PLAN\_PROFILE\_SHEET\_B\_20\_01.DWG  
 22-25N-4W  
 Rebar w/ RQAW Control Cap

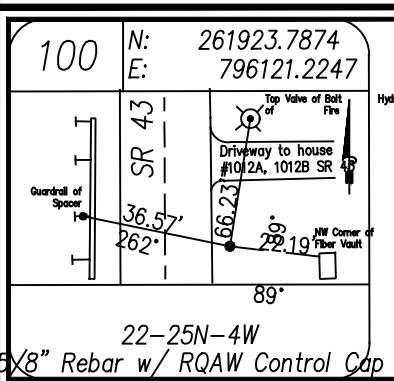


RECOMMENDED FOR APPROVAL	DESIGN ENGINEER	DATE
DESIGNED: BLW	DRAWN: REW	
CHECKED: DCK	CHECKED: DCK	

**INDIANA**  
**DEPARTMENT OF TRANSPORTATION**  
**PLAN AND PROFILE**  
**STA. 634+31.40 TO 640+00.00 LINE "B"**


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VERTICAL SCALE	DESIGNATION
1" = 5'	2001828
SURVEY BOOK	SHEET
	17 of 117
CONTRACT	PROJECT
R-43449	2001828




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PLOT SCALE: 1:1  
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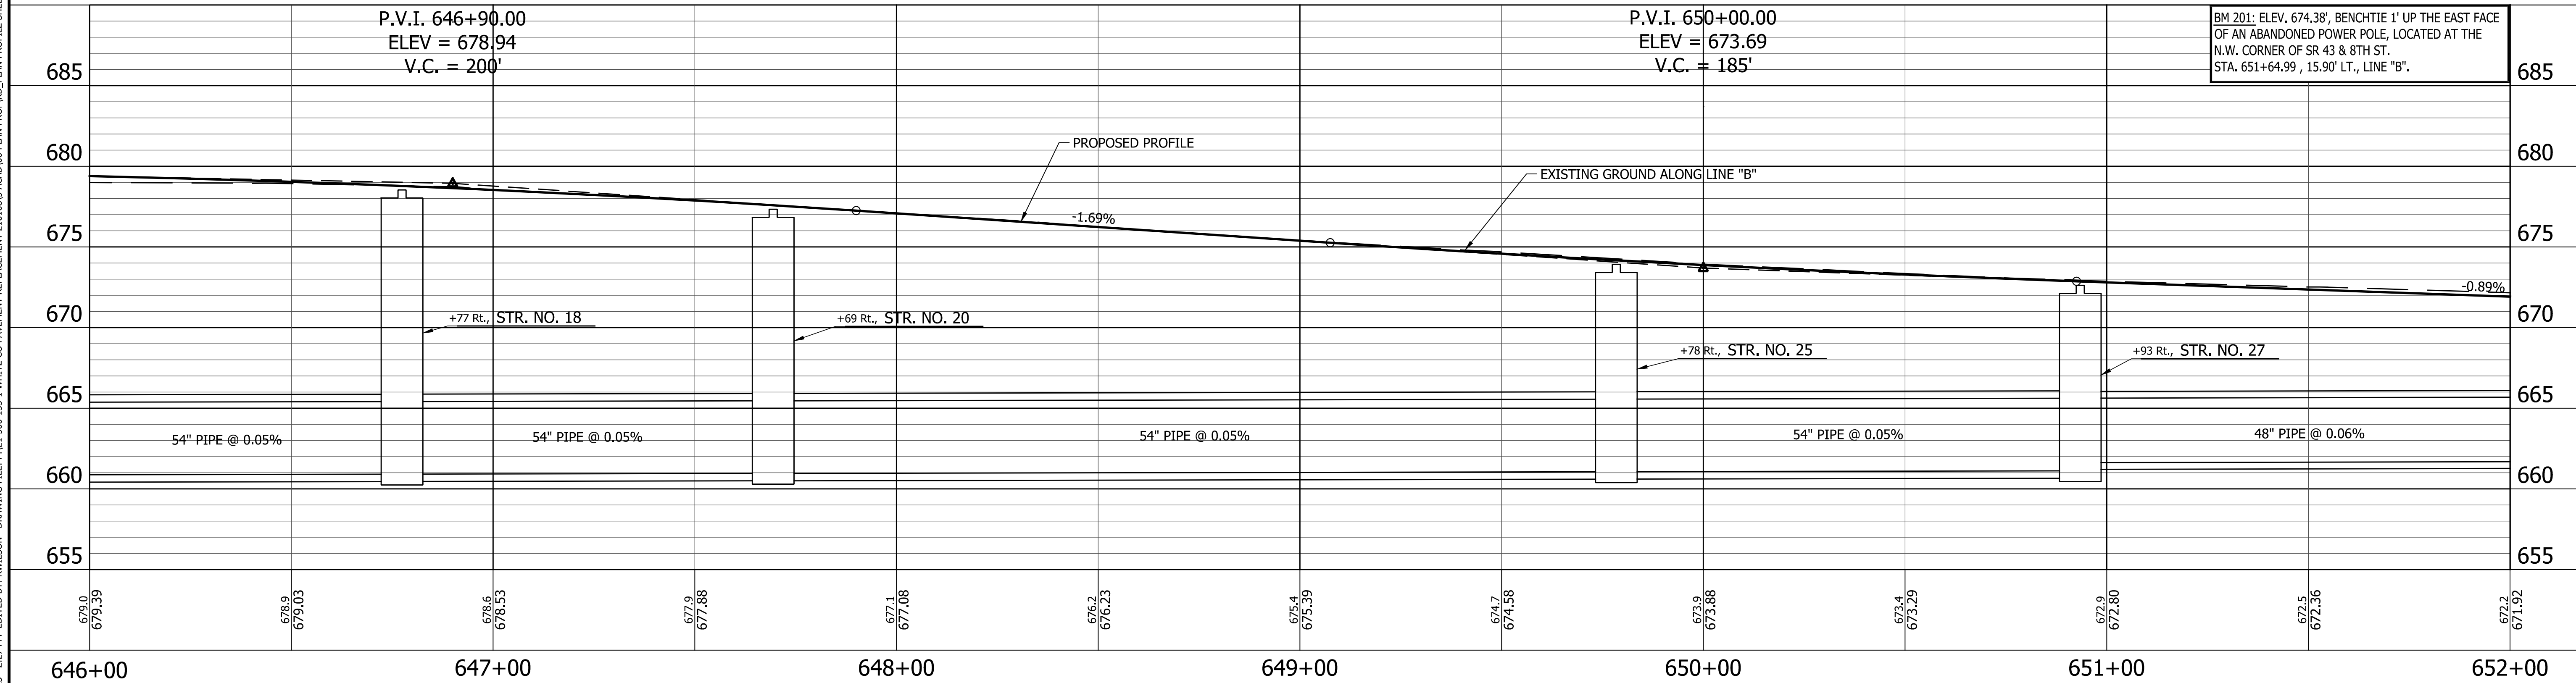
NOTE: FOR PROPOSED DRAINAGE STRUCTURES, SEE CONSTRUCTION DETAIL SHEET NO. 34  
ALL R/W DESCRIBED FROM LINE "B" EXCEPT AS SHOWN.  
LINE "B" TO BE CONSTRUCTED.

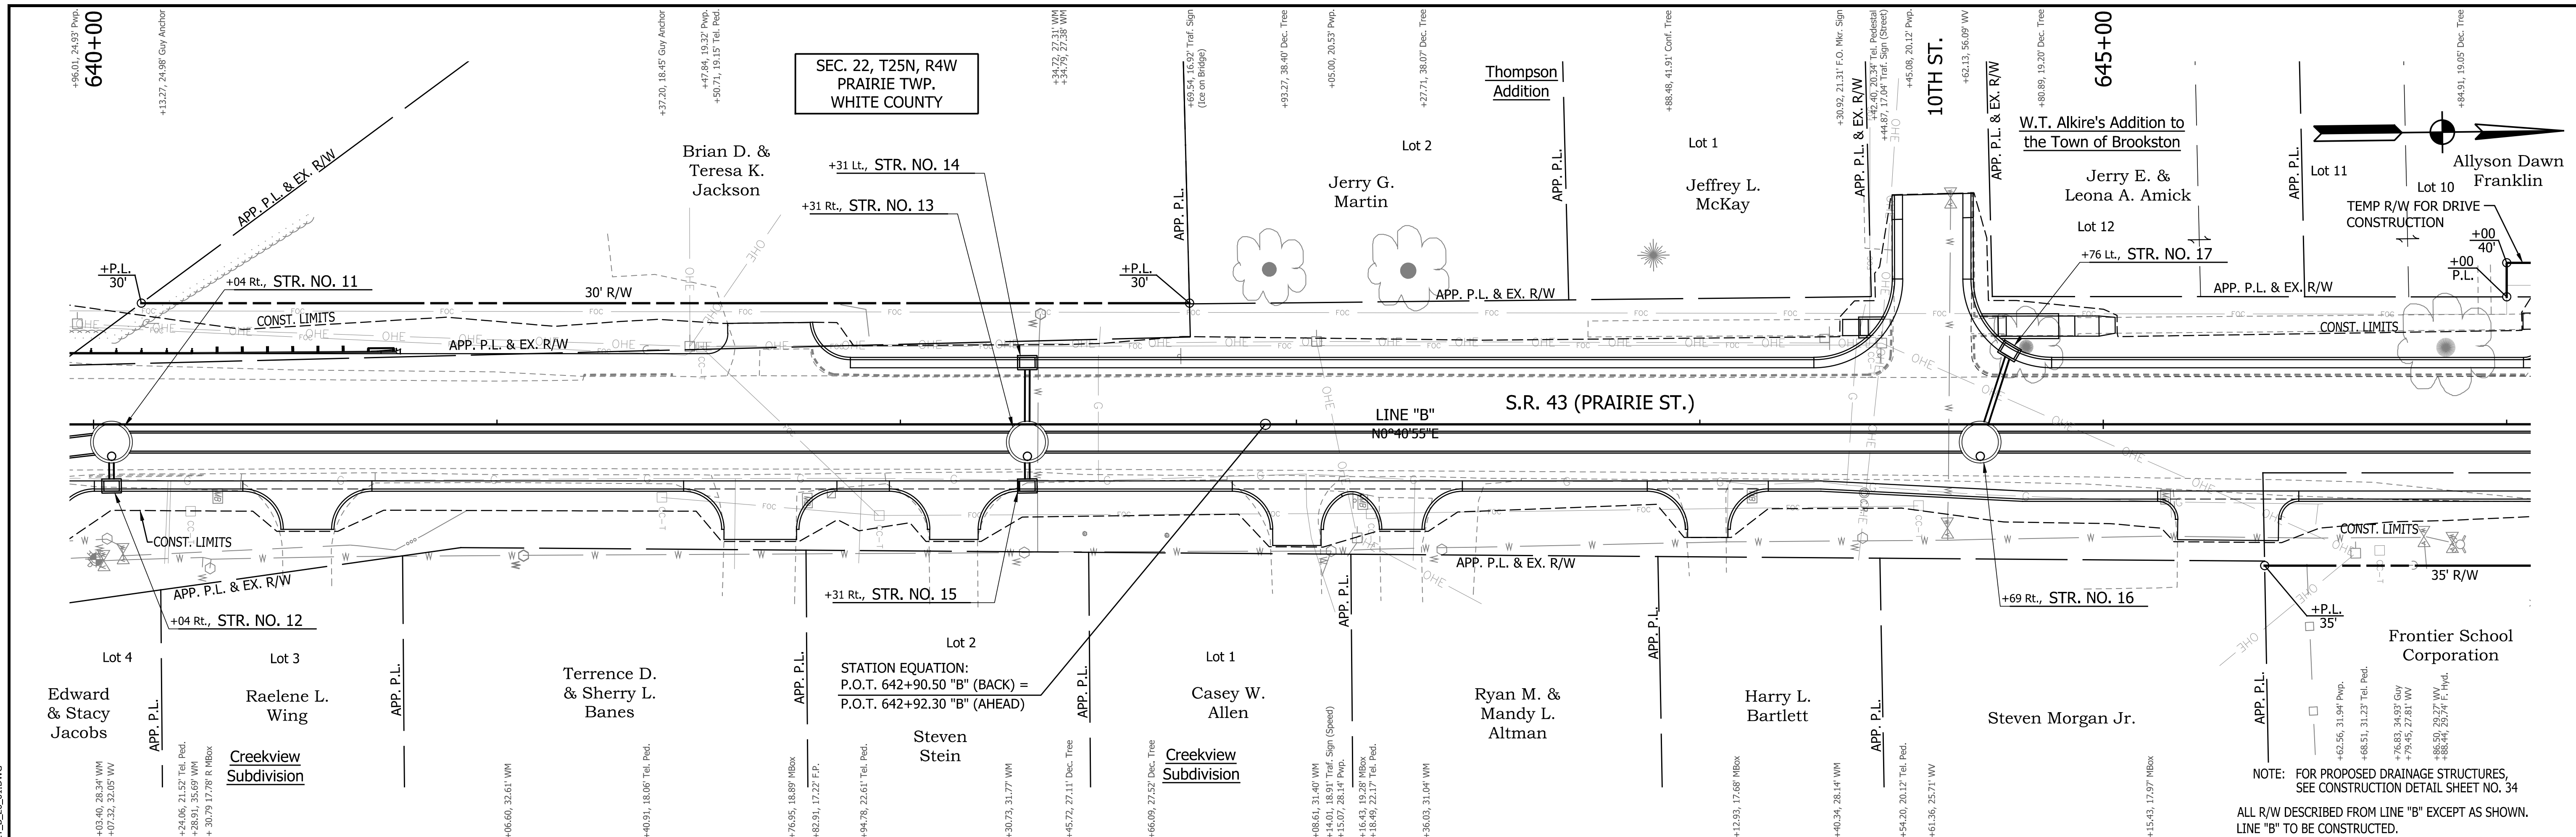

PRINT DATE: 4/5/23  
 PLOT SCALE: 1:1  
 EDIT DATE: 2/22/23 - 2:27 PM  
 EDITED BY: RWILSON  
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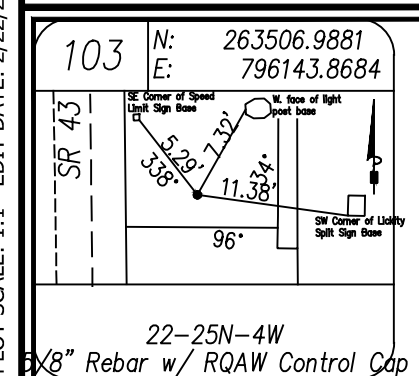
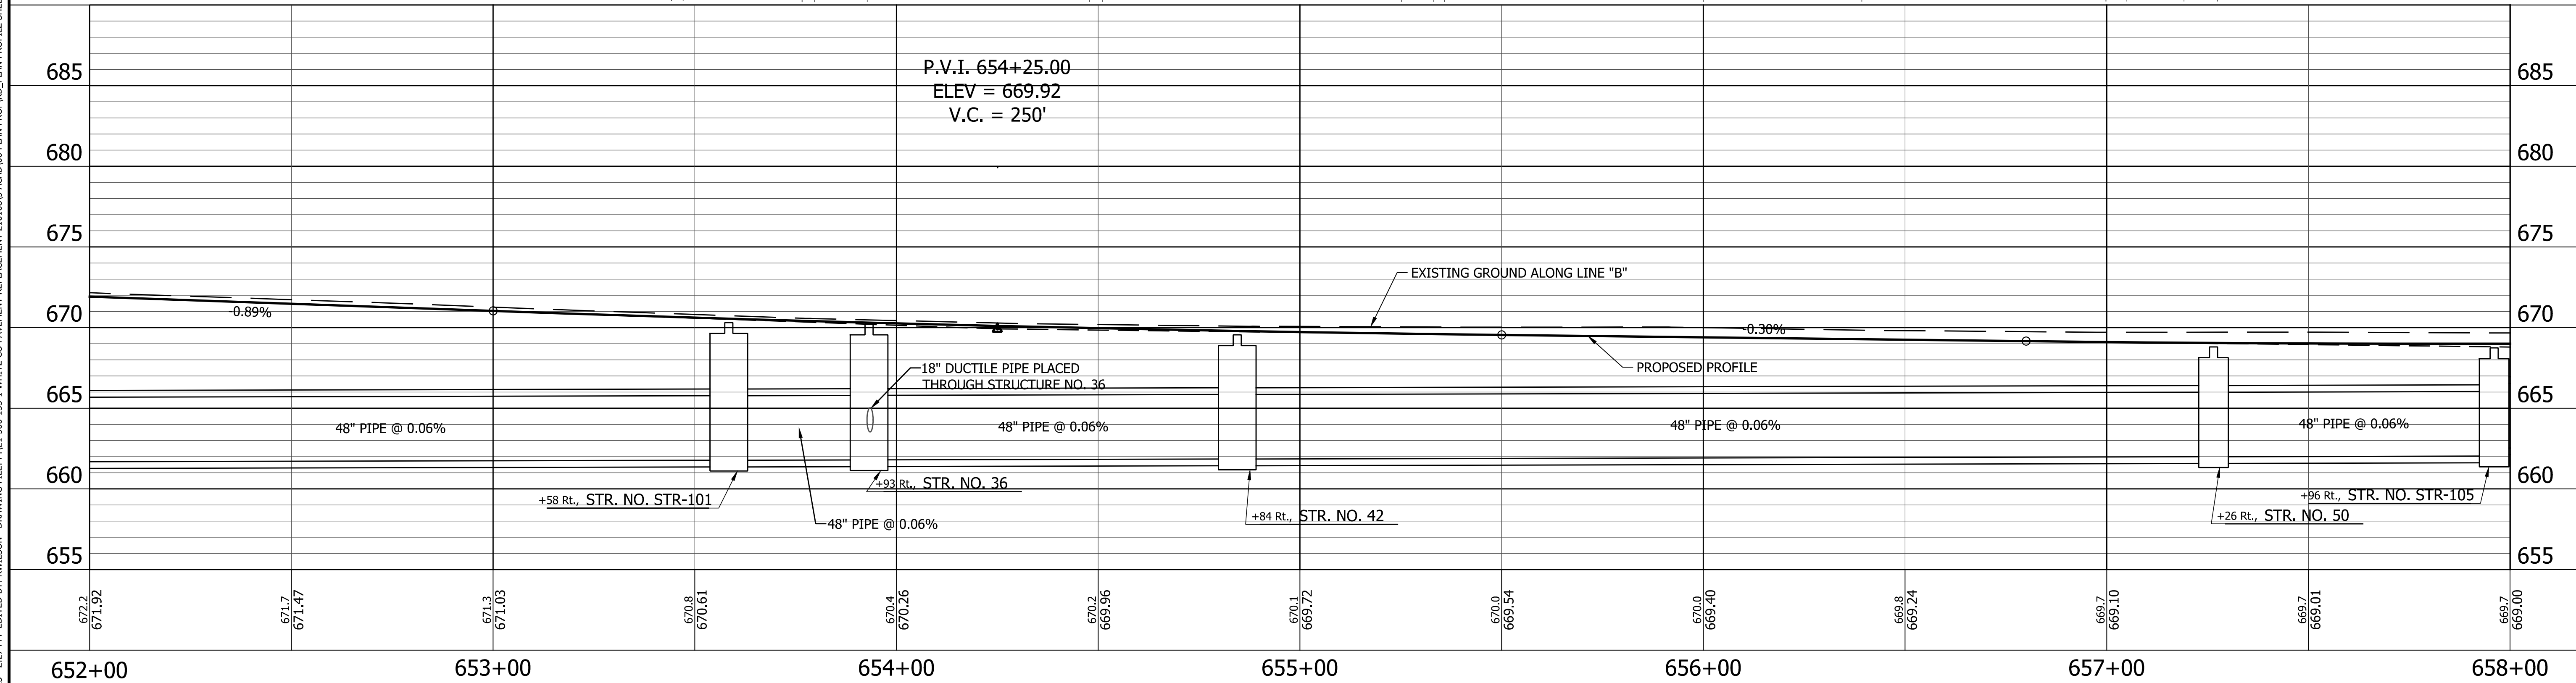
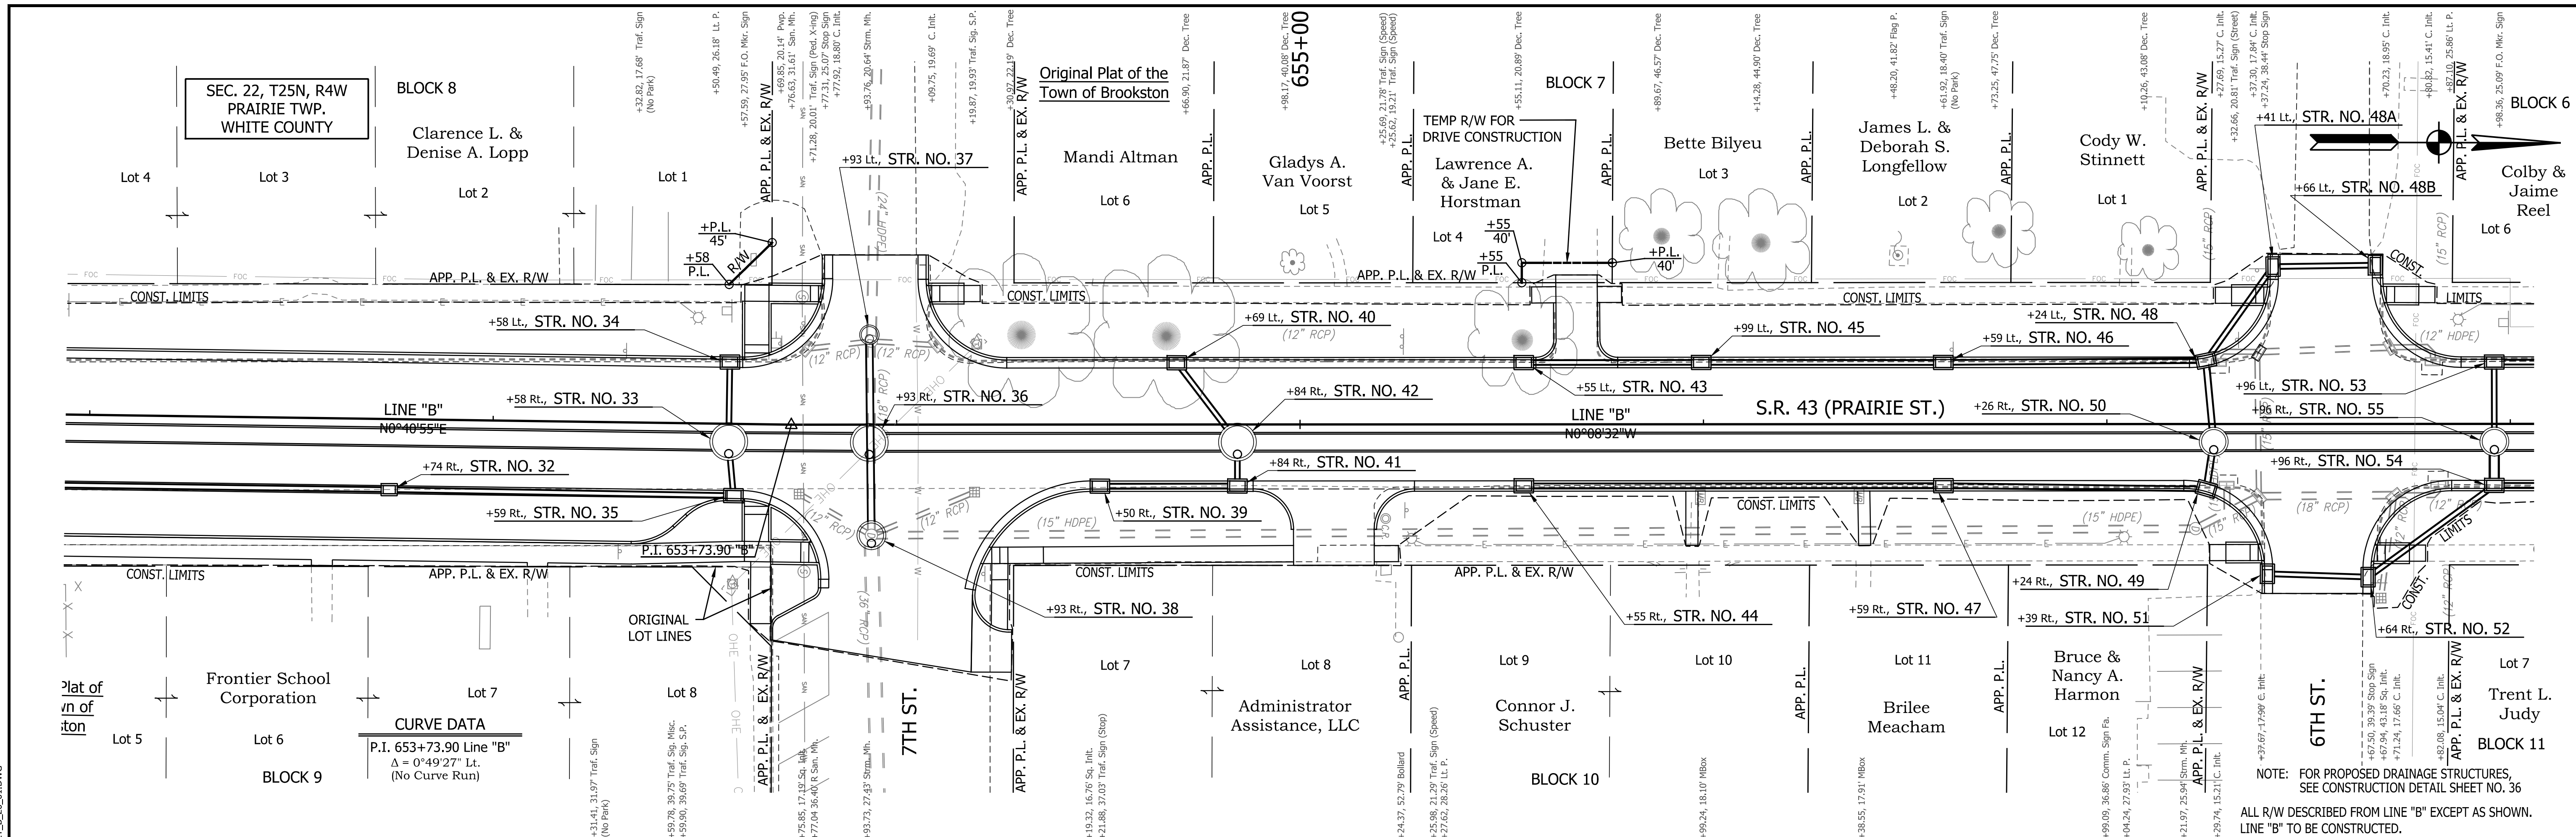
NOTE: FOR PROPOSED DRAINAGE STRUCTURES, SEE CONSTRUCTION DETAIL SHEET NO. 35  
 ALL R/W DESCRIBED FROM LINE "B" EXCEPT AS SHOWN. LINE "B" TO BE CONSTRUCTED.

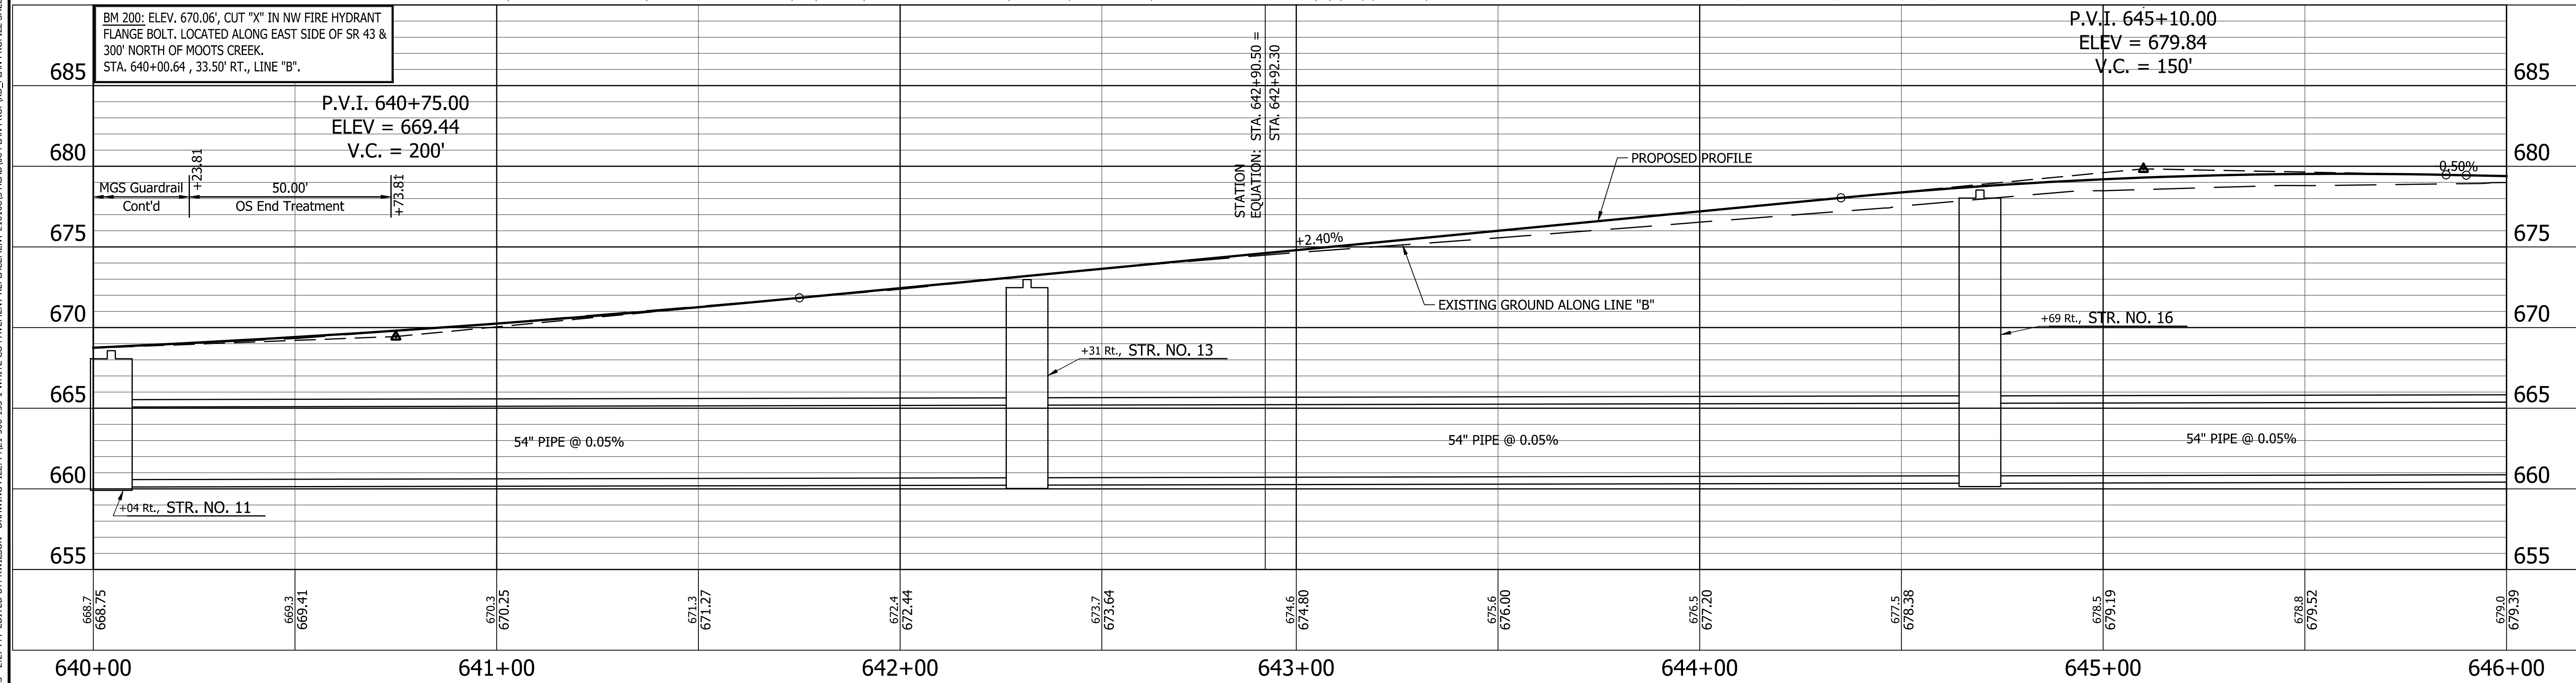

BM 201: ELEV. 674.38', BENCHTIE 1' UP THE EAST FACE OF AN ABANDONED POWER POLE, LOCATED AT THE N.W. CORNER OF SR 43 & 8TH ST. STA. 651+64.99, 15.90' LT., LINE "B".
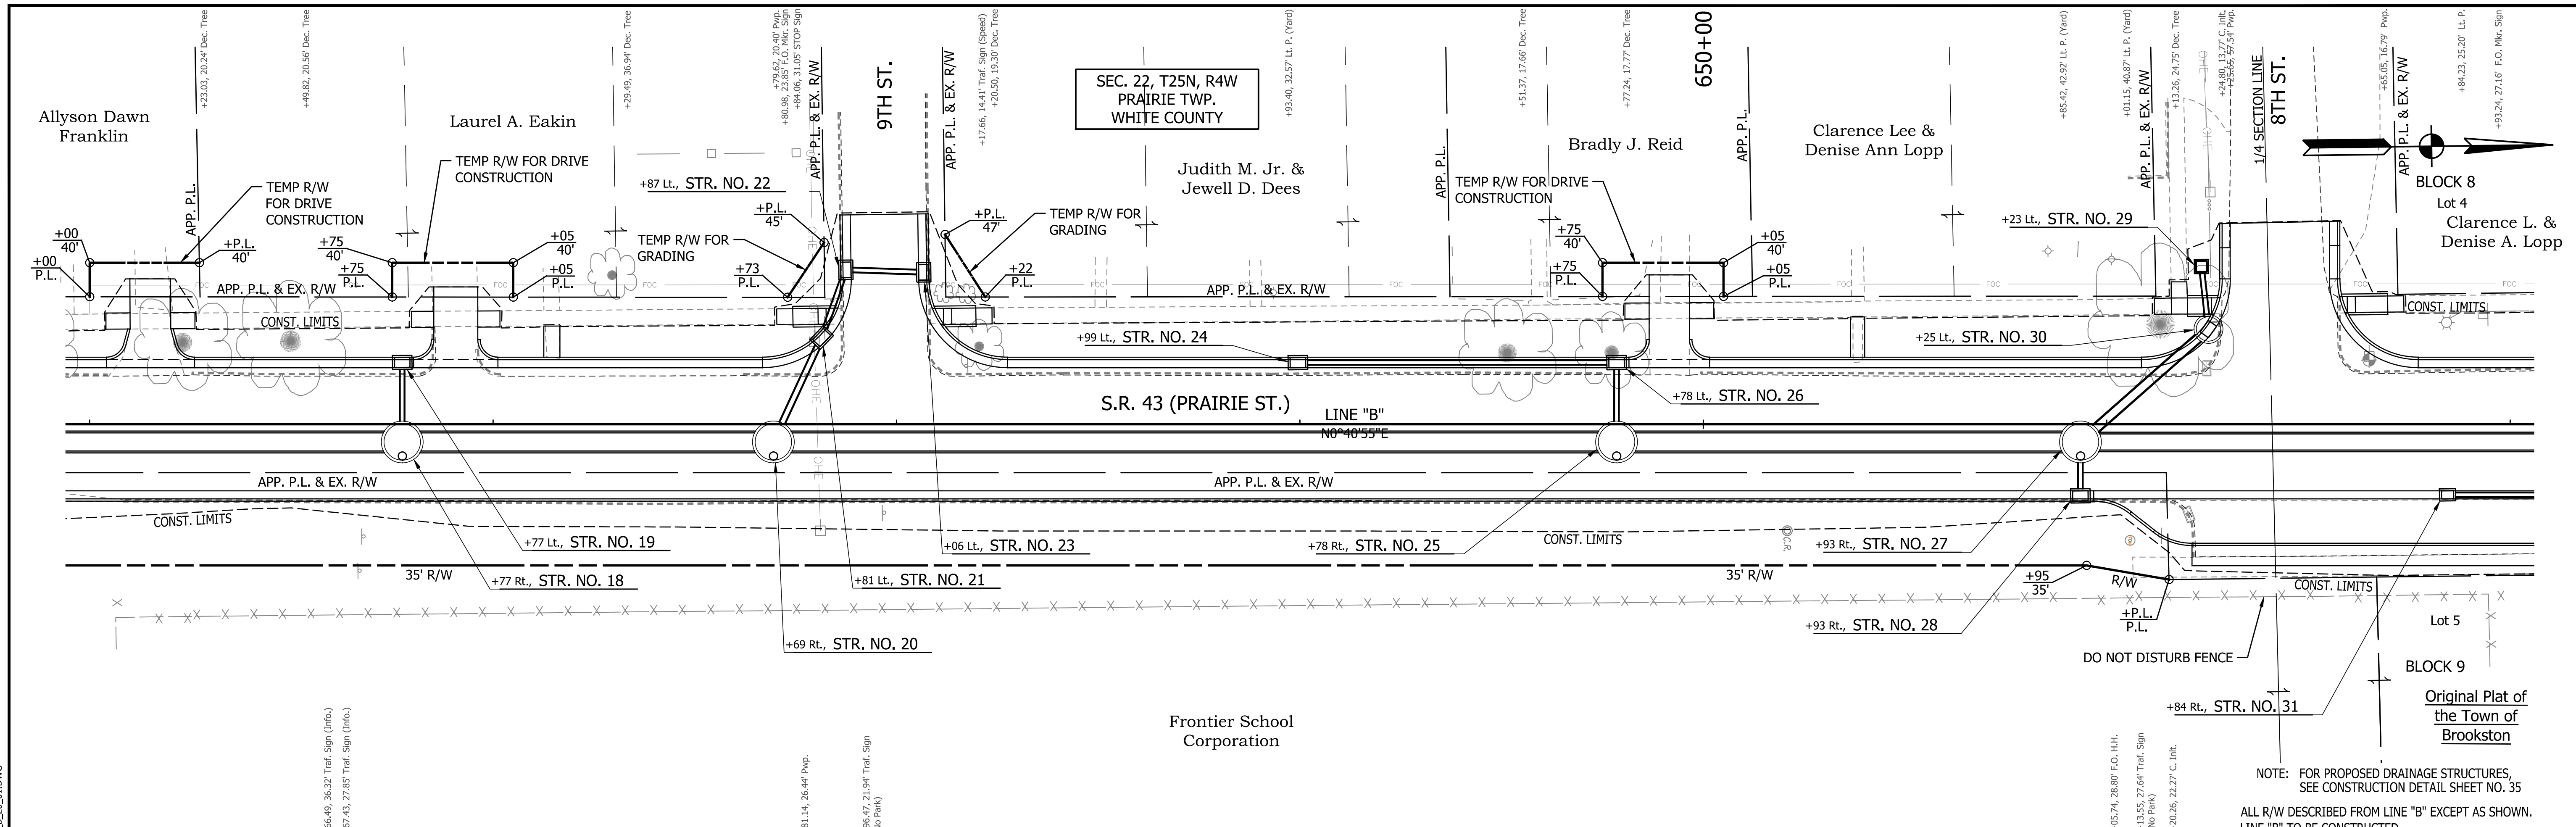
<p>102 N: 263006.2187 E: 796143.0880</p> <p>8th St. SR 43</p> <p>22-25N-4W Rebar w/ ROW Control Cap</p>	<p>RECOMMENDED FOR APPROVAL _____</p> <p style="text-align: center;">DESIGN ENGINEER      DATE</p> <p>DESIGNED: <u>BLW</u>      DRAWN: <u>REW</u></p> <p>CHECKED: <u>DCK</u>      CHECKED: <u>DCK</u></p>	<p>INDIANA DEPARTMENT OF TRANSPORTATION</p> <p><b>PLAN AND PROFILE</b></p> <p>STA. 646+00.00 TO 652+00.00 LINE "B"</p>	<table border="1" style="width: 100%; border-collapse: collapse;"> <tr> <td>HORIZONTAL SCALE</td> <td>BRIDGE FILE</td> </tr> <tr> <td>1" = 20'</td> <td>N/A</td> </tr> <tr> <td>VERTICAL SCALE</td> <td>DESIGNATION</td> </tr> <tr> <td>1" = 5'</td> <td>2001828</td> </tr> <tr> <td>SURVEY BOOK</td> <td>SHEET</td> </tr> <tr> <td></td> <td>19 of 117</td> </tr> <tr> <td>CONTRACT</td> <td>PROJECT</td> </tr> <tr> <td>R-43449</td> <td>2001828</td> </tr> </table>	HORIZONTAL SCALE	BRIDGE FILE	1" = 20'	N/A	VERTICAL SCALE	DESIGNATION	1" = 5'	2001828	SURVEY BOOK	SHEET		19 of 117	CONTRACT	PROJECT	R-43449	2001828
HORIZONTAL SCALE	BRIDGE FILE																		
1" = 20'	N/A																		
VERTICAL SCALE	DESIGNATION																		
1" = 5'	2001828																		
SURVEY BOOK	SHEET																		
	19 of 117																		
CONTRACT	PROJECT																		
R-43449	2001828																		

PRINT DATE: 4/5/23  
 PLOT SCALE: 1:1  
 EDIT DATE: 2/22/23 - 2:27 PM  
 EDITED BY: RWILSON  
 DRAWING FILE: P:\21-500-1-15-1 WHITE CO PAVEMENT REPLACEMENT 210108\ACAD\06 PLAN PROF\RD\_PLAN\_PROFILE\_SHEET\_B\_20\_01.DWG



RECOMMENDED FOR APPROVAL	DESIGN ENGINEER	DATE
DESIGNED: <u>BLW</u>	DRAWN: <u>REW</u>	
CHECKED: <u>DCK</u>	CHECKED: <u>DCK</u>	

**INDIANA**  
 DEPARTMENT OF TRANSPORTATION


**PLAN AND PROFILE**  
 STA. 652+00.00 TO 658+00.00 LINE "B"

HORIZONTAL SCALE	BRIDGE FILE
1" = 20'	N/A
VERTICAL SCALE	DESIGNATION
1" = 5'	2001828
SURVEY BOOK	SHEET
	20 of 117
CONTRACT	PROJECT
R-43449	2001828


NOTE: FOR PROPOSED DRAINAGE STRUCTURES, SEE CONSTRUCTION DETAIL SHEET NO. 36  
 ALL R/W DESCRIBED FROM LINE "B" EXCEPT AS SHOWN. LINE "B" TO BE CONSTRUCTED.



PRINT DATE: 4/5/23  
 PLOT SCALE: 1:1  
 EDIT DATE: 2/22/23 - 2:27 PM  
 EDITED BY: RWILSON  
 DRAWING FILE: P:\21-500-155-1 WHITE CO PAVEMENT REPLACEMENT 210108\ACAD\06 PLAN PROF\RD\_PLAN\_PROFILE\_SHEET\_B\_20\_01.DWG

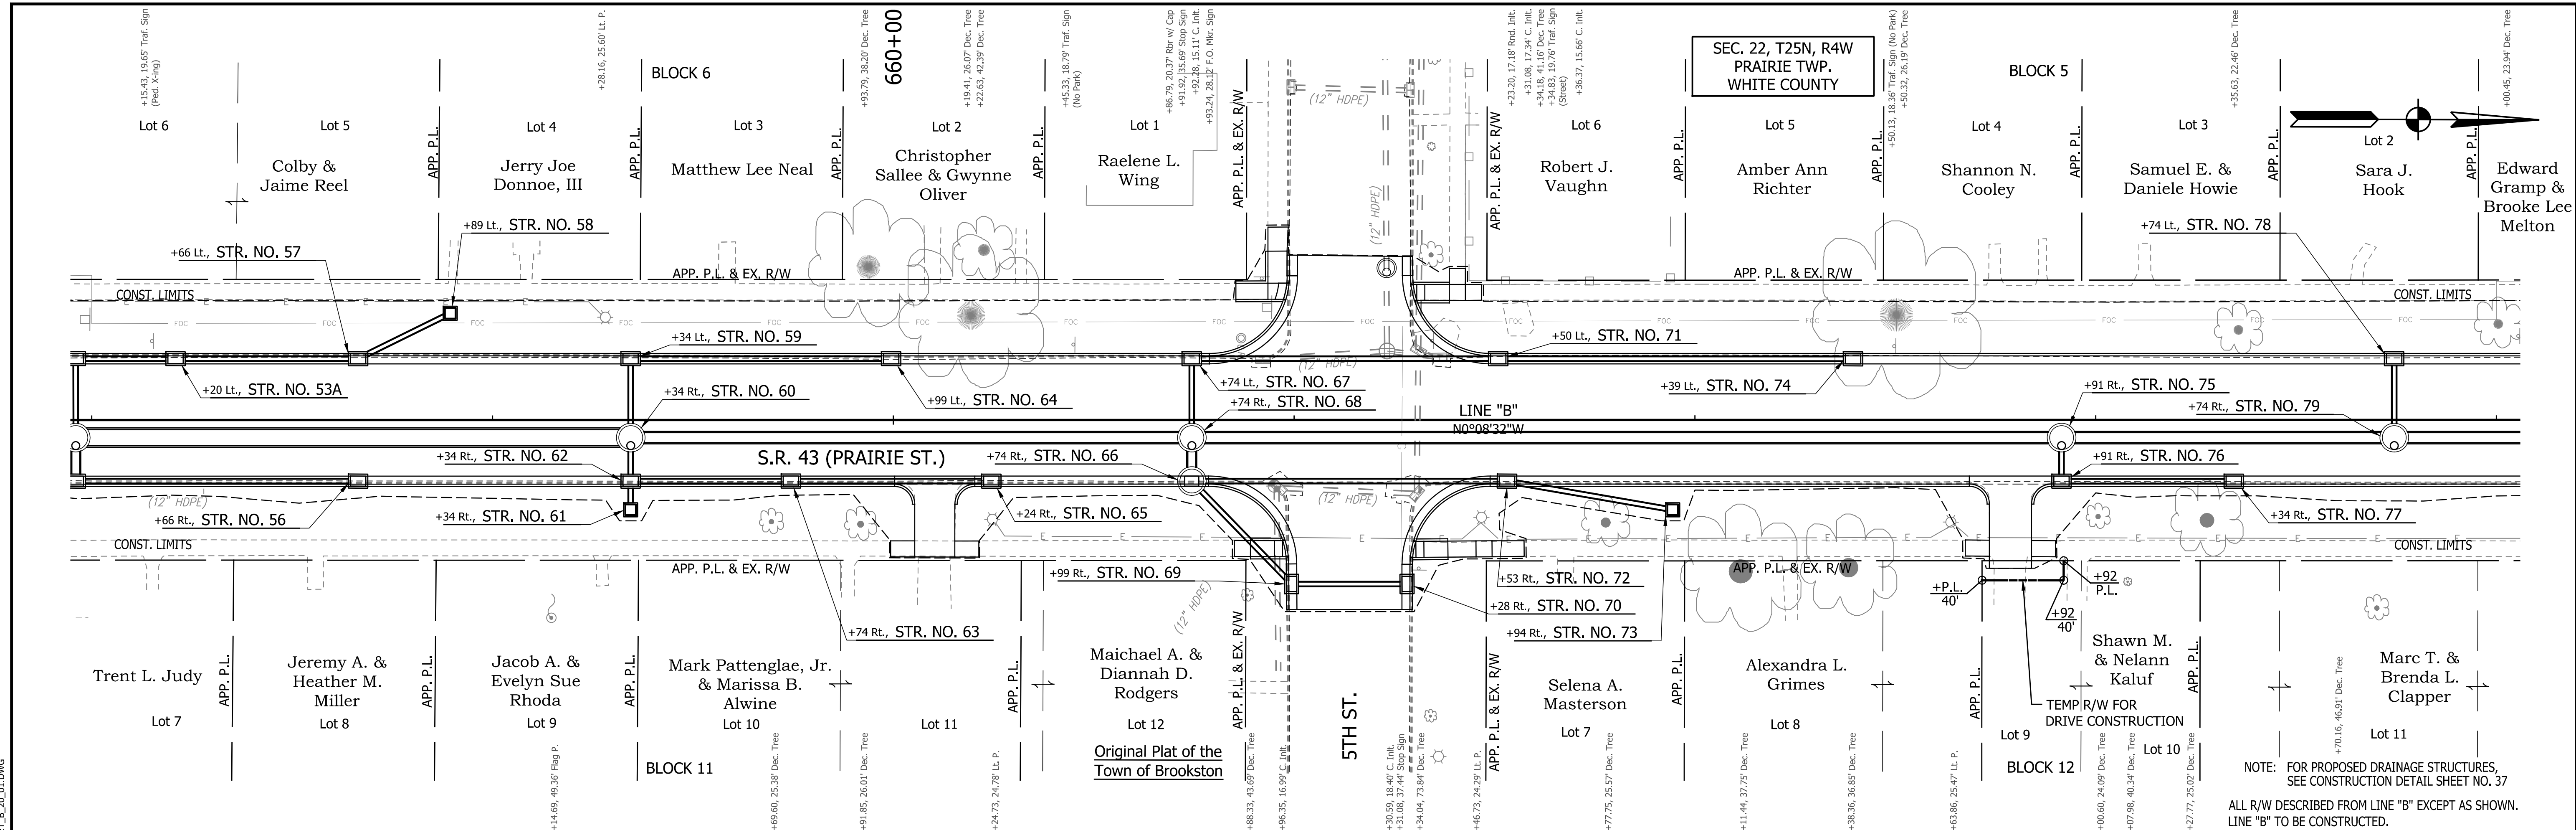

NOTE: FOR PROPOSED DRAINAGE STRUCTURES, SEE CONSTRUCTION DETAIL SHEET NO. 37  
 ALL R/W DESCRIBED FROM LINE "B" EXCEPT AS SHOWN.  
 LINE "B" TO BE CONSTRUCTED.

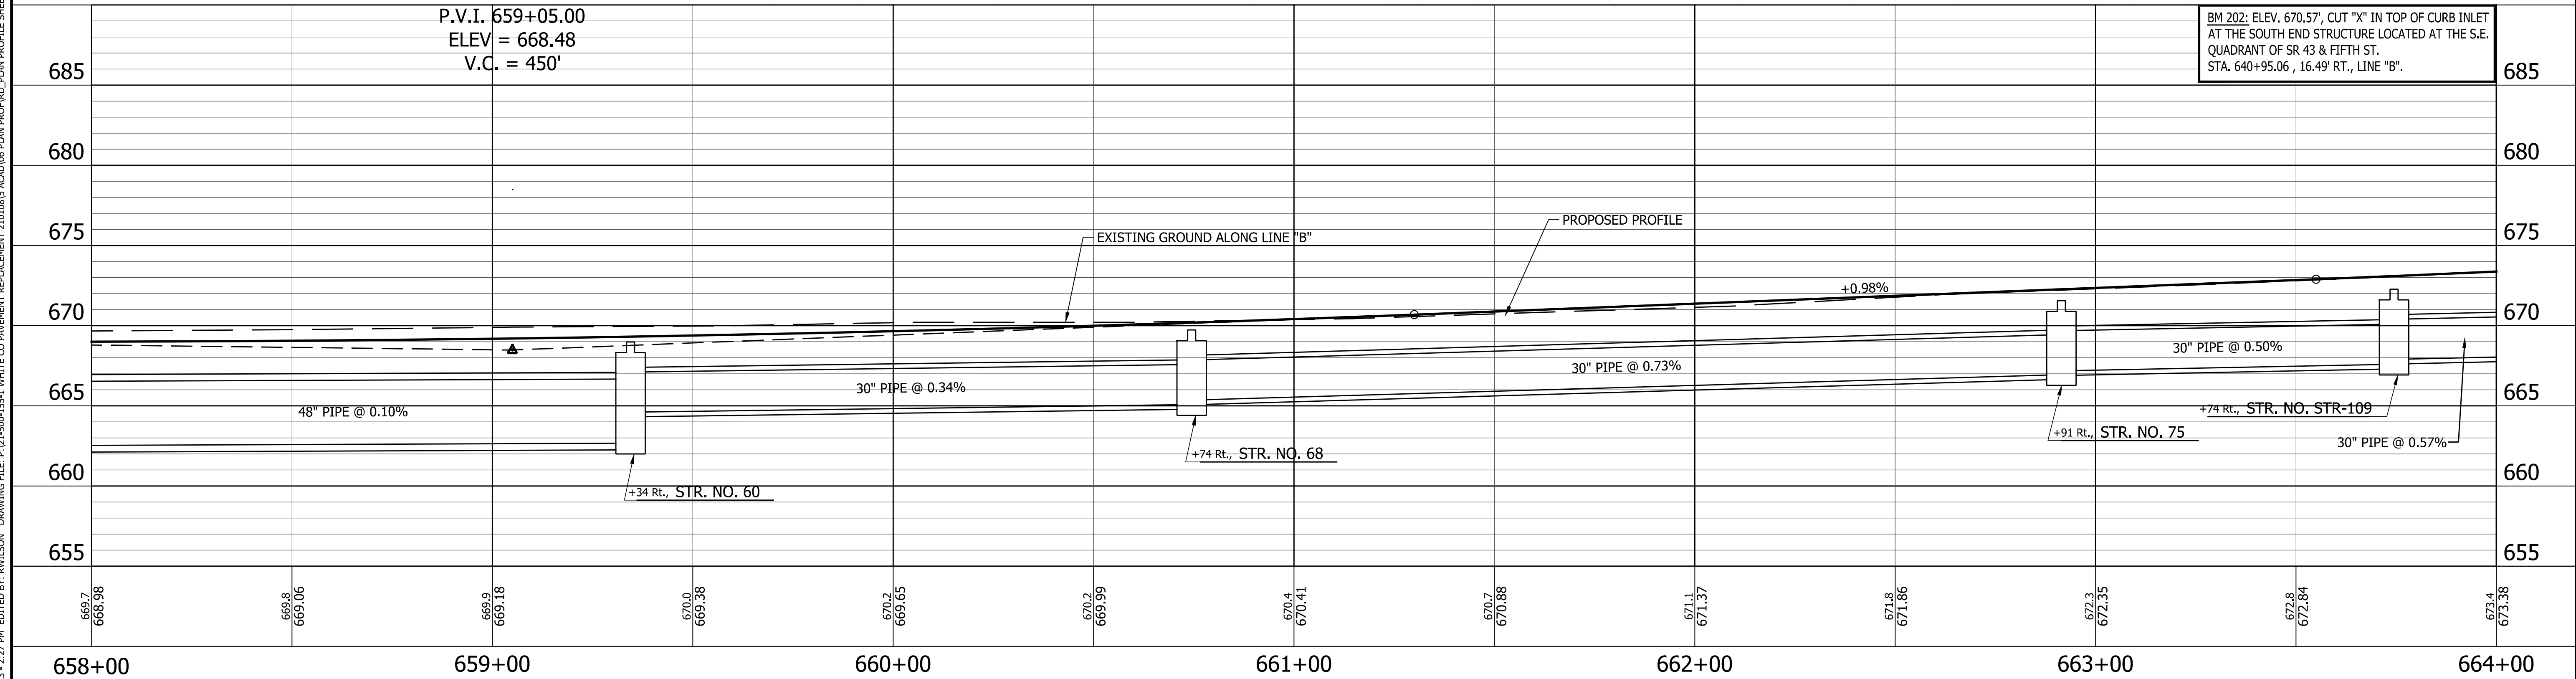

BM 202: ELEV. 670.57', CUT "X" IN TOP OF CURB INLET  
 AT THE SOUTH END STRUCTURE LOCATED AT THE S.E.  
 QUADRANT OF SR 43 & FIFTH ST.  
 STA. 640+95.06, 16.49' RT., LINE "B".

104  
 N: 264072.4659  
 E: 796098.7353  
 22-25N-4W  
 Rebar w/ ROAW Control Cap




RECOMMENDED FOR APPROVAL	DESIGN ENGINEER	DATE
DESIGNED: <u>BLW</u>	DRAWN: <u>REW</u>	
CHECKED: <u>DCK</u>	CHECKED: <u>DCK</u>	

INDIANA  
 DEPARTMENT OF TRANSPORTATION  
 PLAN AND PROFILE  
 STA. 658+00.00 TO 664+00.00 LINE "B"

HORIZONTAL SCALE	BRIDGE FILE
1" = 20'	N/A
VERTICAL SCALE	DESIGNATION
1" = 5'	2001828
SURVEY BOOK	SHEET
	21 of 117
CONTRACT	PROJECT
R-43449	2001828



PRINT DATE: 4/5/23  
 PLOT SCALE: 1:1  
 EDIT DATE: 2/22/23 - 2:27 PM  
 EDITED BY: RWILSON  
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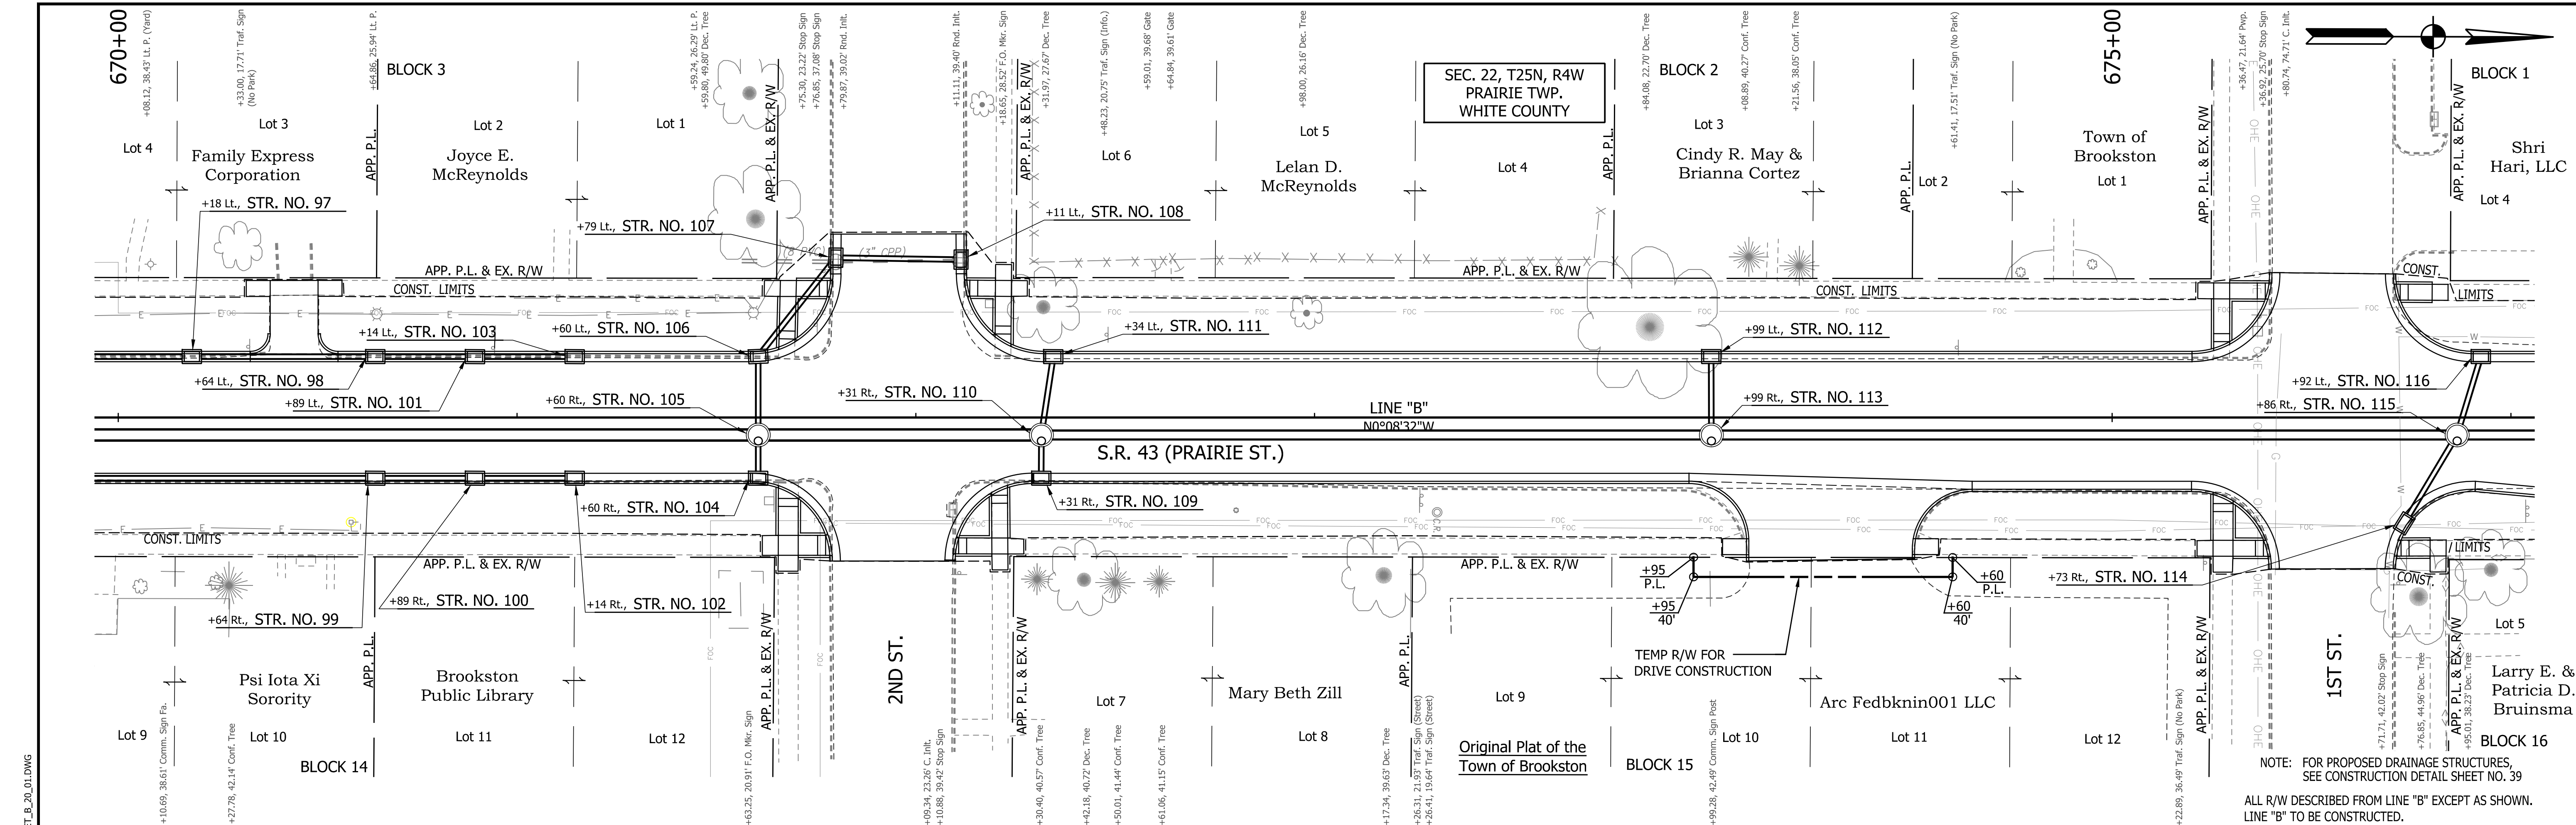
RECOMMENDED FOR APPROVAL	DESIGN ENGINEER	DATE
DESIGNED: <u>BLW</u>	DRAWN: <u>REW</u>	
CHECKED: <u>DCK</u>	CHECKED: <u>DCK</u>	

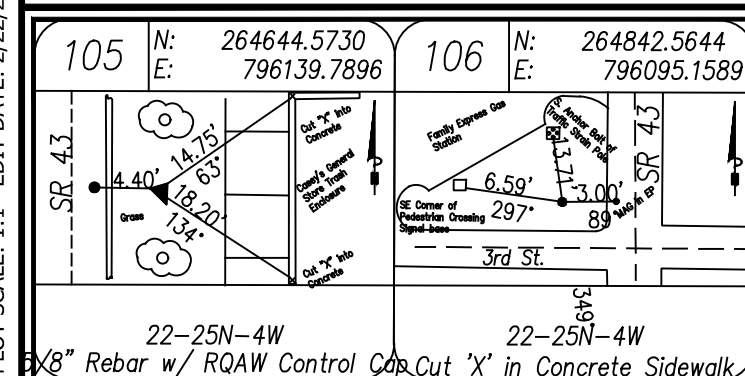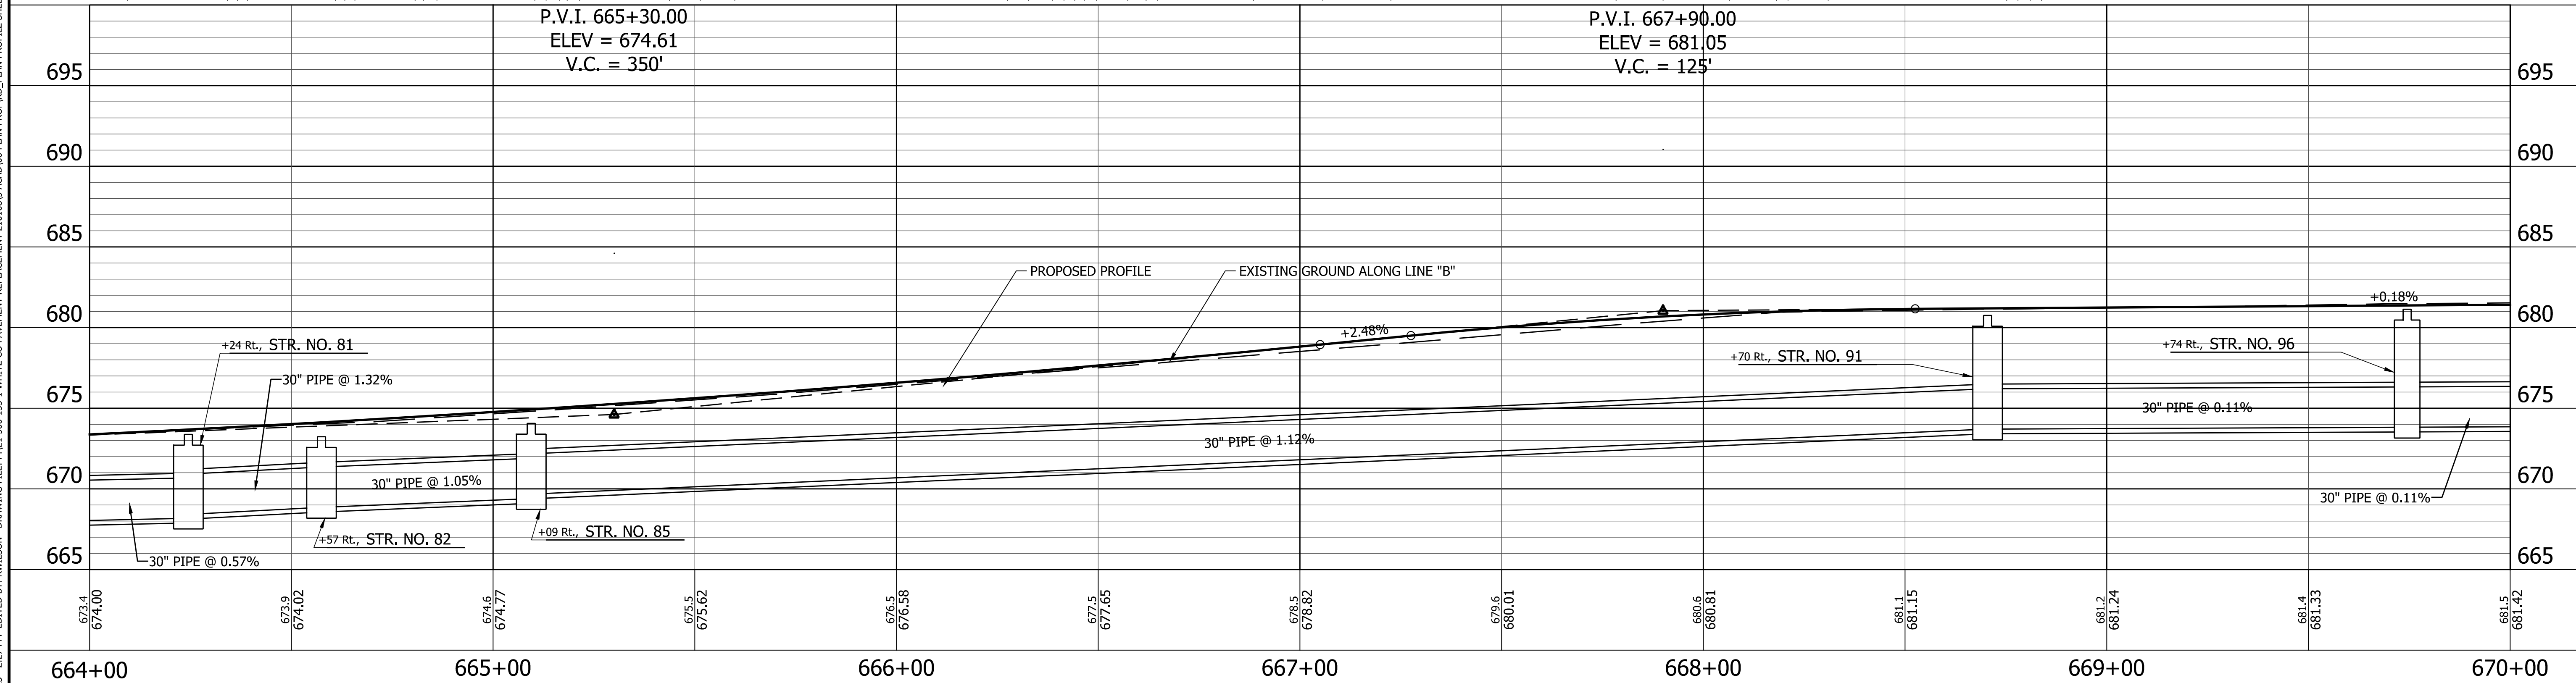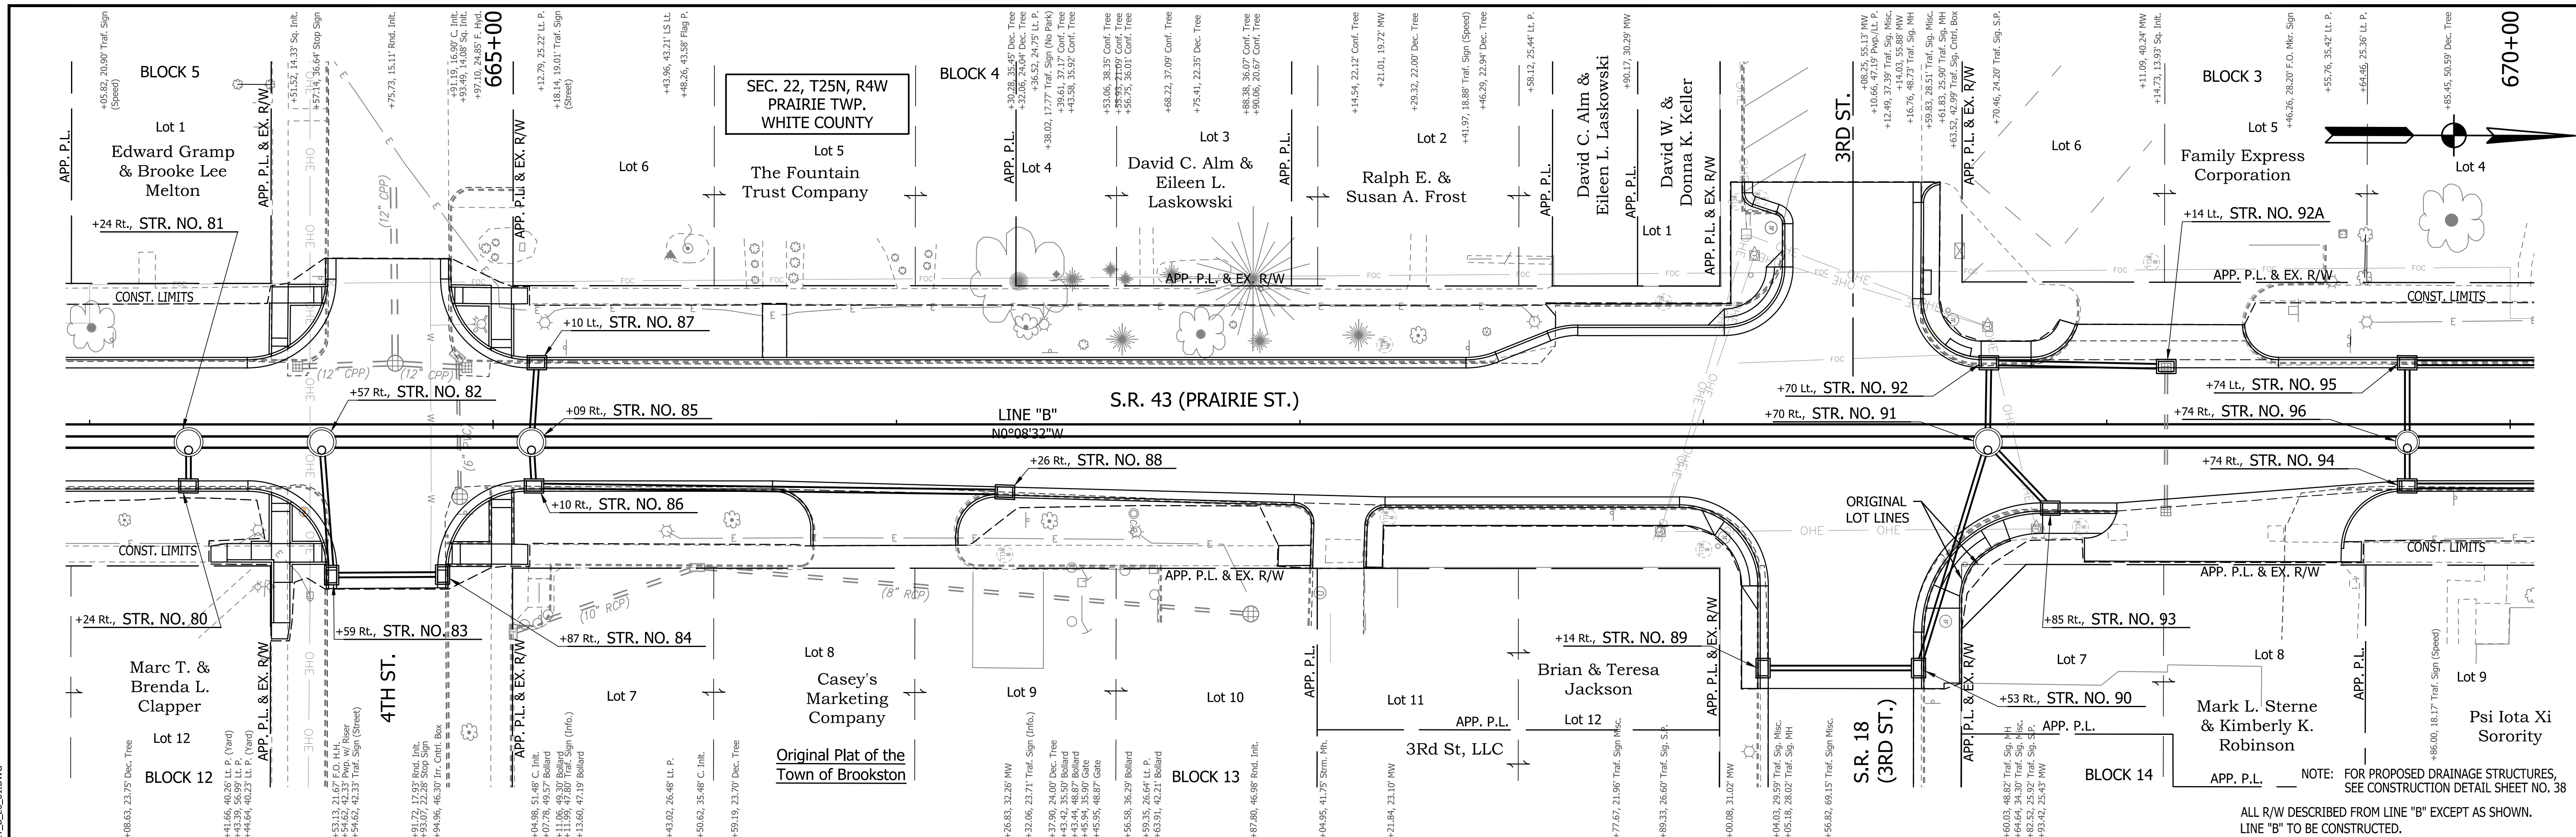INDIANA DEPARTMENT OF TRANSPORTATION	
PLAN AND PROFILE STA. 664+00.00 TO 670+00.00 LINE "B"	


HORIZONTAL SCALE	BRIDGE FILE
1" = 20'	N/A
VERTICAL SCALE	DESIGNATION
1" = 5'	2001828
SURVEY BOOK	SHEET
	22 of 117
CONTRACT	PROJECT
R-43449	2001828

NOTE: FOR PROPOSED DRAINAGE STRUCTURES, SEE CONSTRUCTION DETAIL SHEET NO. 38	
ALL R/W DESCRIBED FROM LINE "B" EXCEPT AS SHOWN. LINE "B" TO BE CONSTRUCTED.	






NOTE: FOR PROPOSED DRAINAGE STRUCTURES, SEE CONSTRUCTION DETAIL SHEET NO. 39  
 ALL R/W DESCRIBED FROM LINE "B" EXCEPT AS SHOWN. LINE "B" TO BE CONSTRUCTED.

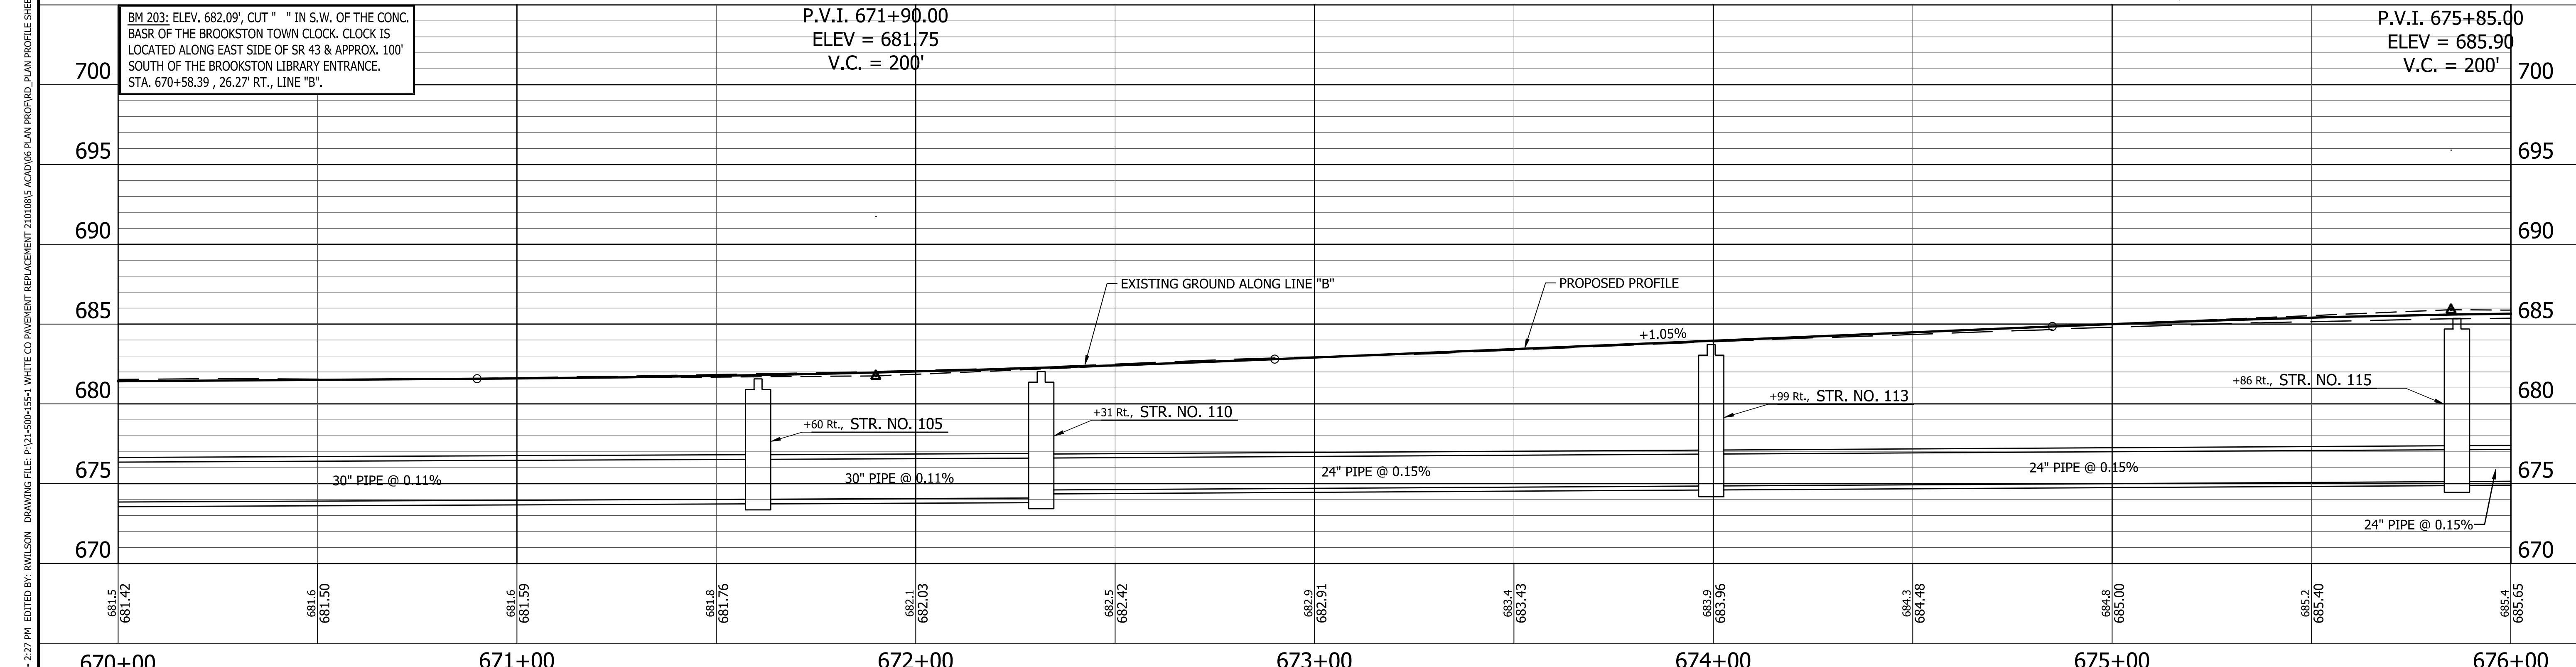


PRINT DATE: 4/5/23 PLOT SCALE: 1:1 EDIT DATE: 2/22/23 - 2:27 PM DRAWING FILE: P:\21-500-155-1 WHITE CO PAVEMENT REPLACEMENT 210108\ACAD\06 PLAN PROF\RD_PLAN_PROFILE_SHEET_B_20_01.DWG EDITOR: RWILSON	107 N: 265316.4851 E: 796139.8299 22-25N-4W Rebar w/ ROAW Control Cap	RECOMMENDED FOR APPROVAL _____ DESIGN ENGINEER _____ DATE _____	INDIANA DEPARTMENT OF TRANSPORTATION		HORIZONTAL SCALE 1" = 20' VERTICAL SCALE 1" = 5'	BRIDGE FILE N/A DESIGNATION 2001828
		DESIGNED: <u>BLW</u> CHECKED: <u>DCK</u>	DRAWN: <u>REW</u> CHECKED: <u>DCK</u>	PLAN AND PROFILE STA. 670+00.00 TO 676+00.00 LINE "B"		SURVEY BOOK _____ CONTRACT R-43449

PRINT DATE: 4/5/23  
PLOT SCALE: 1:1  
EDIT DATE: 2/22/23 - 2:27 PM  
EDITED BY: RWILSON  
DRAWING FILE: P:\21-500-155-1 WHITE CO PAVEMENT REPLACEMENT 210108\ACAD\06 PLAN PROF\RD\_PLAN\_PROFILE\_SHEET\_B\_20\_01.DWG

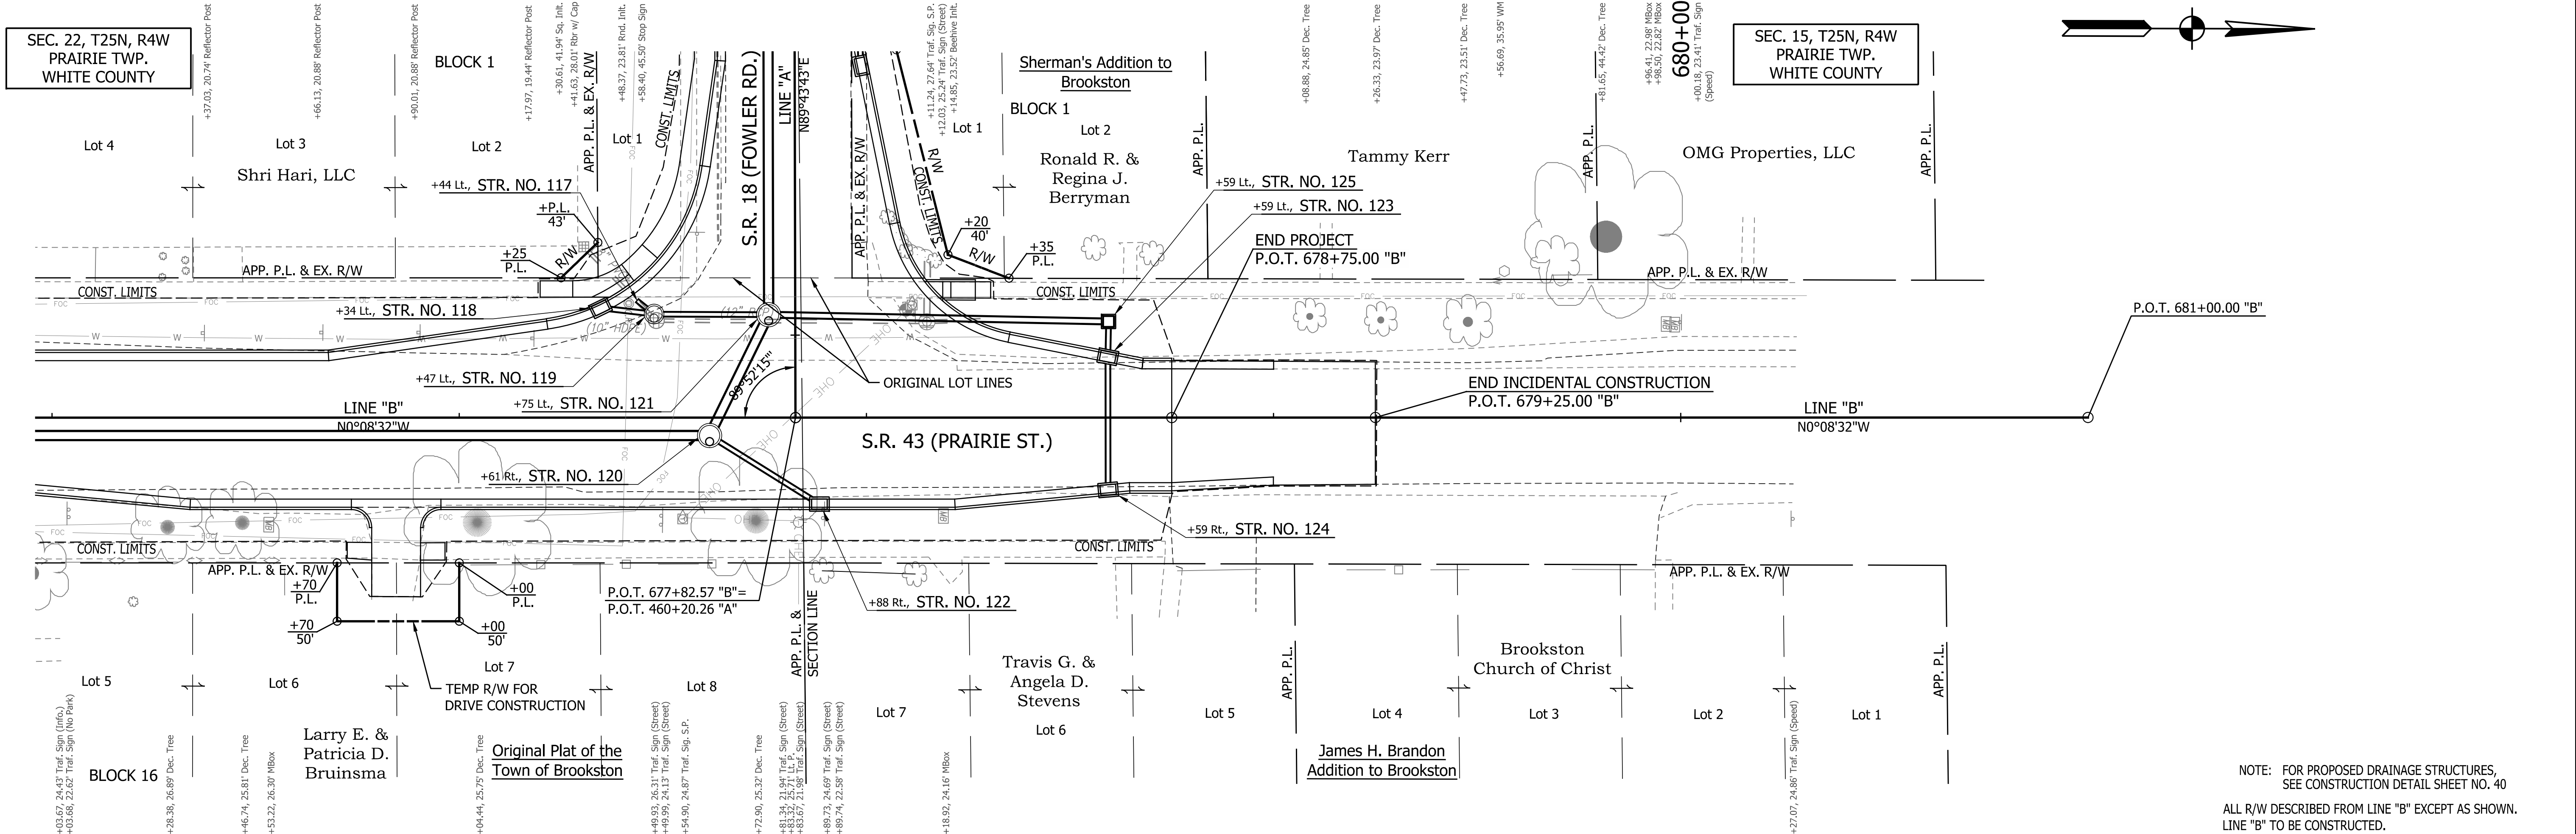

NOTE: FOR PROPOSED DRAINAGE STRUCTURES, SEE CONSTRUCTION DETAIL SHEET NO. 40  
ALL R/W DESCRIBED FROM LINE "B" EXCEPT AS SHOWN. LINE "B" TO BE CONSTRUCTED.

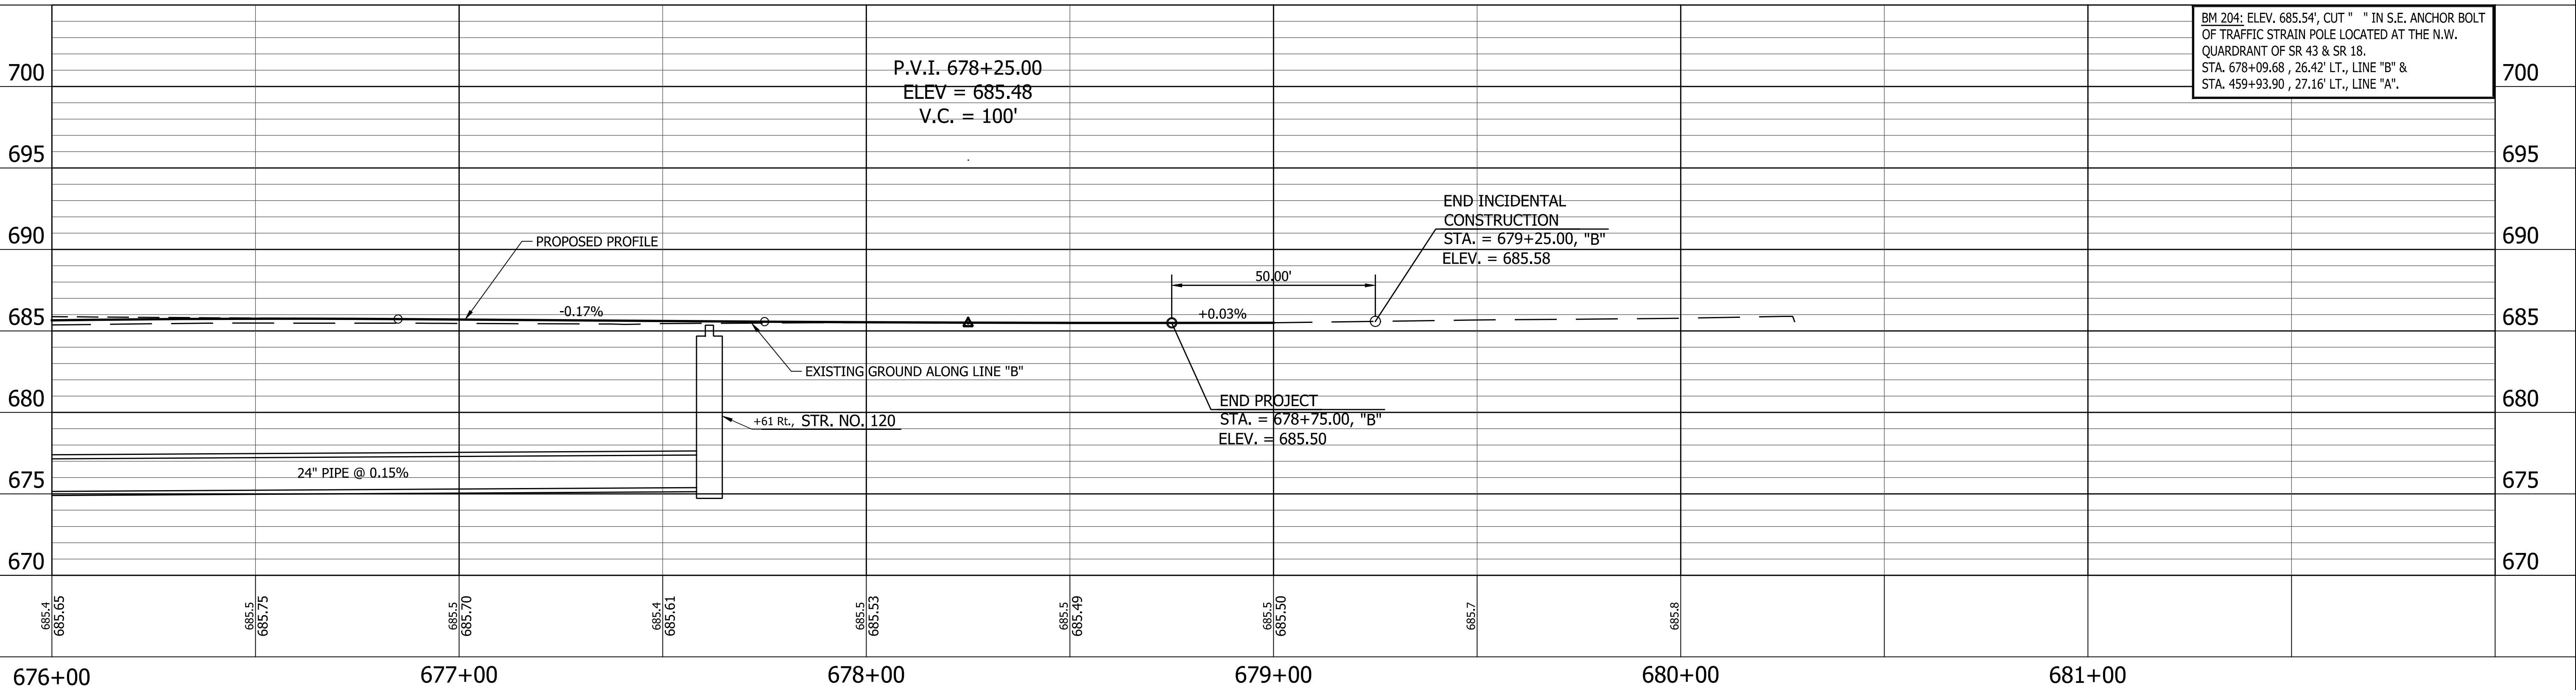

BM 204: ELEV. 685.54', CUT " " IN S.E. ANCHOR BOLT OF TRAFFIC STRAIN POLE LOCATED AT THE N.W. QUADRANT OF SR 43 & SR 18. STA. 678+09.68, 26.42' LT., LINE "B" & STA. 459+93.90, 27.16' LT., LINE "A".

108  
N: 265727.2883  
E: 796086.9823

SR 18 / Fowler Rd.  
Sta. 678.97  
315

22-25N-4W  
Rebar w/ ROAW Control Cap

RECOMMENDED FOR APPROVAL	DESIGN ENGINEER	DATE
DESIGNED: <u>BLW</u>	DRAWN: <u>REW</u>	
CHECKED: <u>DCK</u>	CHECKED: <u>DCK</u>	


INDIANA DEPARTMENT OF TRANSPORTATION

PLAN AND PROFILE  
STA. 676+00.00 TO 681+00.00 LINE "B"


HORIZONTAL SCALE 1" = 20'	BRIDGE FILE N/A
VERTICAL SCALE 1" = 5'	DESIGNATION 2001828
SURVEY BOOK	SHEET 24 of 117
CONTRACT R-43449	PROJECT 2001828





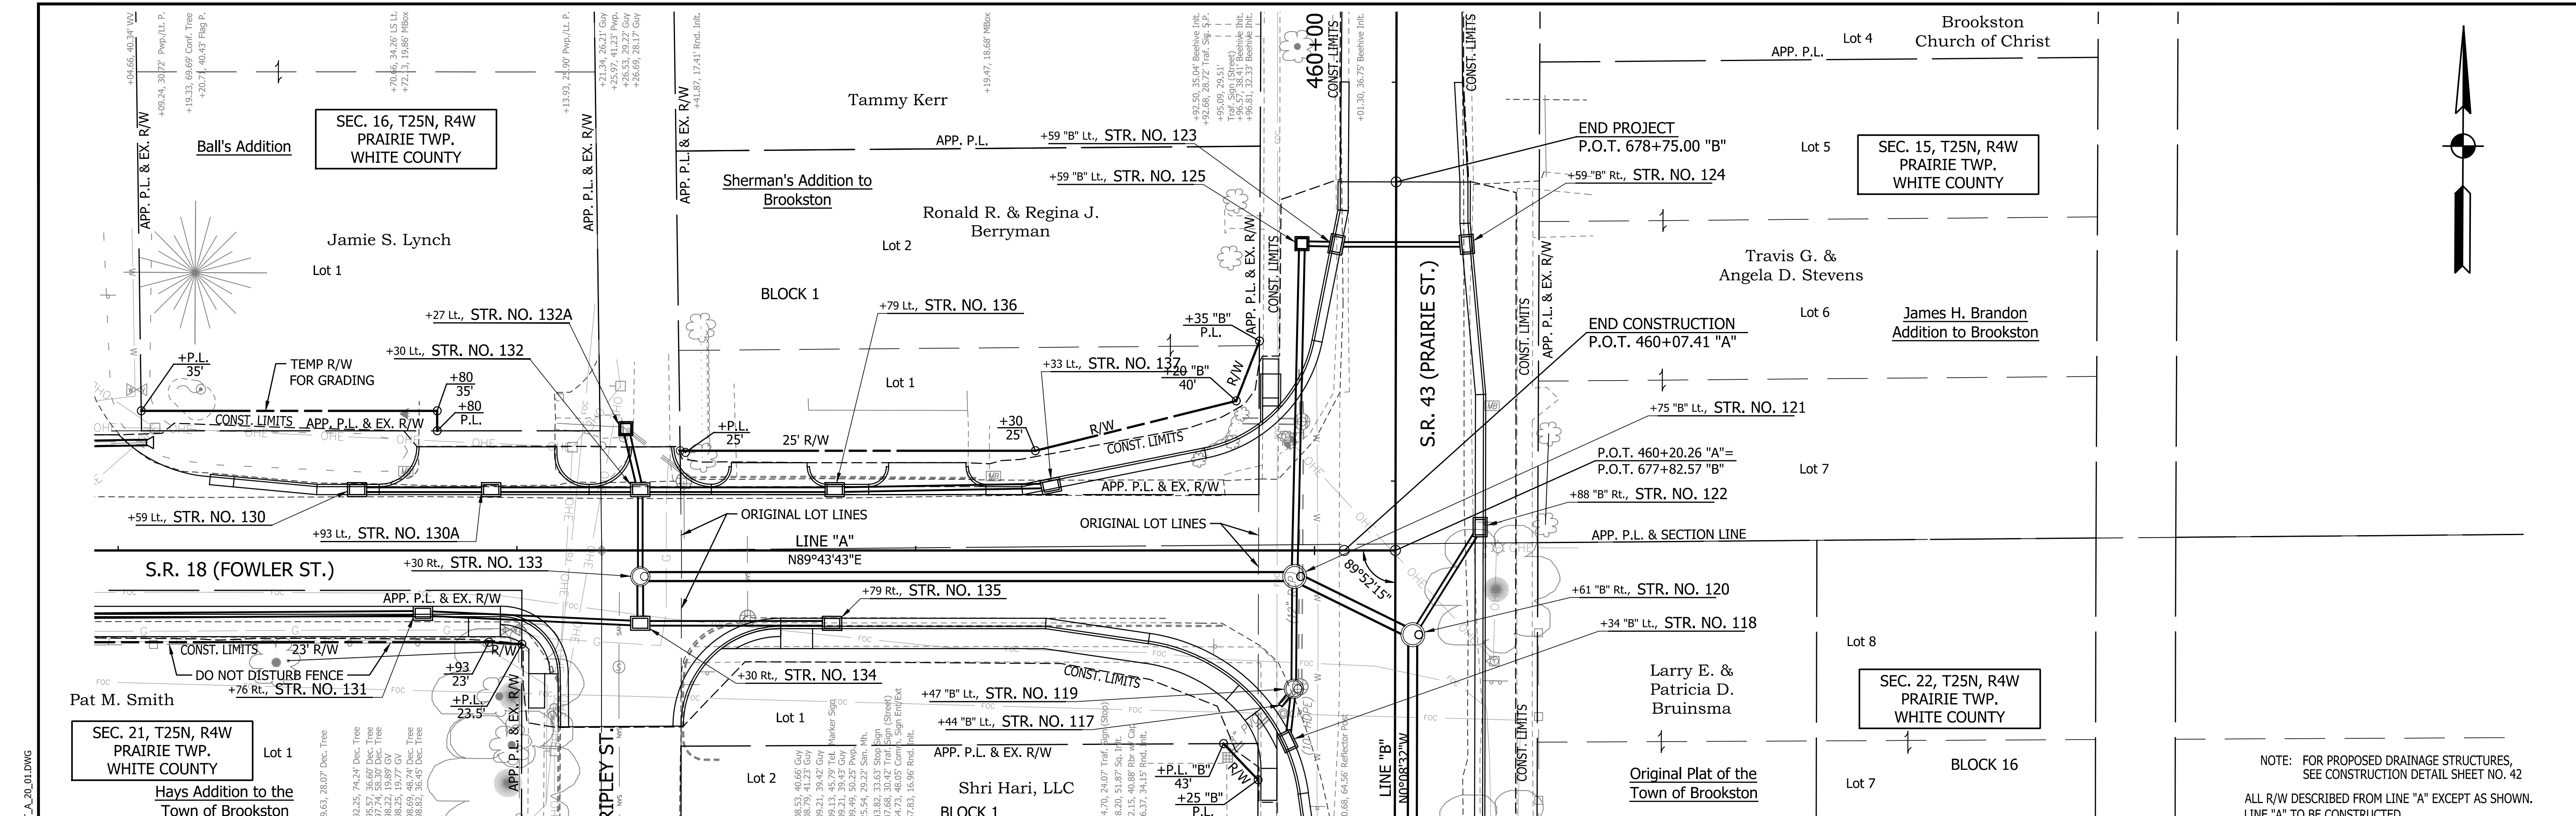

NOTE: FOR PROPOSED DRAINAGE STRUCTURES, SEE CONSTRUCTION DETAIL SHEET NO. 42  
 ALL R/W DESCRIBED FROM LINE "A" EXCEPT AS SHOWN. LINE "A" TO BE CONSTRUCTED.

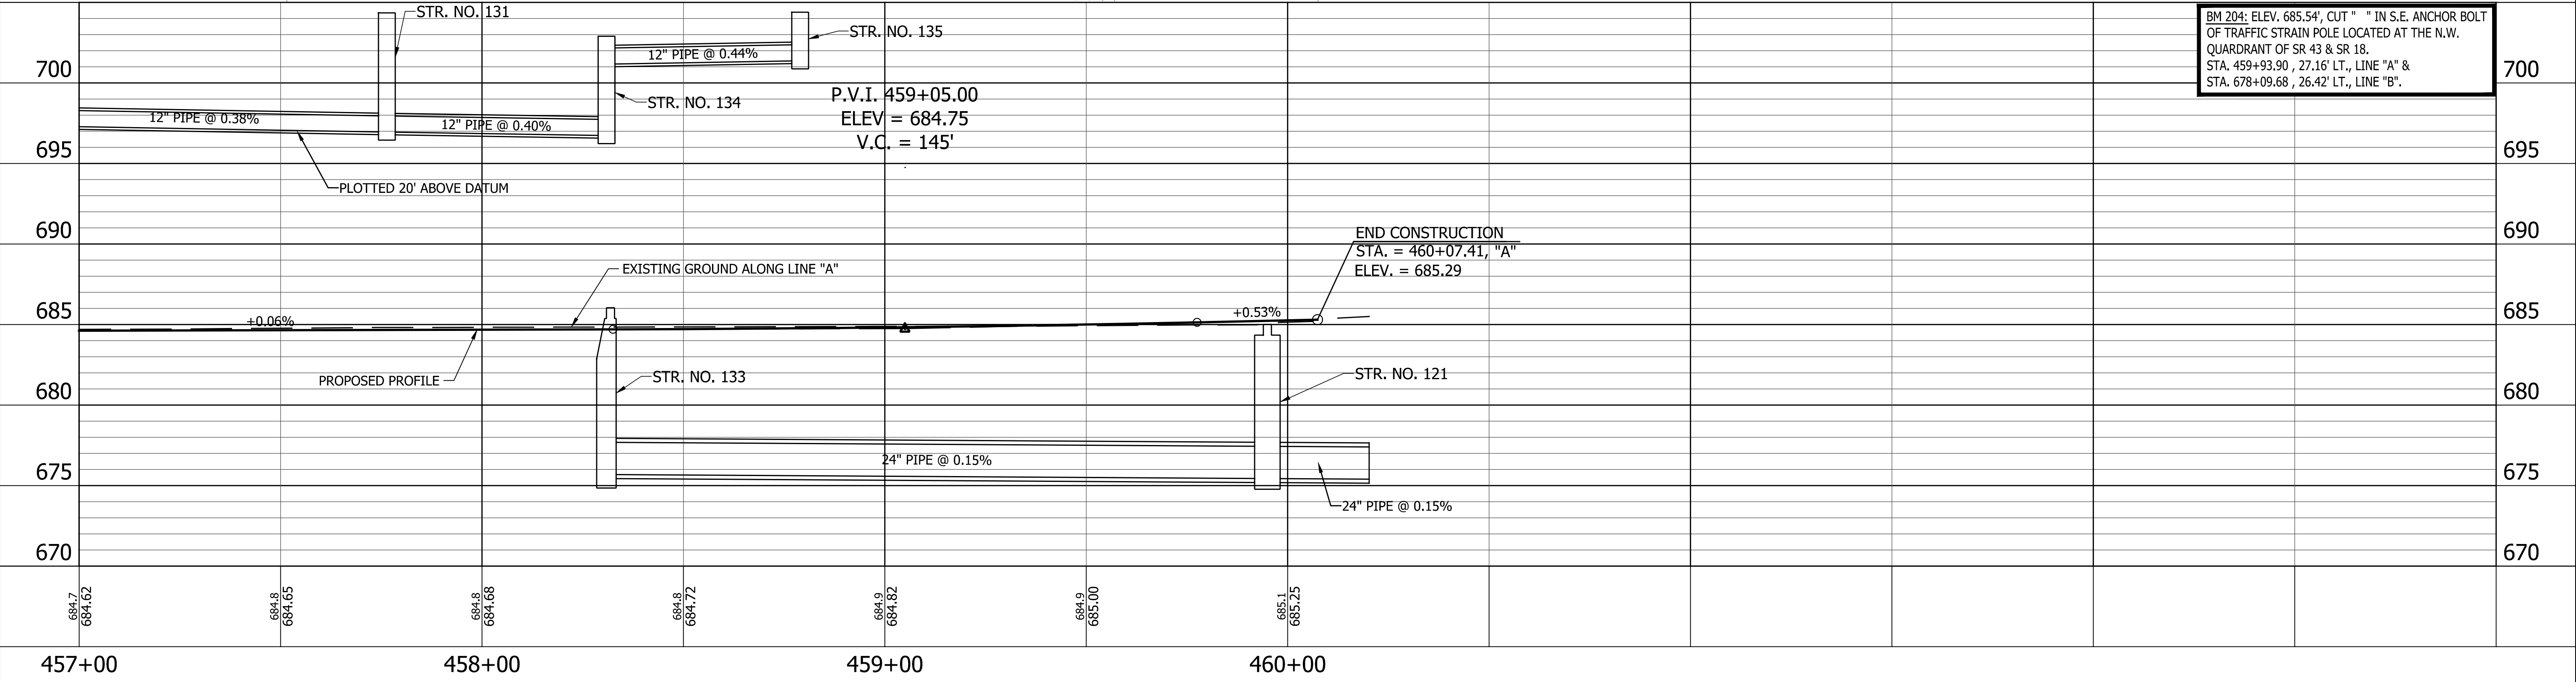

BM 204: ELEV. 685.54', CUT " " IN S.E. ANCHOR BOLT OF TRAFFIC STRAIN POLE LOCATED AT THE N.W. QUADRANT OF SR 43 & SR 18. STA. 459+93.90, 27.16' LT., LINE "A" & STA. 678+09.68, 26.42' LT., LINE "B".

PRINT DATE: 4/5/23  
 PLOT SCALE: 1:1  
 EDIT DATE: 4/5/23 - 1:19 PM  
 EDITED BY: EKOWALSKI  
 DRAWING FILE: P:\21-500-155-1 WHITE CO PAVEMENT REPLACEMENT 2101085 ACAD\6 PLAN PROF\RD\_PLAN\_PROFILE\_SHEET\_A\_20\_01.DWG

108  
 N: 265727.2883  
 E: 796086.9823  
 SR 18 / Fowler St.  
 315  
 22-25N-4W  
 5/8" Rebar w/ R/WAW | Cap

LEGEND	
(F) Concrete Sidewalk, 4"	(W) Widening with HMA, Type C
(K) Full Depth Asphalt Pavement (See Typical Sections)	(14) Mod. Concrete Rolled Curb (Sloping)
(K) Full Depth Asphalt Pavement (See Typical Sections)	(15) Combined Concrete Curb & Gutter
(R) Milling, Asphalt 1.5" (See Typical Sections)	(16) Curb, Concrete (Vertical)
	(X) Sidewalk Curb Ramp

RECOMMENDED FOR APPROVAL	DESIGN ENGINEER	DATE
DESIGNED: BLW	DRAWN: REW	
CHECKED: DCK	CHECKED: DCK	


INDIANA  
 DEPARTMENT OF TRANSPORTATION

PLAN AND PROFILE  
 STA. 457+00.00 TO 460+20.26 LINE "A"


HORIZONTAL SCALE 1" = 20'	BRIDGE FILE N/A
VERTICAL SCALE 1" = 5'	DESIGNATION 2001828
SURVEY BOOK	SHEET
	26 of 117
CONTRACT R-43449	PROJECT 2001828




LINE "B" STR. 11 - STR. 12

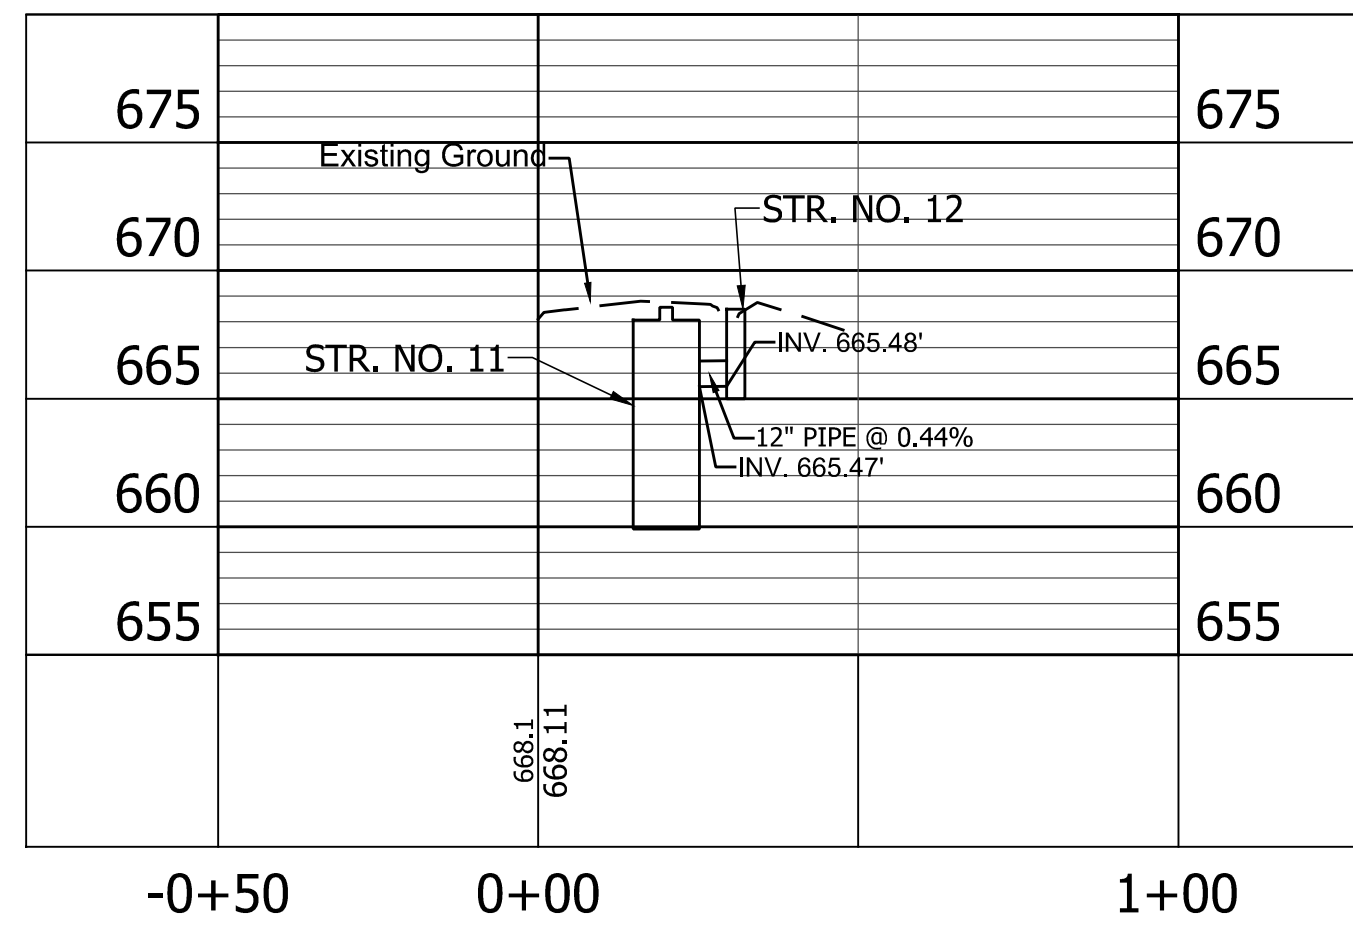


LINE "B" STR. 14 - STR. 15

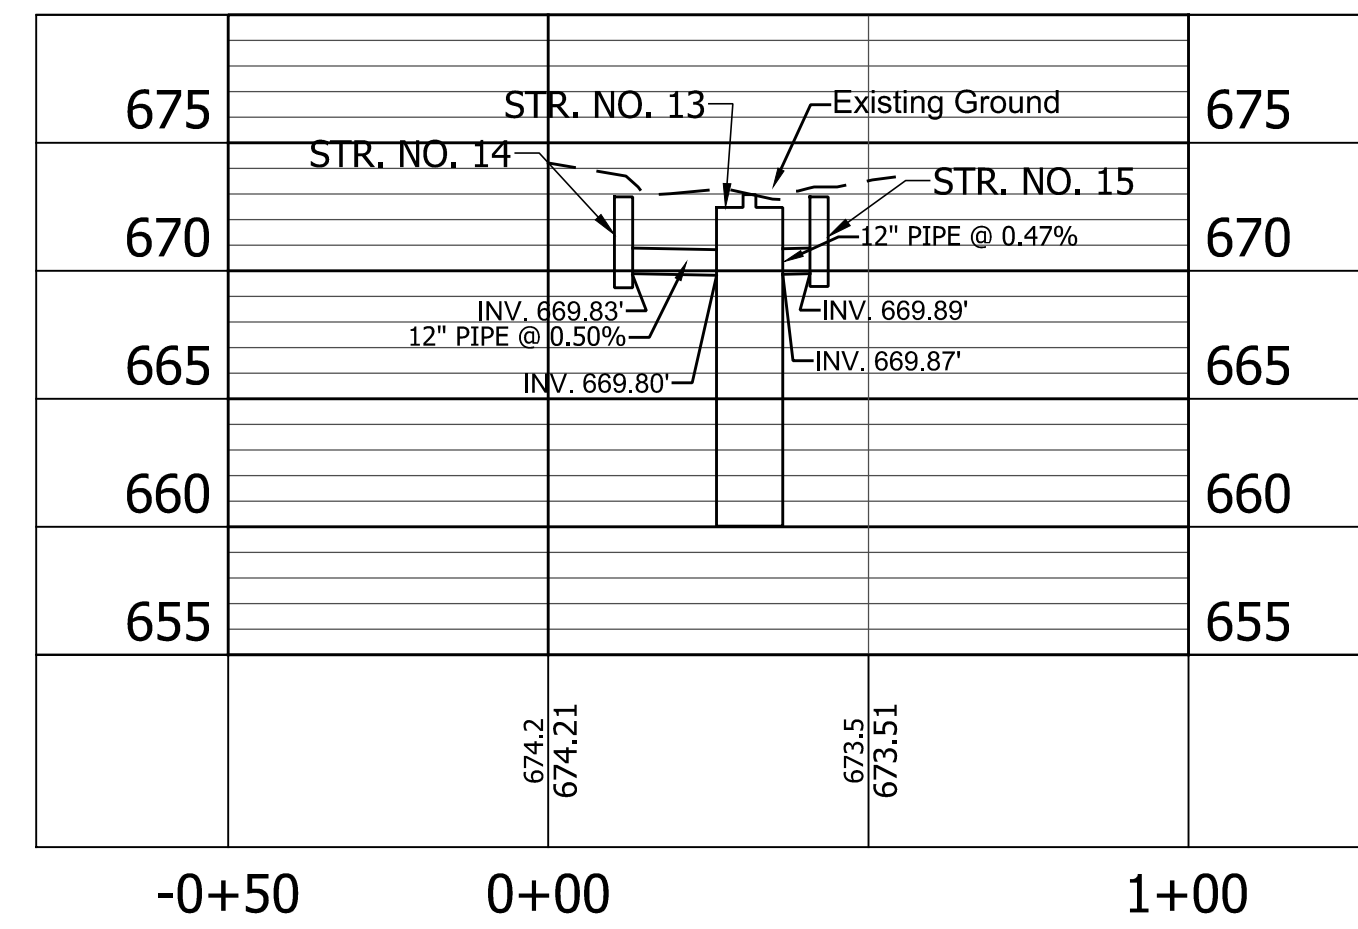


LINE "B" STR. 17 - STR. 16

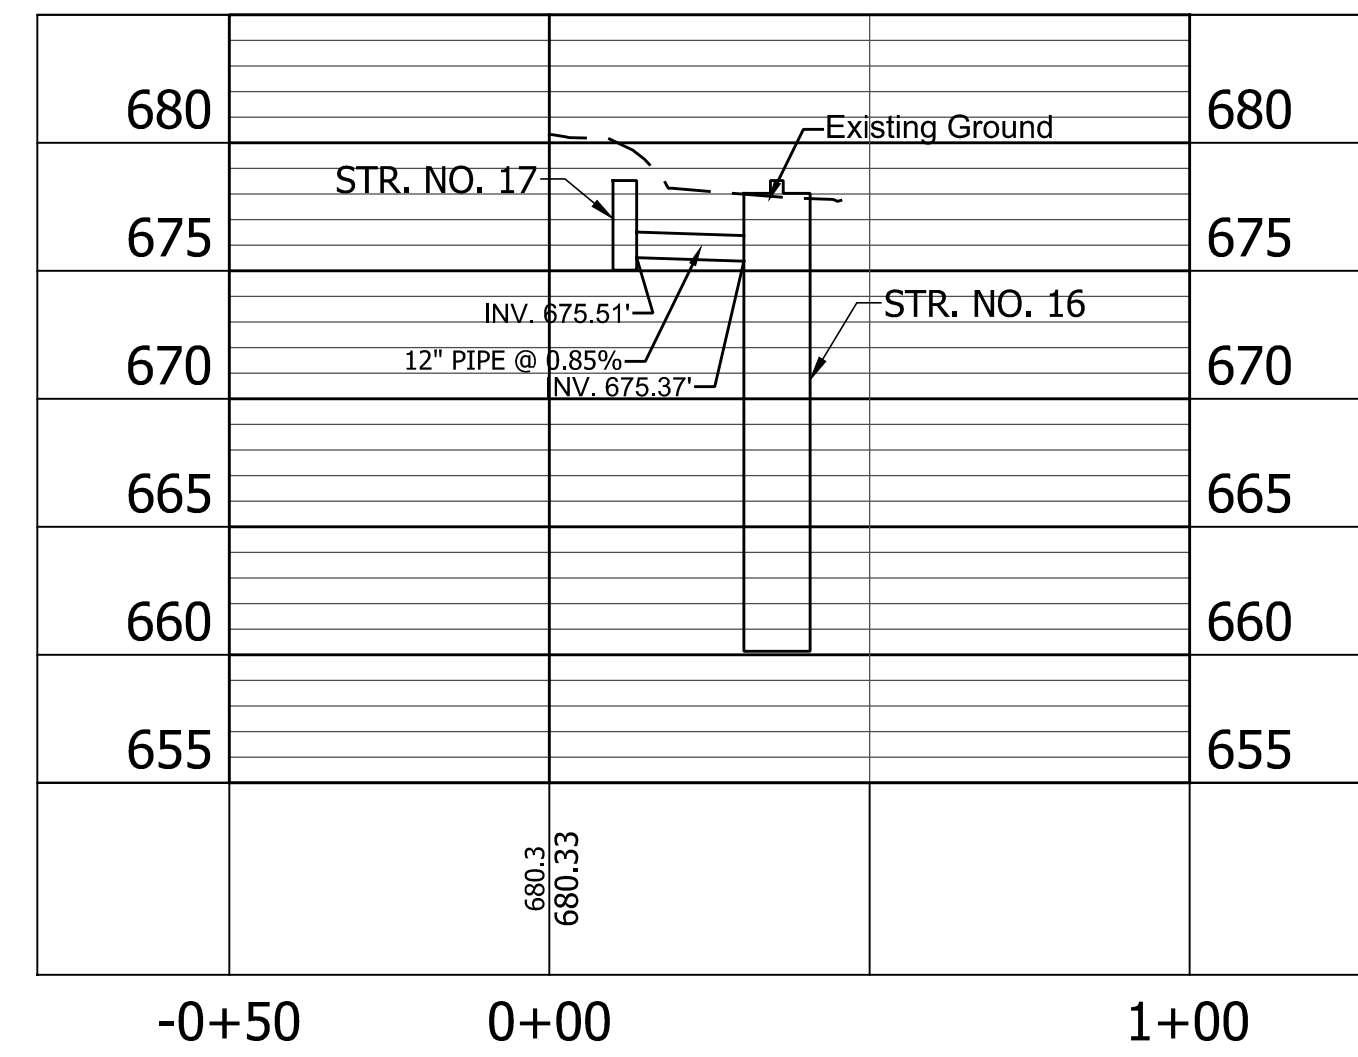


LINE "B" STR. 19 - STR. 18

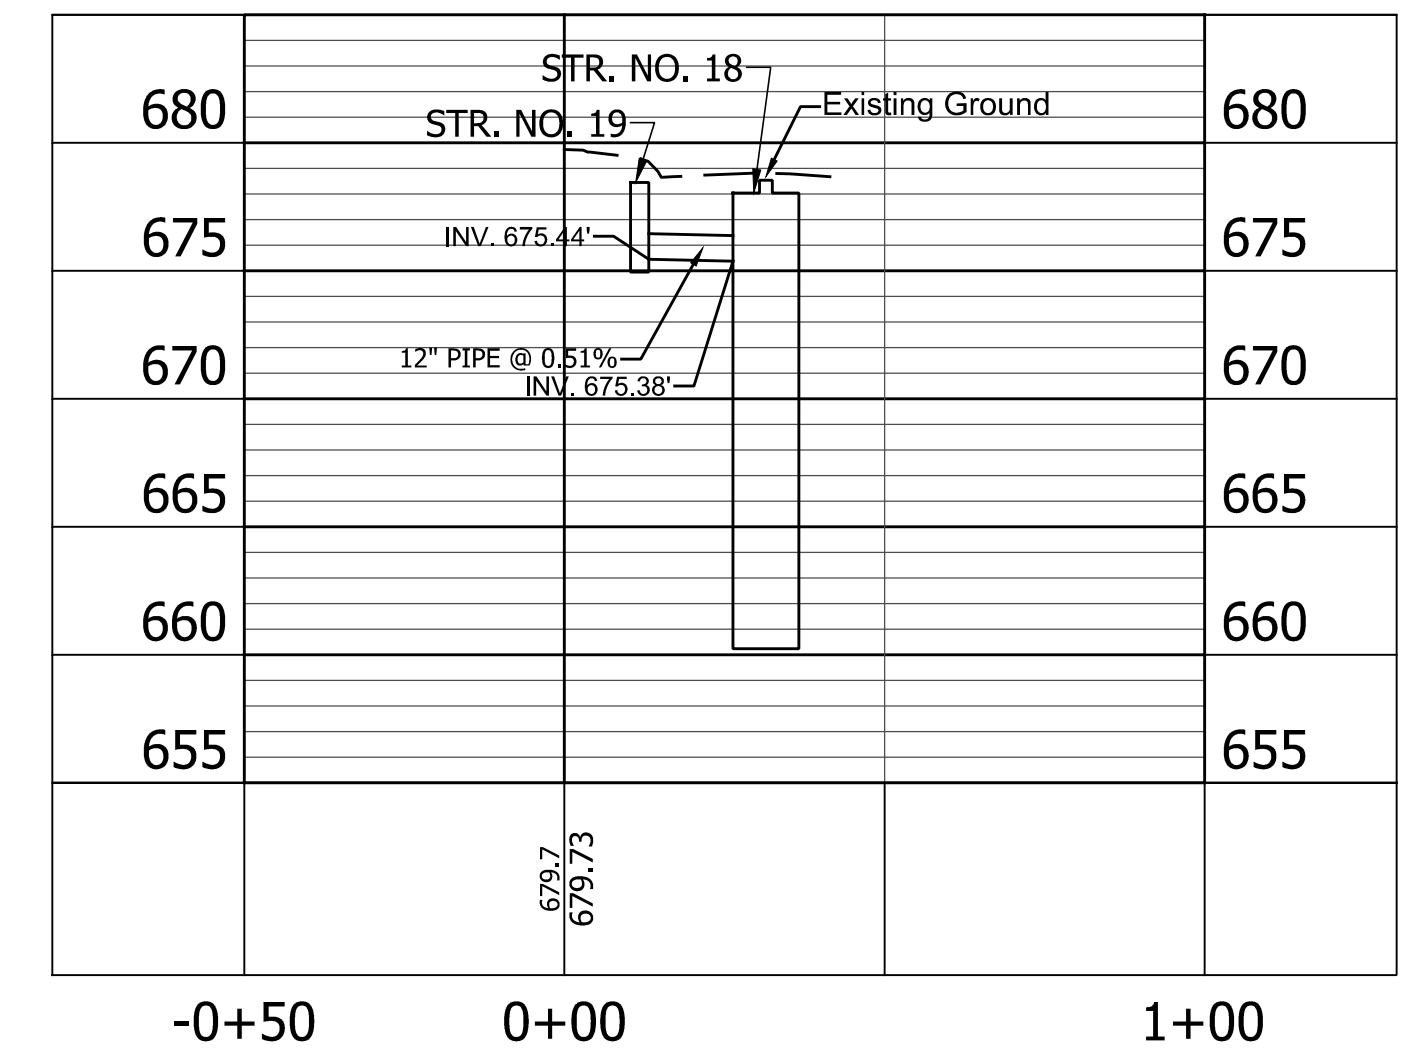


LINE "B" STR. 23 - STR. 20

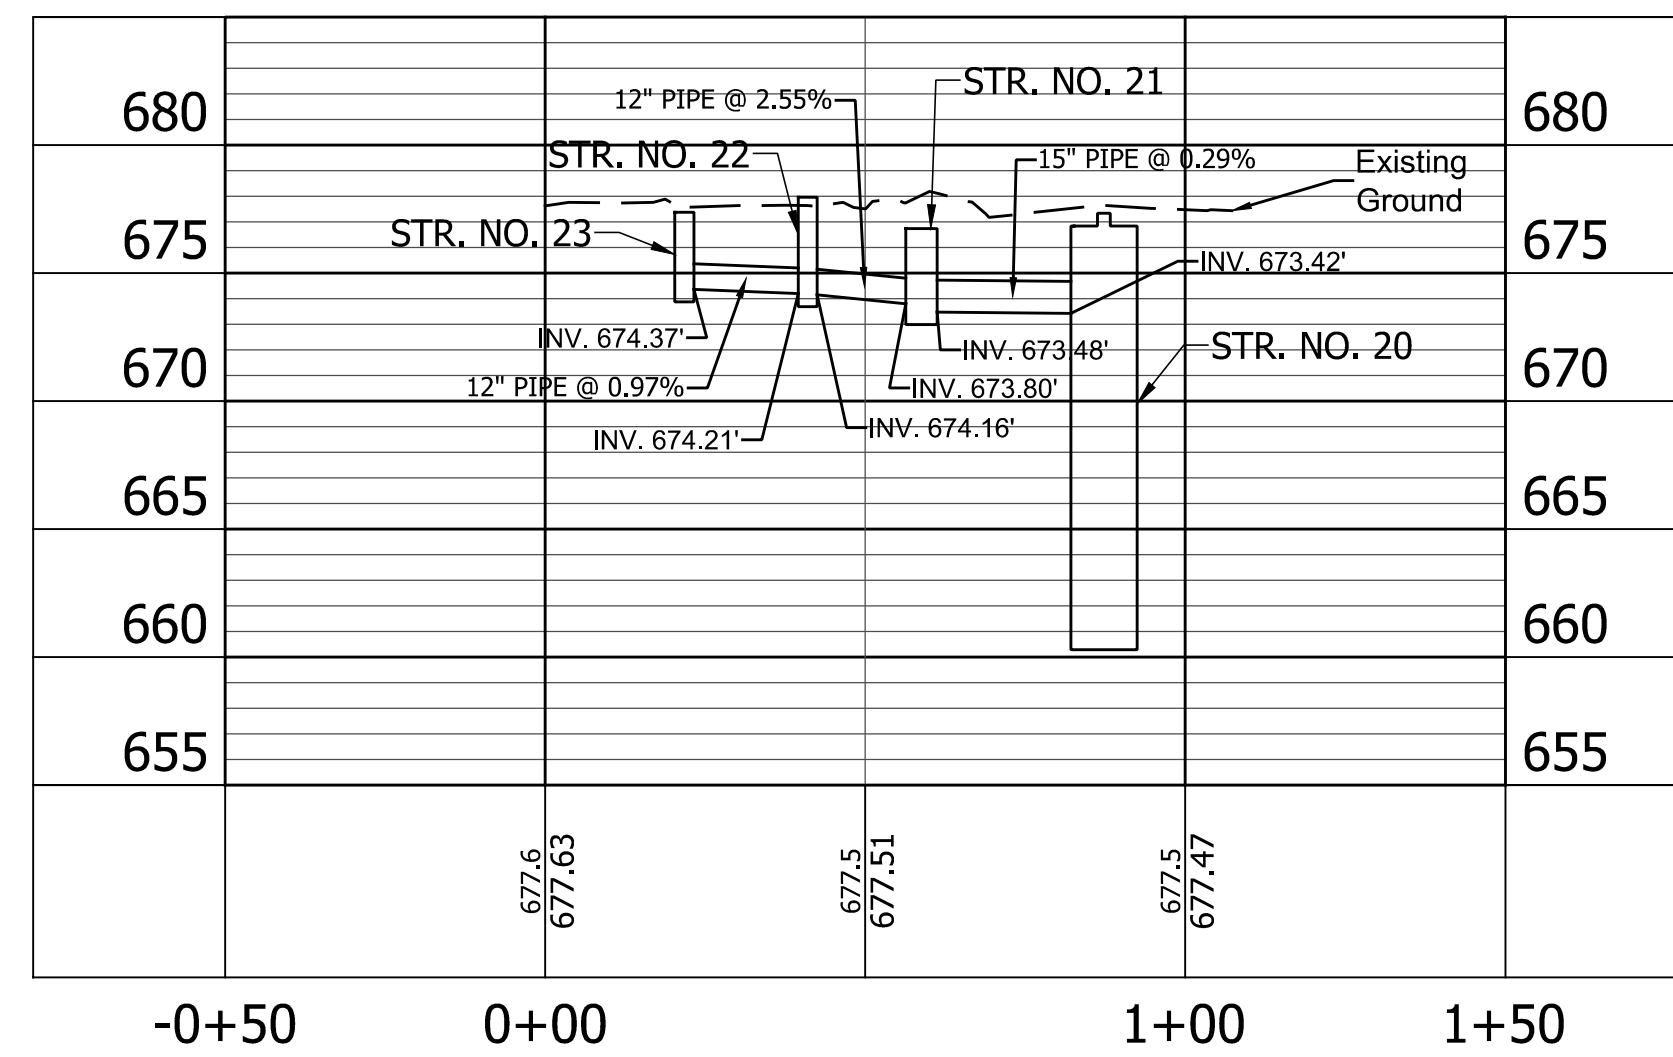

LINE "B" STR. 24 - STR. 25

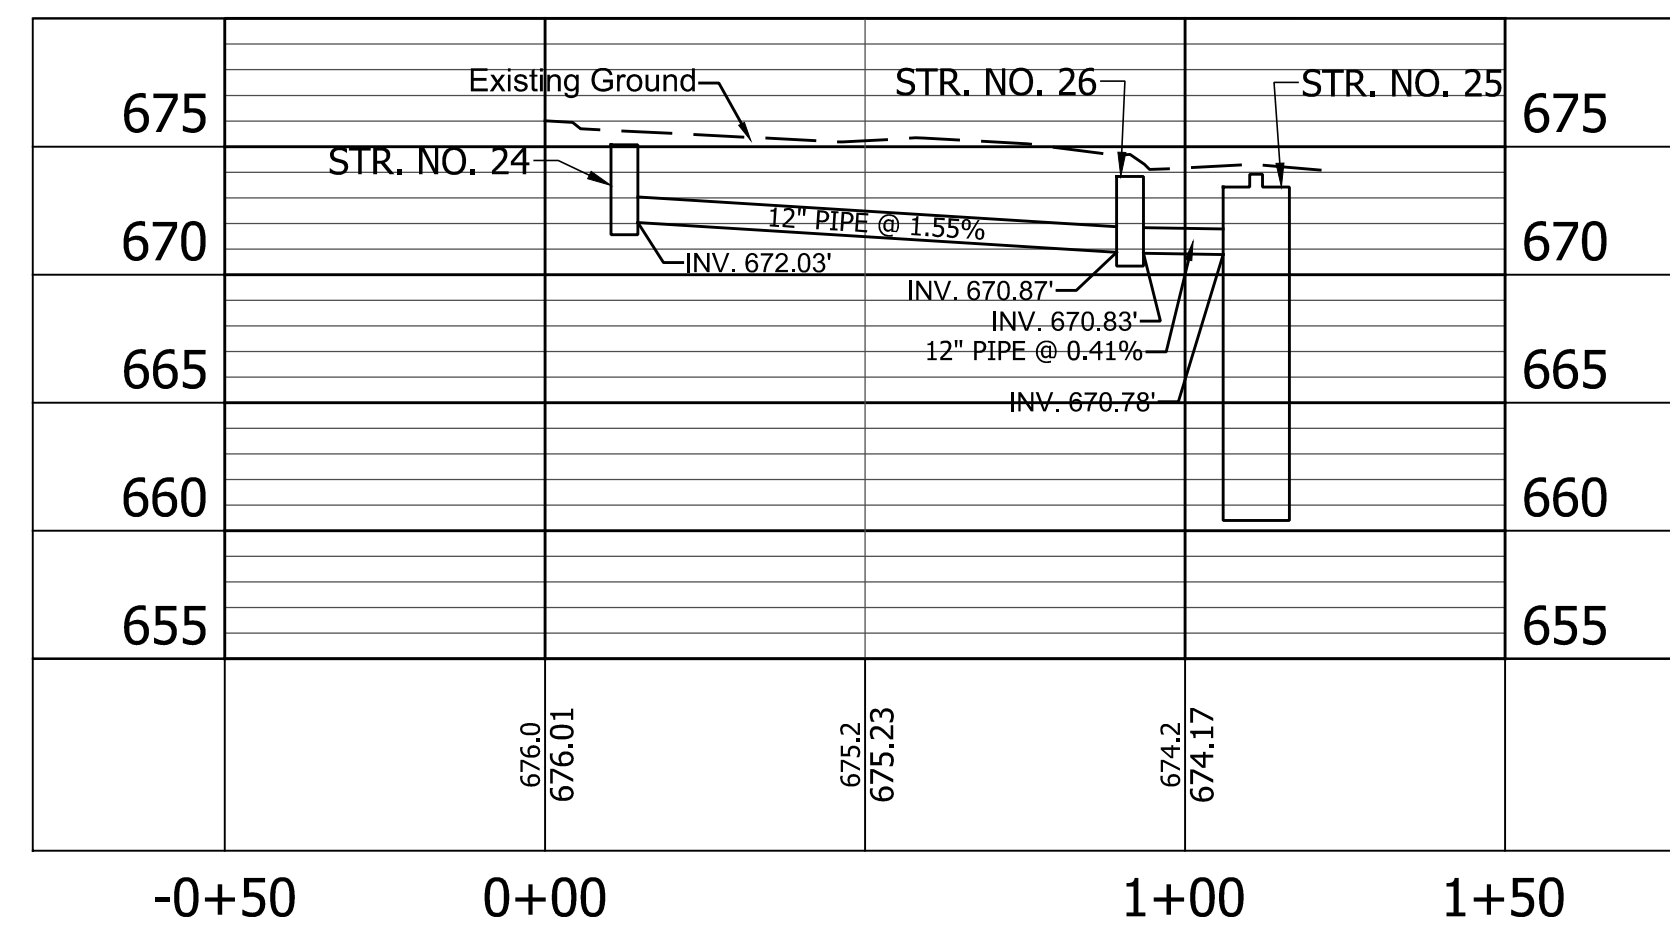


LINE "B" STR. 29 - STR. 28

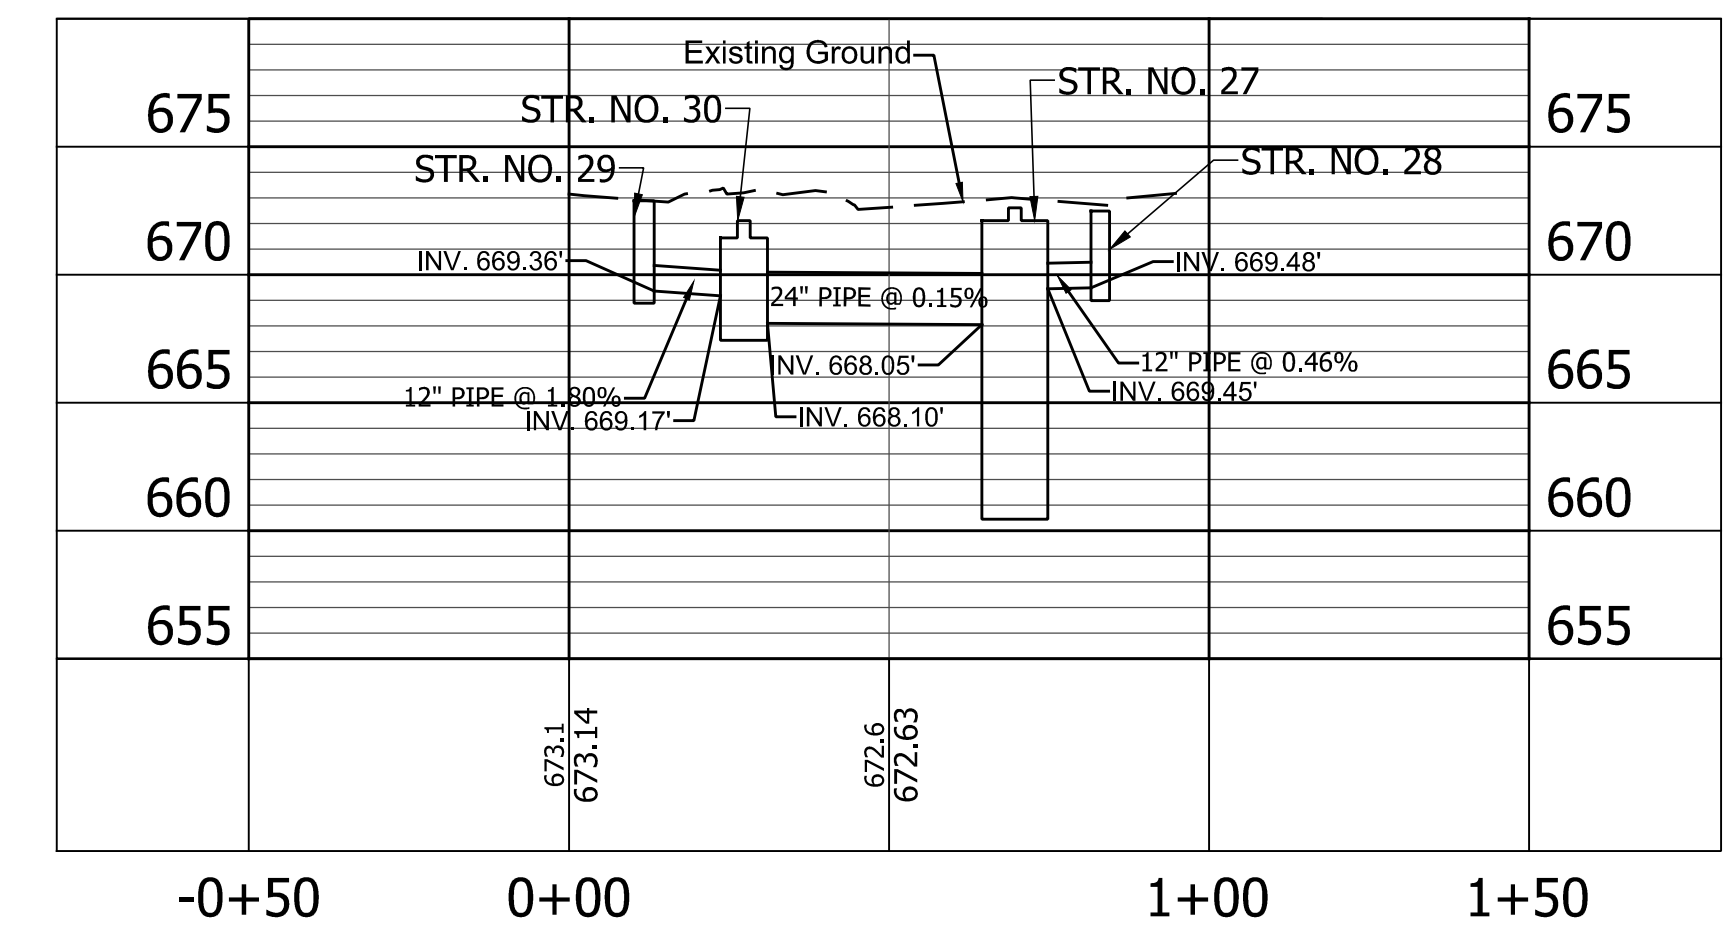


PRINT DATE: 4/5/23 PLOT SCALE: 1:1 EDIT DATE: 2/22/23 - 11:34 AM EDITED BY: EKOWALSKI DRAWING FILE: P:\21-500-155-1 WHITE CO PAVEMENT REPLACEMENT 21010815 ACAD\06 PLAN\_PROF\RD\_STORM PROFILE SHEET\_A-B\_20\_01.DWG

RECOMMENDED FOR APPROVAL _____ DESIGN ENGINEER DATE		INDIANA DEPARTMENT OF TRANSPORTATION		HORIZONTAL SCALE	BRIDGE FILE
				1" = 20'	N/A
DESIGNED: <u>BLW</u> DRAWN: <u>EJK</u>		STORM SEWER LINE "B" STORM PROFILES_01		VERTICAL SCALE	DESIGNATION
				1" = 5'	2001828
CHECKED: <u>DCK</u> CHECKED: <u>DCK</u>				SURVEY BOOK	SHEET
					27 of 117
				CONTRACT	PROJECT
				R-43449	2001828


LINE "B" STR. 31 - STR. 34

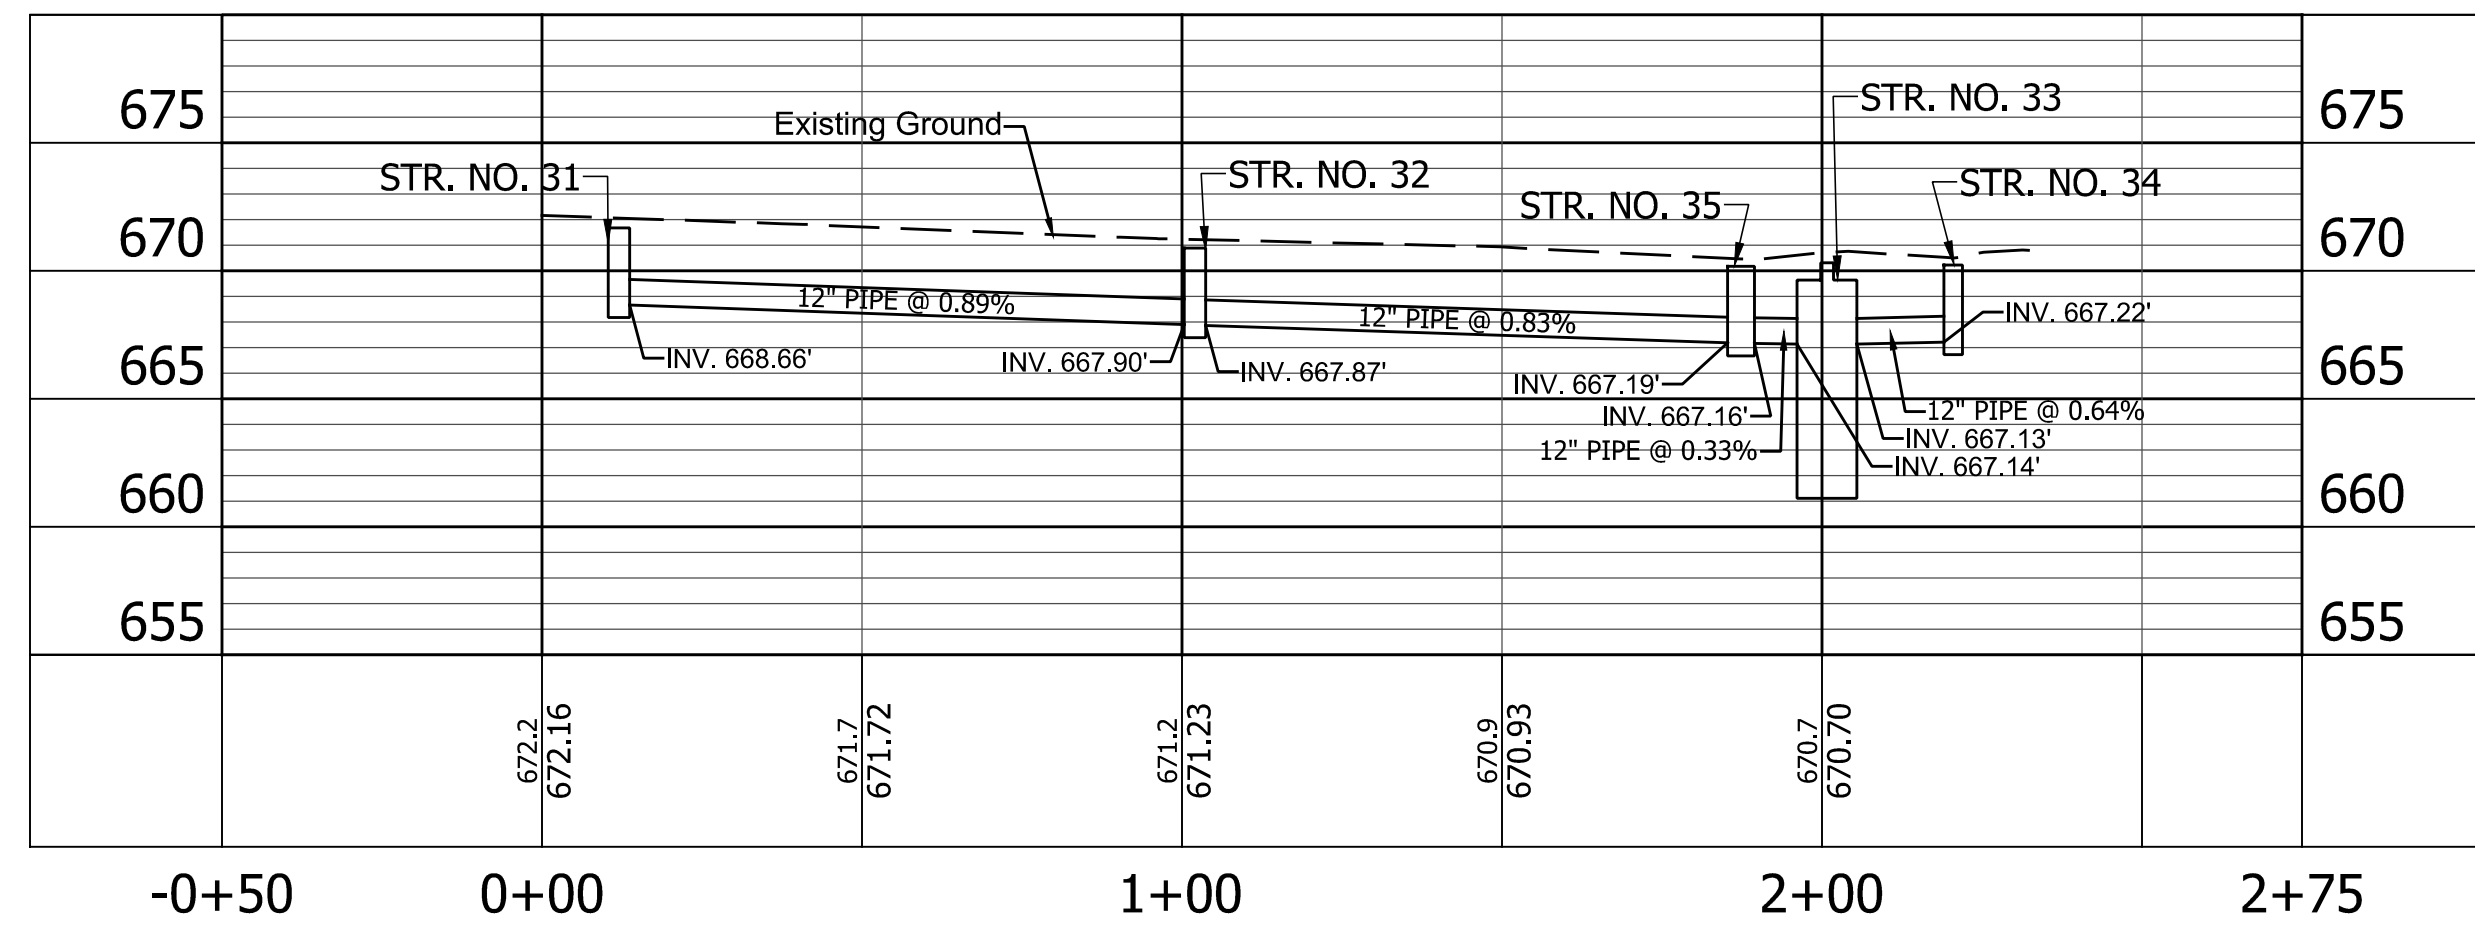


LINE "B" STR. 40 - STR. 41

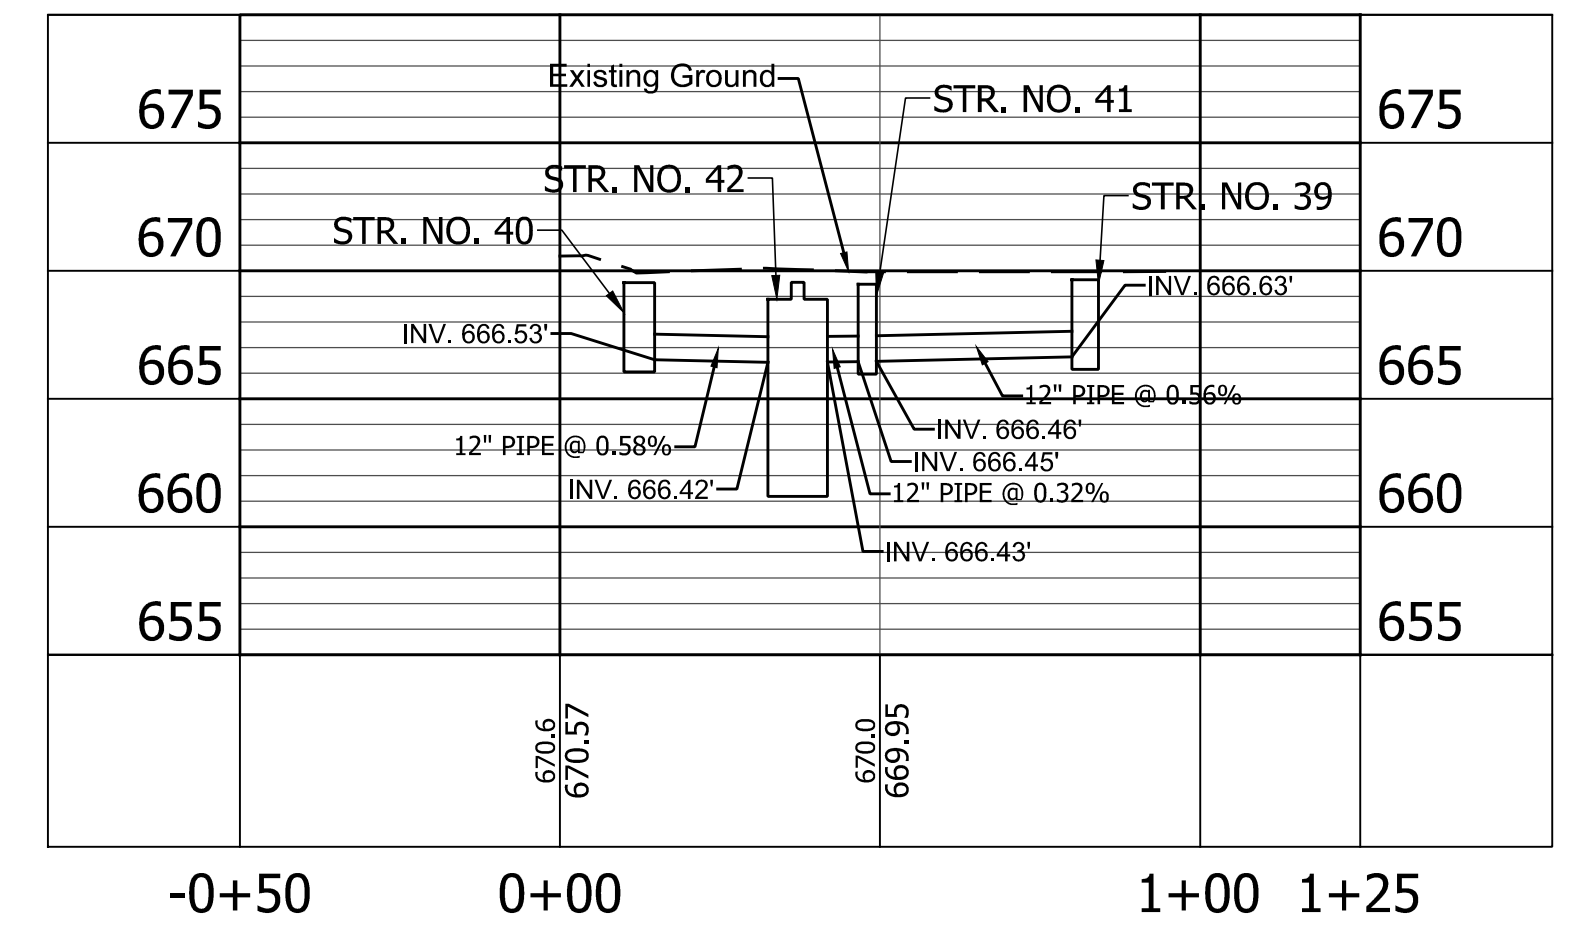


STR. 37 - STR. 37A

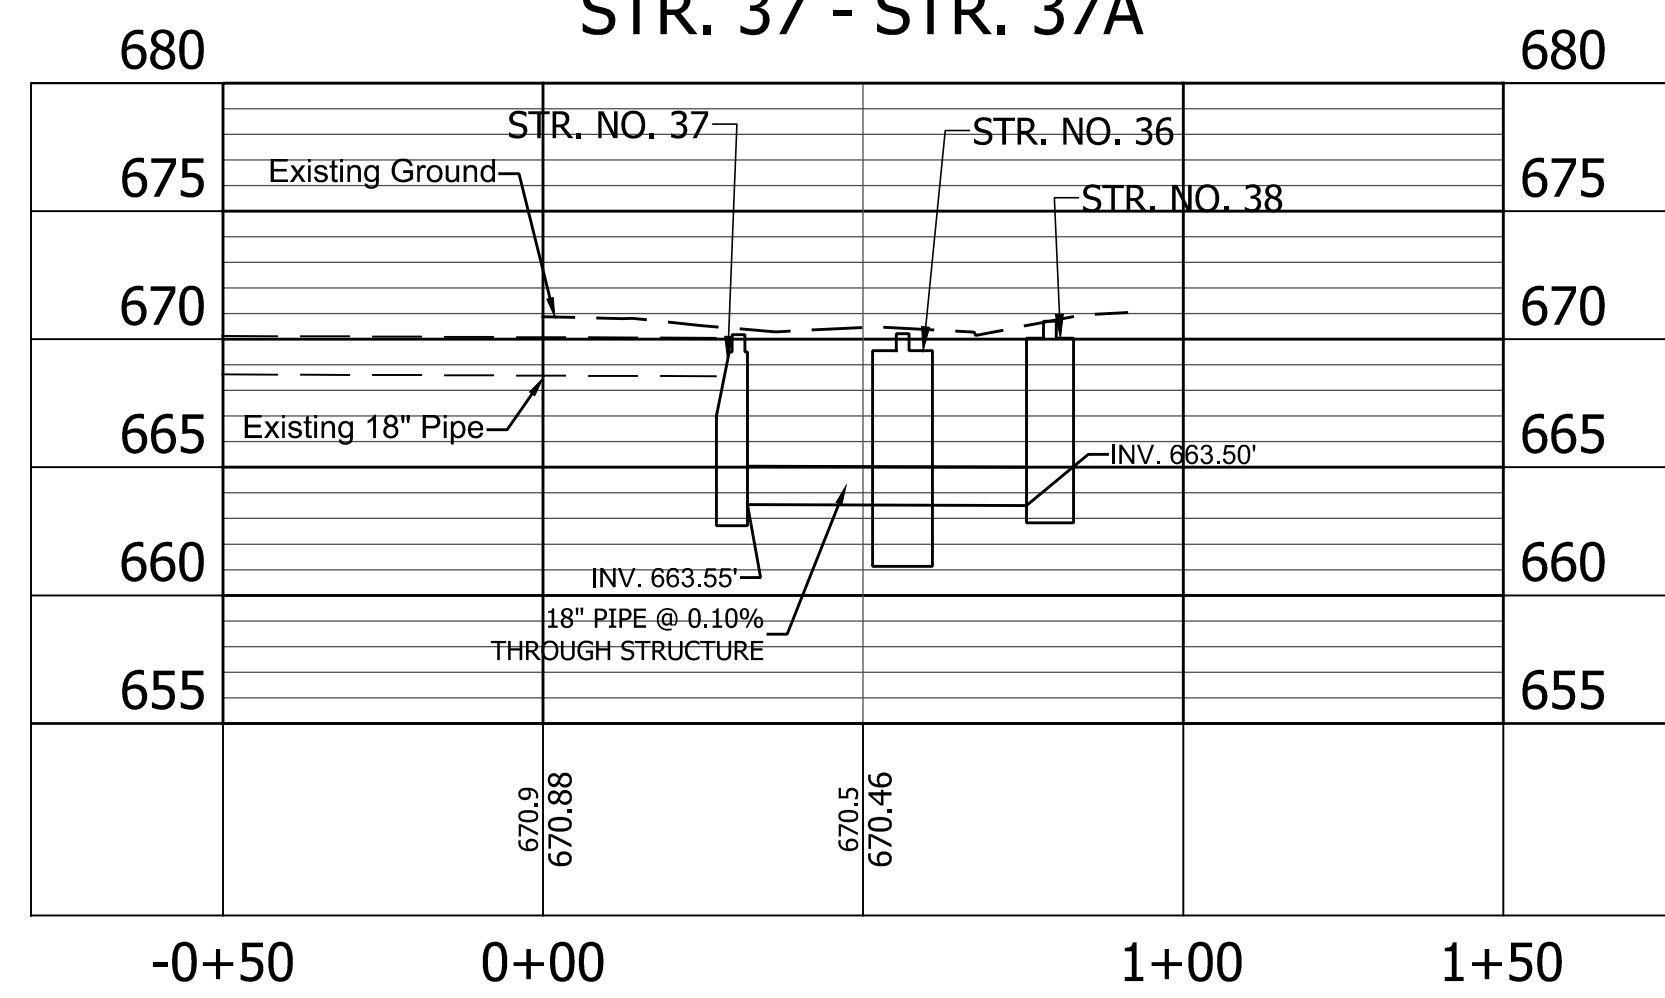


LINE "B" STR. 43 - STR. 48

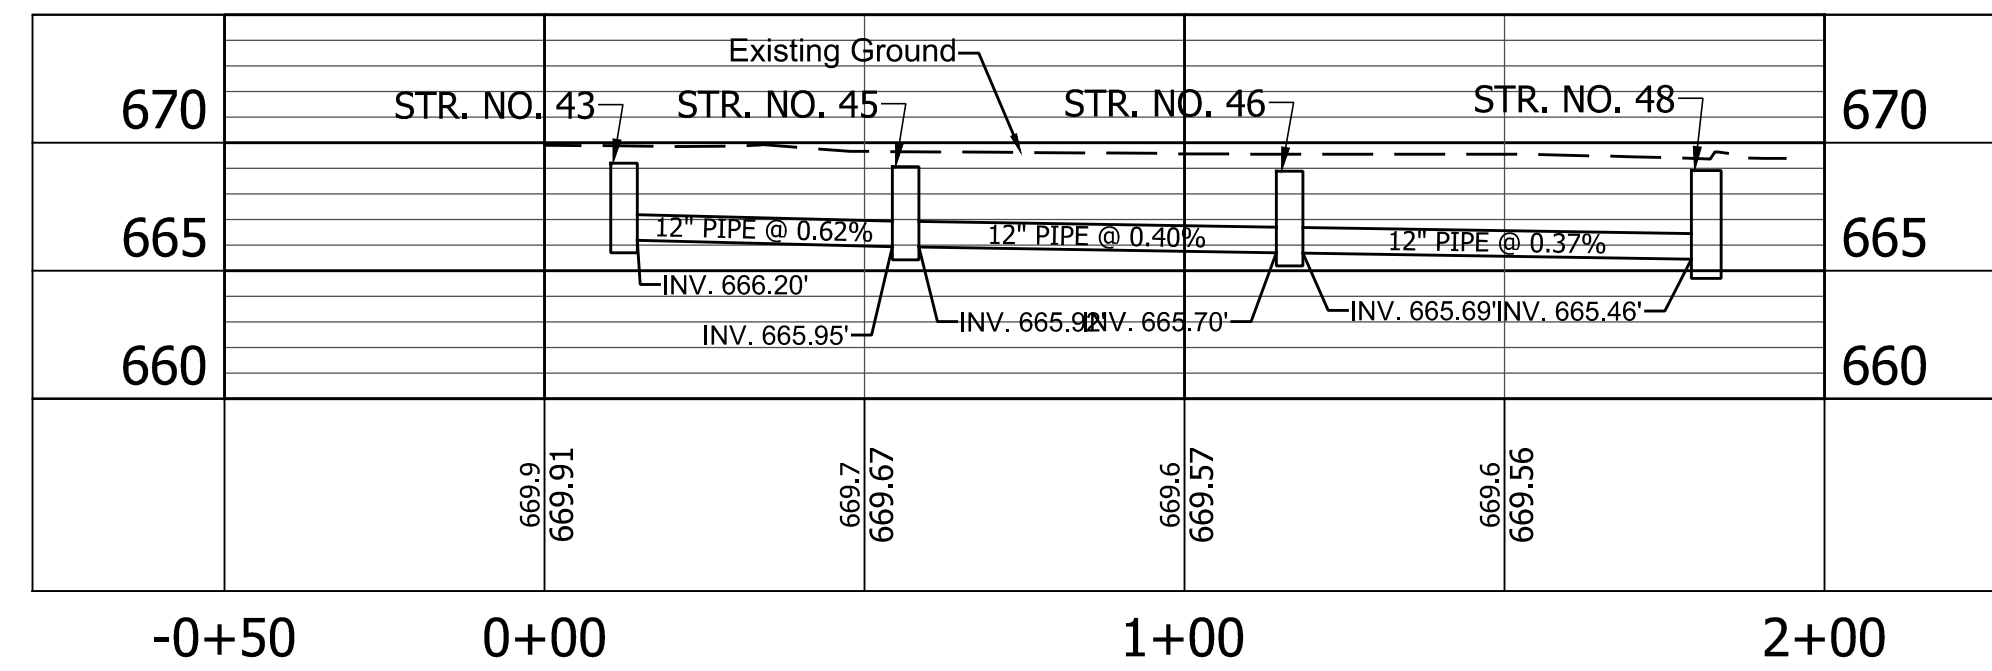


LINE "B" STR. 44 - STR. 49

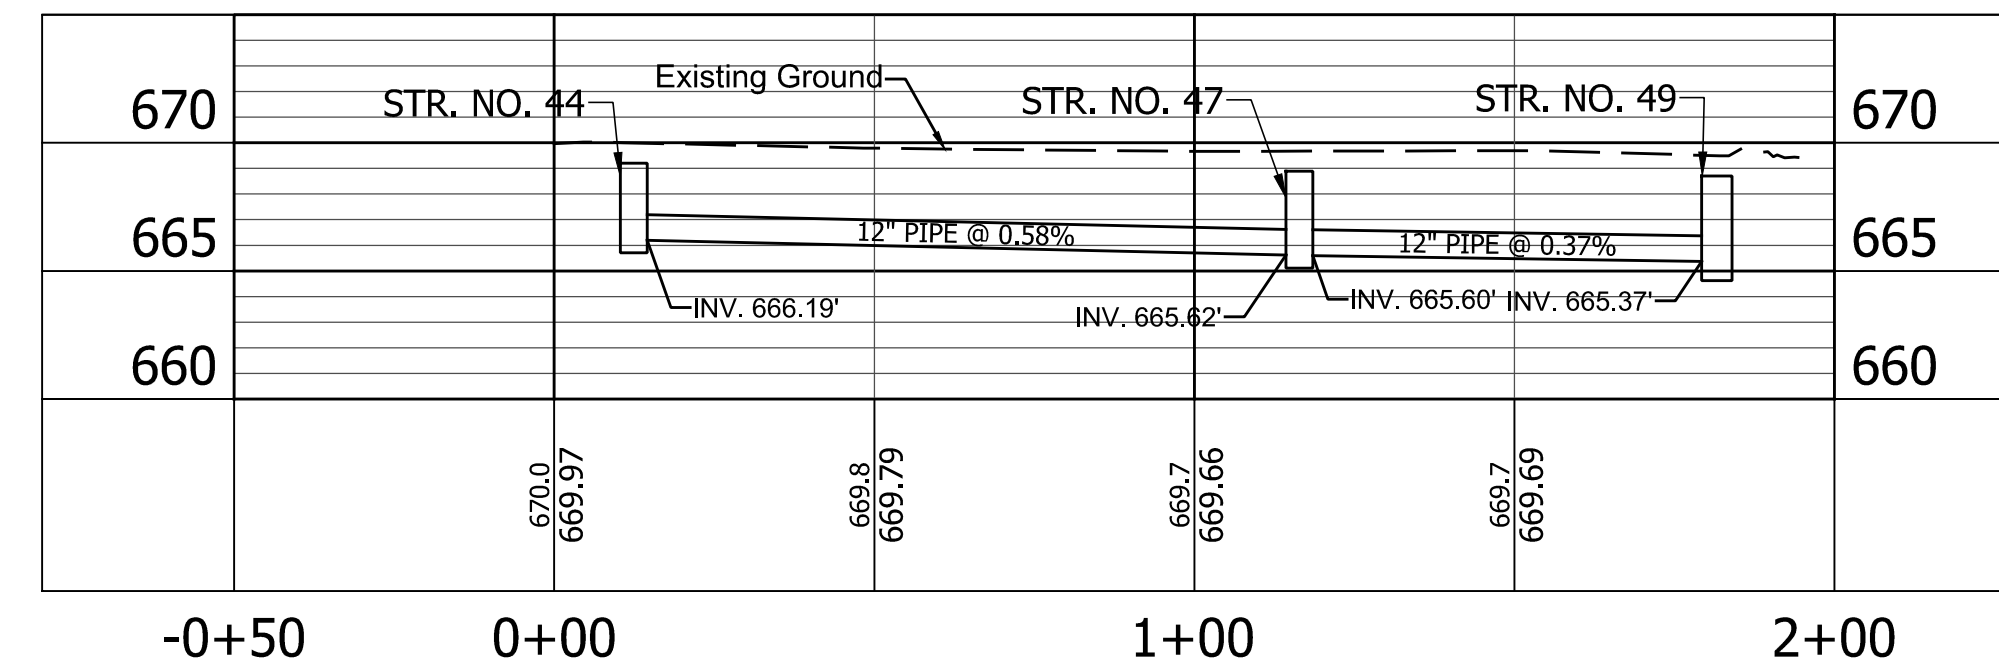

LINE "B" STR. 48B - STR. 49

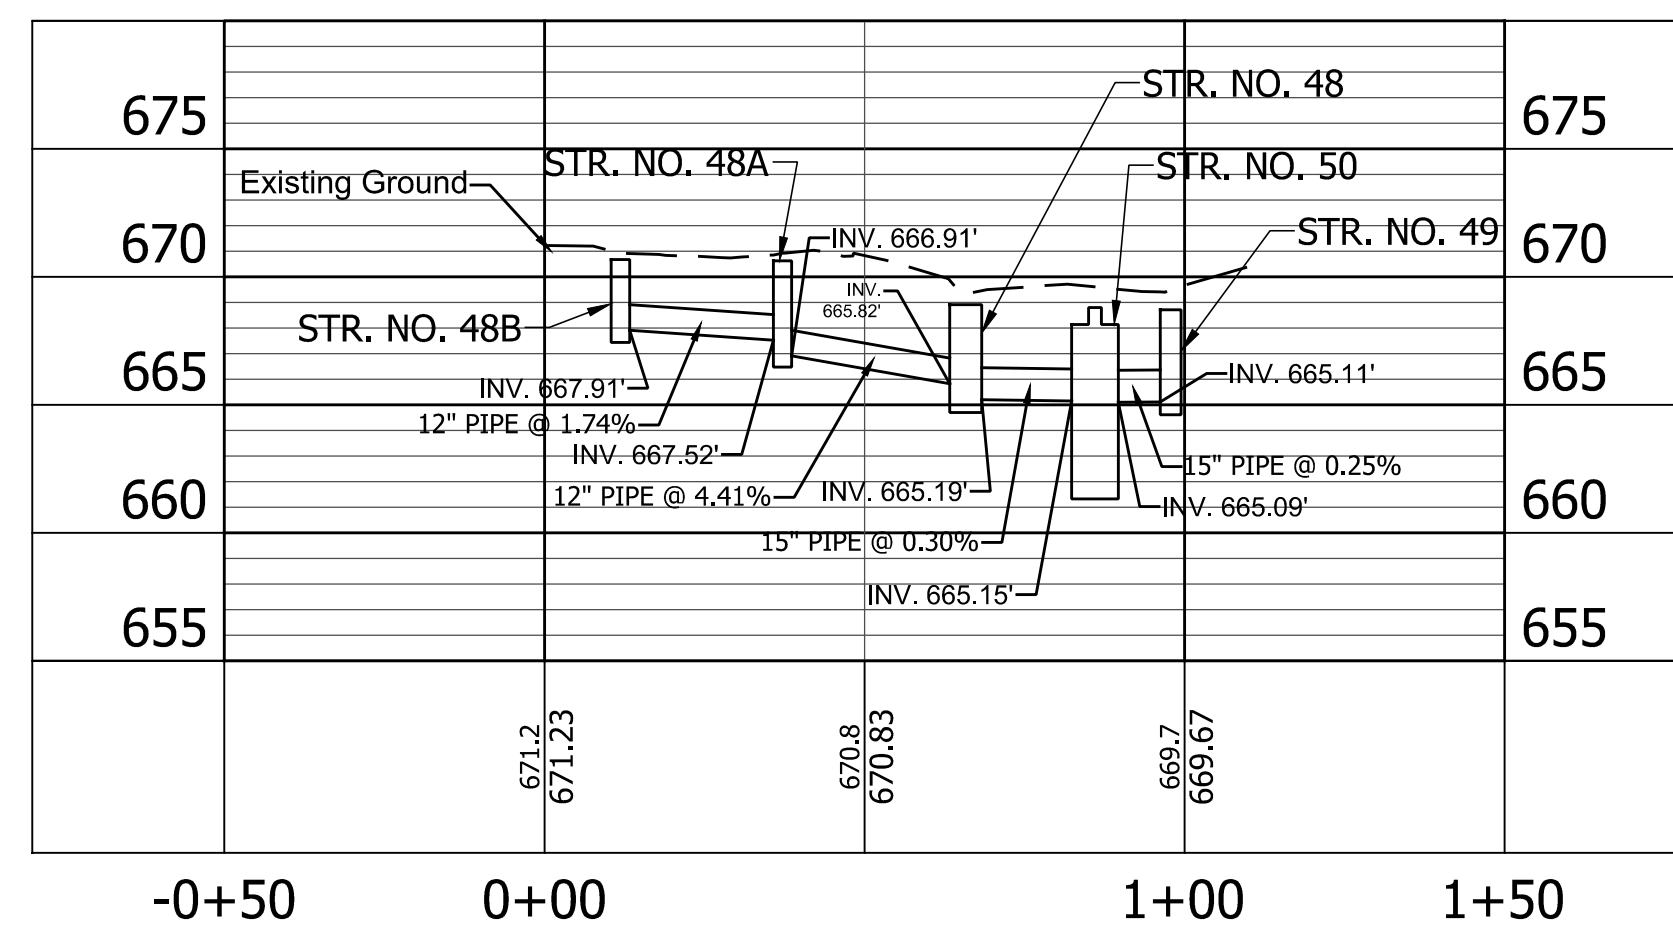

LINE "B" STR. 51 - STR. 56

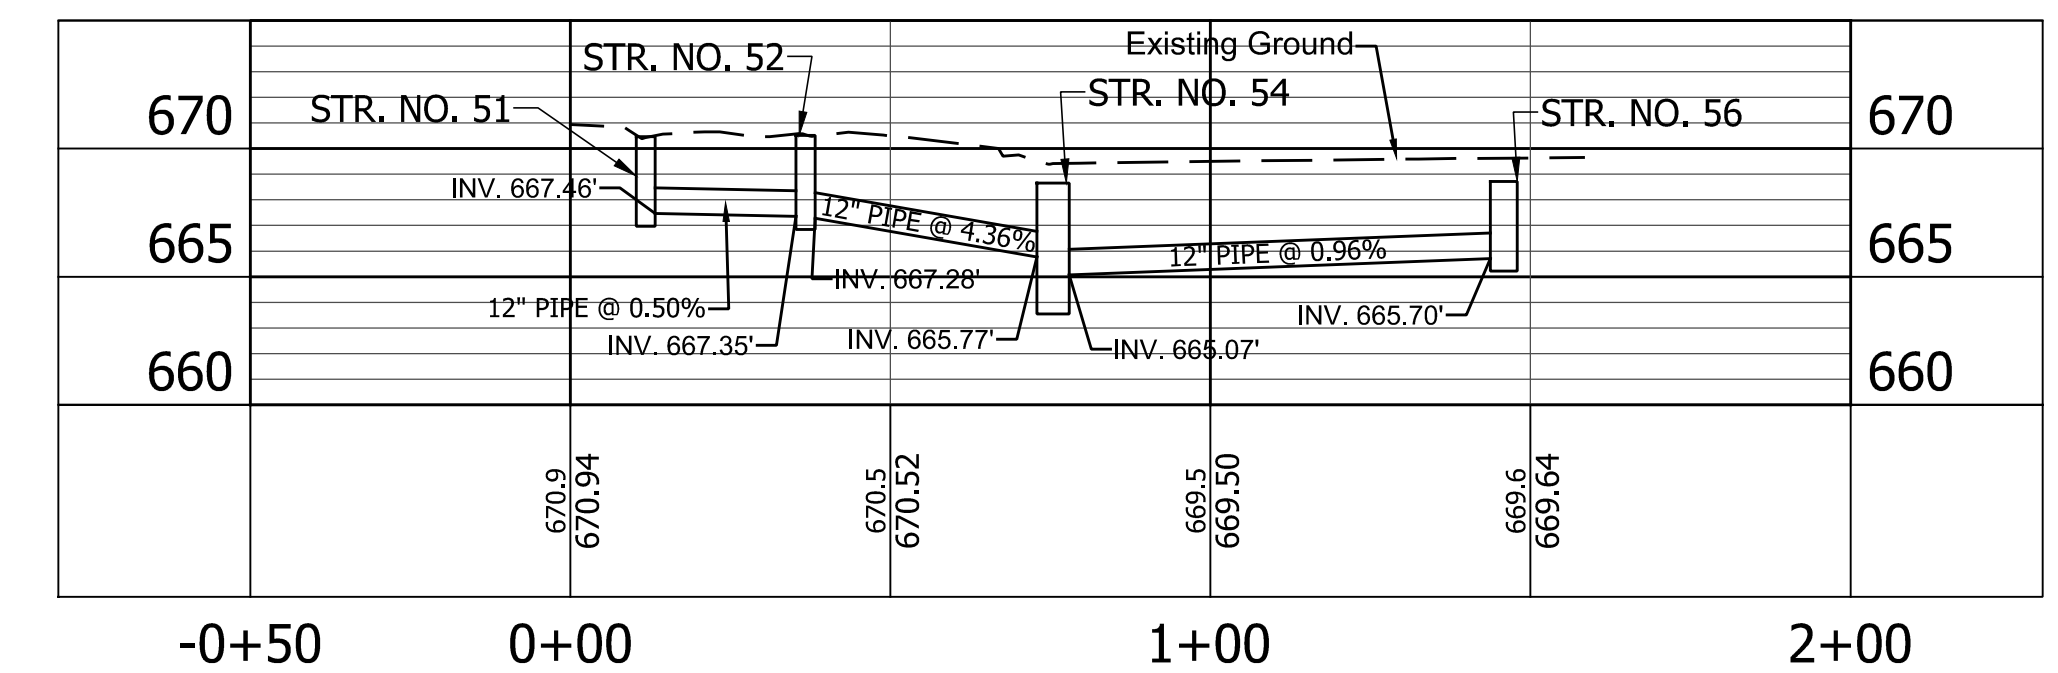


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 PLOT SCALE: 1:1  
 EDIT DATE: 2/22/23 - 11:34 AM  
 EDITED BY: EKOWALSKI  
 DRAWING FILE: P:\21-500-155-1 WHITE CO PAVEMENT REPLACEMENT 21010815 ACAD\06 PLAN PROF\RD\_STORM PROFILE SHEET\_A-B\_20\_01.DWG

RECOMMENDED FOR APPROVAL		DESIGN ENGINEER	DATE
DESIGNED: <u>BLW</u>	DRAWN: <u>EJK</u>		
CHECKED: <u>DCK</u>	CHECKED: <u>DCK</u>		


INDIANA  
 DEPARTMENT OF TRANSPORTATION  
  
 STORM SEWER  
 LINE "B" STORM PROFILES

HORIZONTAL SCALE	BRIDGE FILE
1" = 20'	N/A
VERTICAL SCALE	DESIGNATION
1" = 5'	2001828
SURVEY BOOK	SHEET
	28 of 117
CONTRACT	PROJECT
R-43449	2001828


LINE "B" STR. 54 - STR. 58

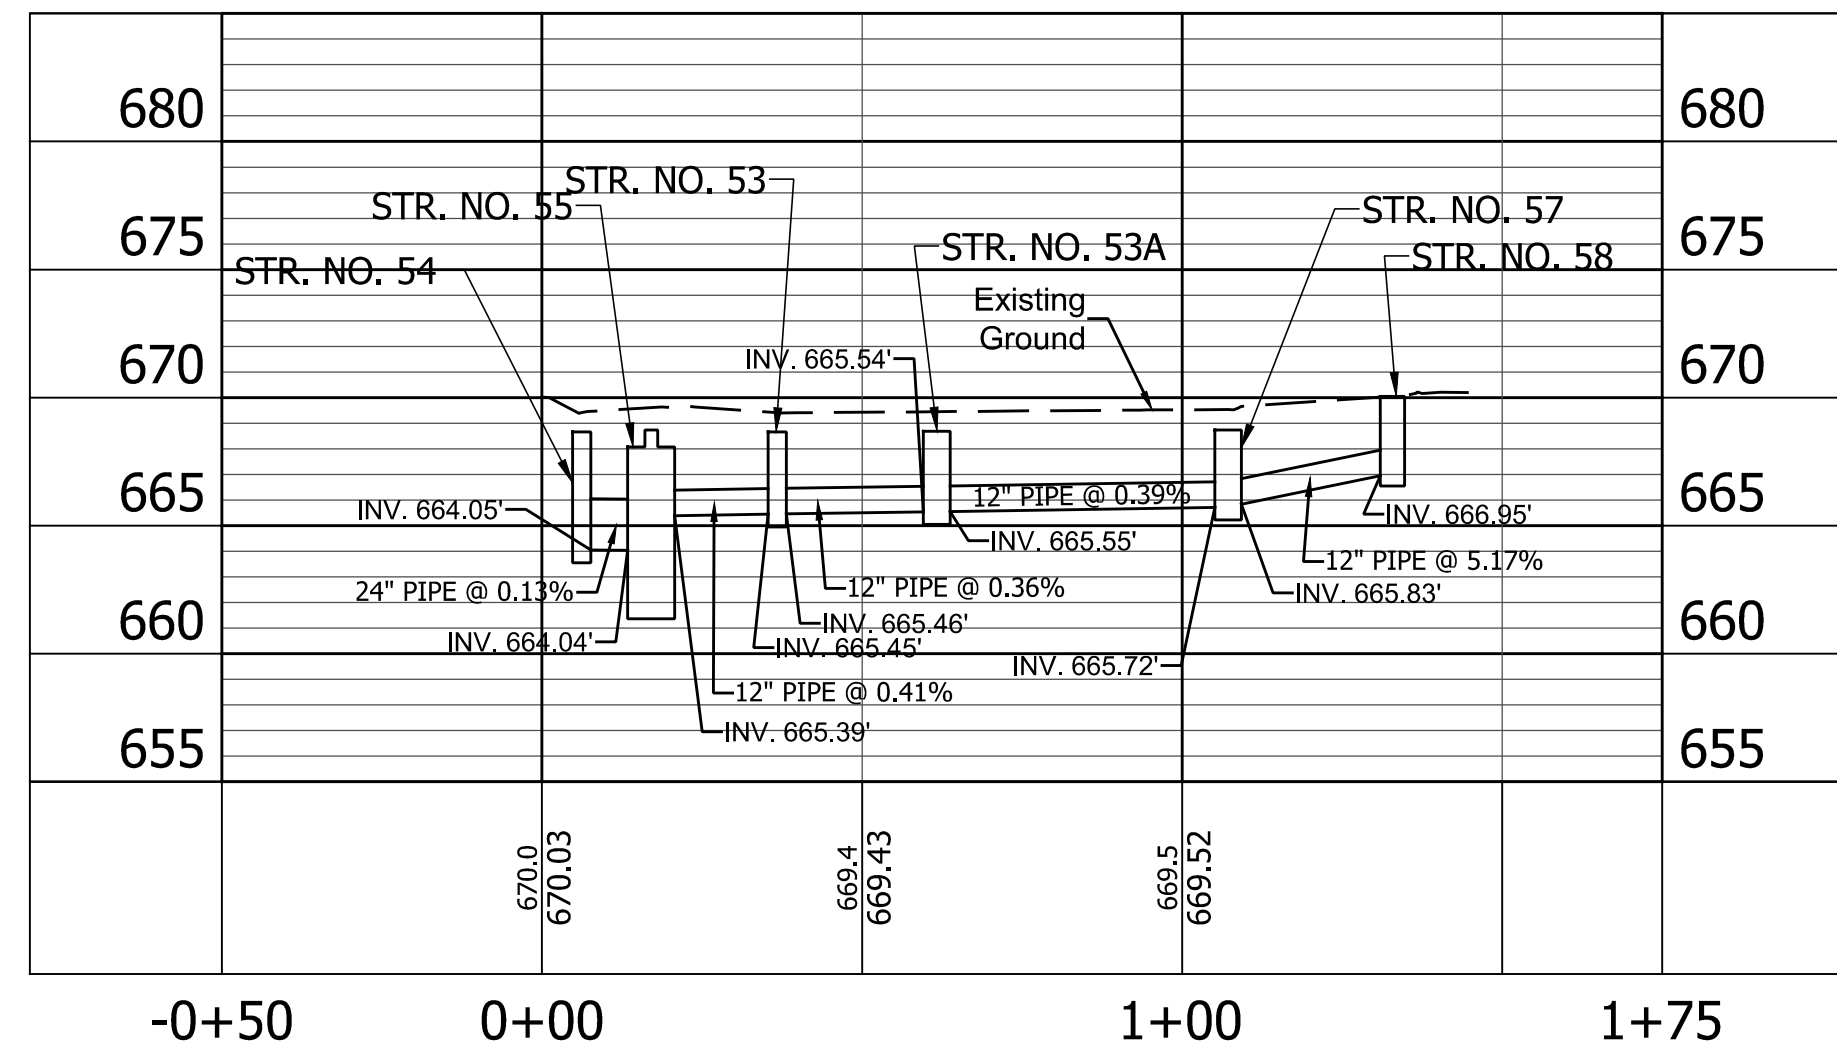


LINE "B" STR. 64 - STR. 61

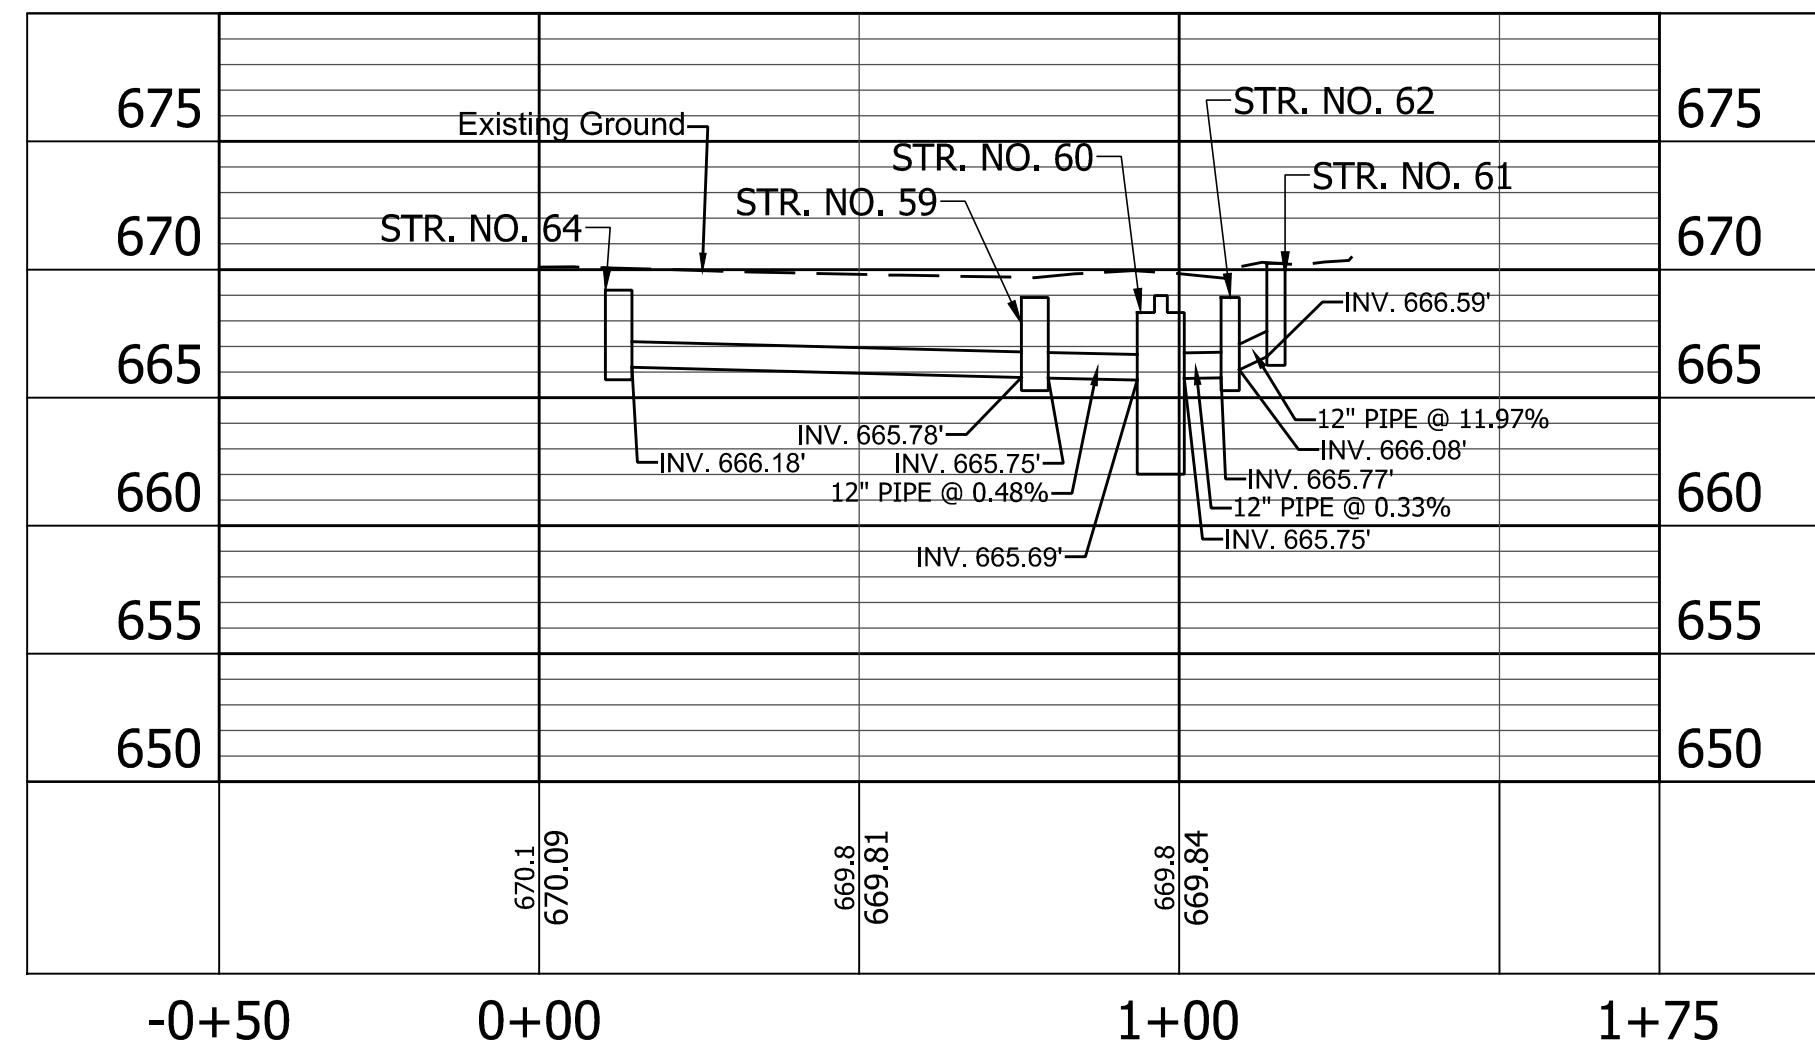


LINE "B" STR. 62 - STR. 65

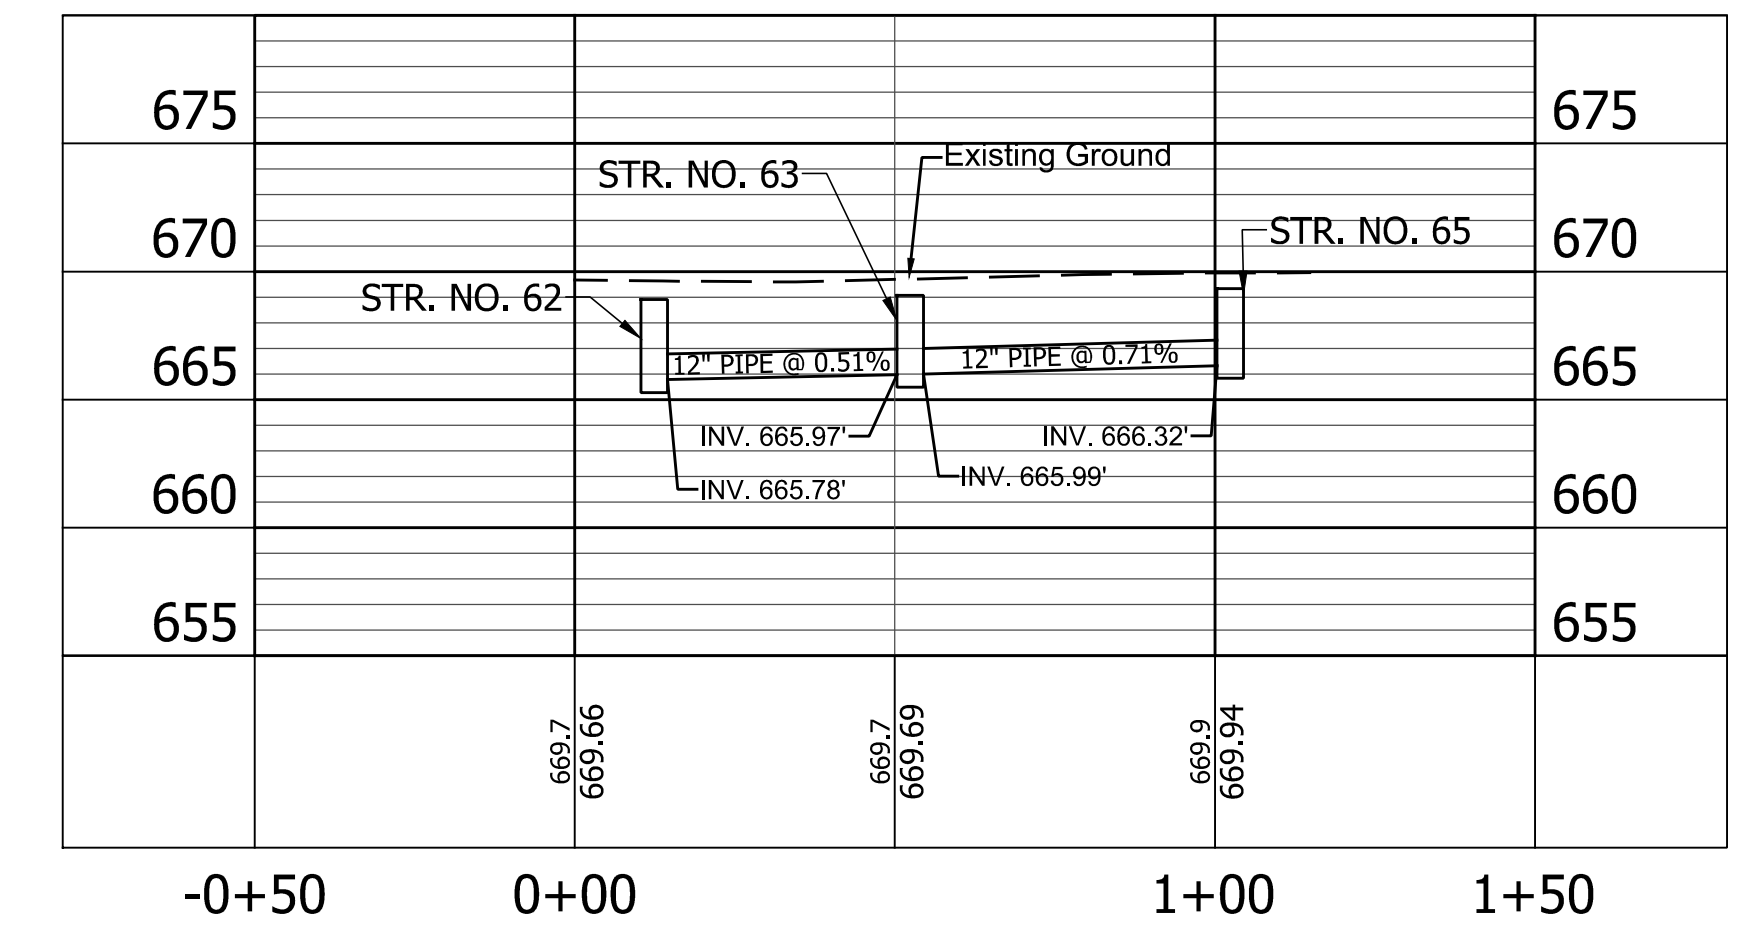


LINE "B" STR. 67 - STR. 70

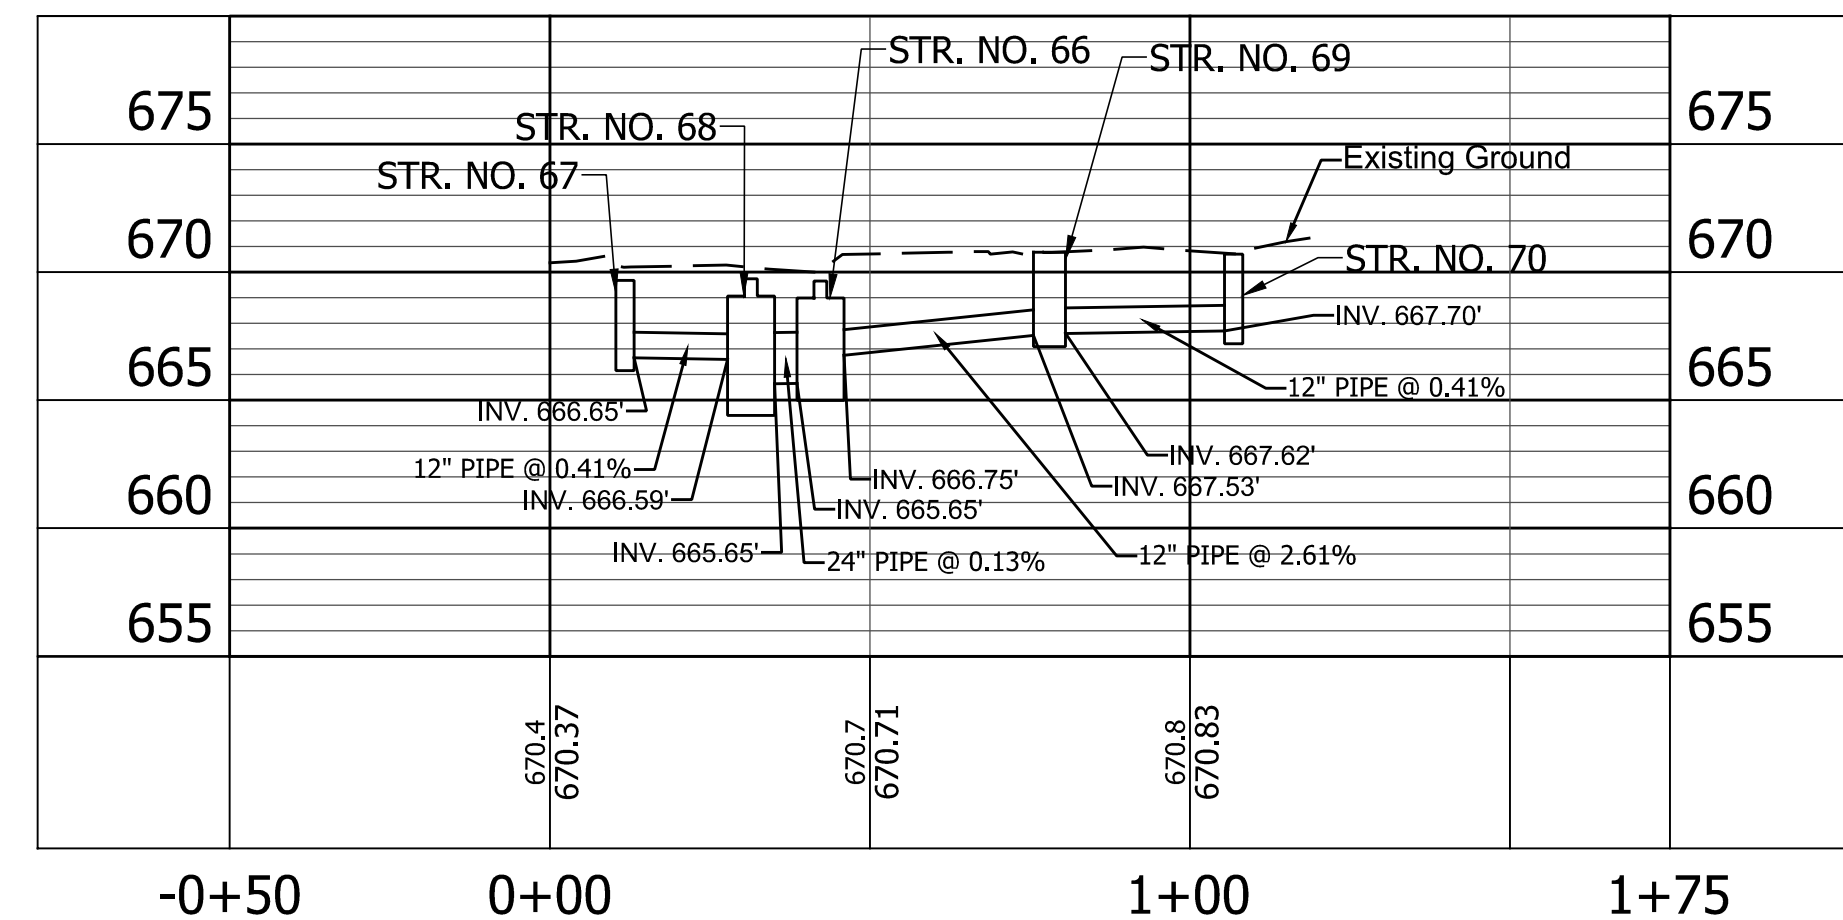


LINE "B" STR. 66 - STR. 73

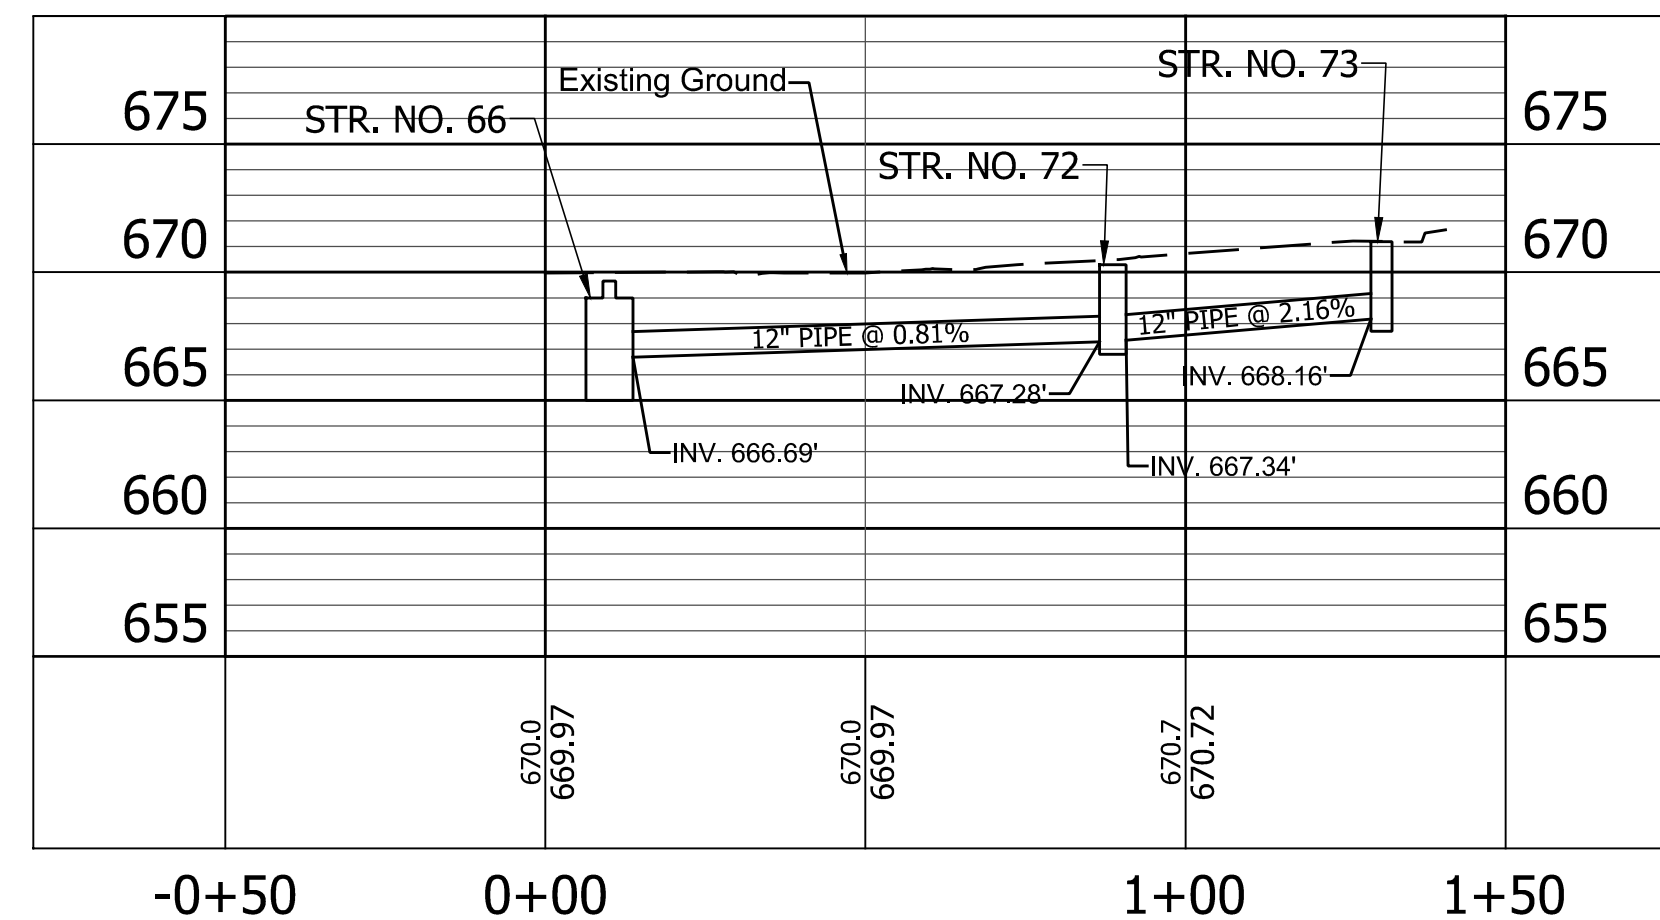


LINE "B" STR. 67 - STR. 74

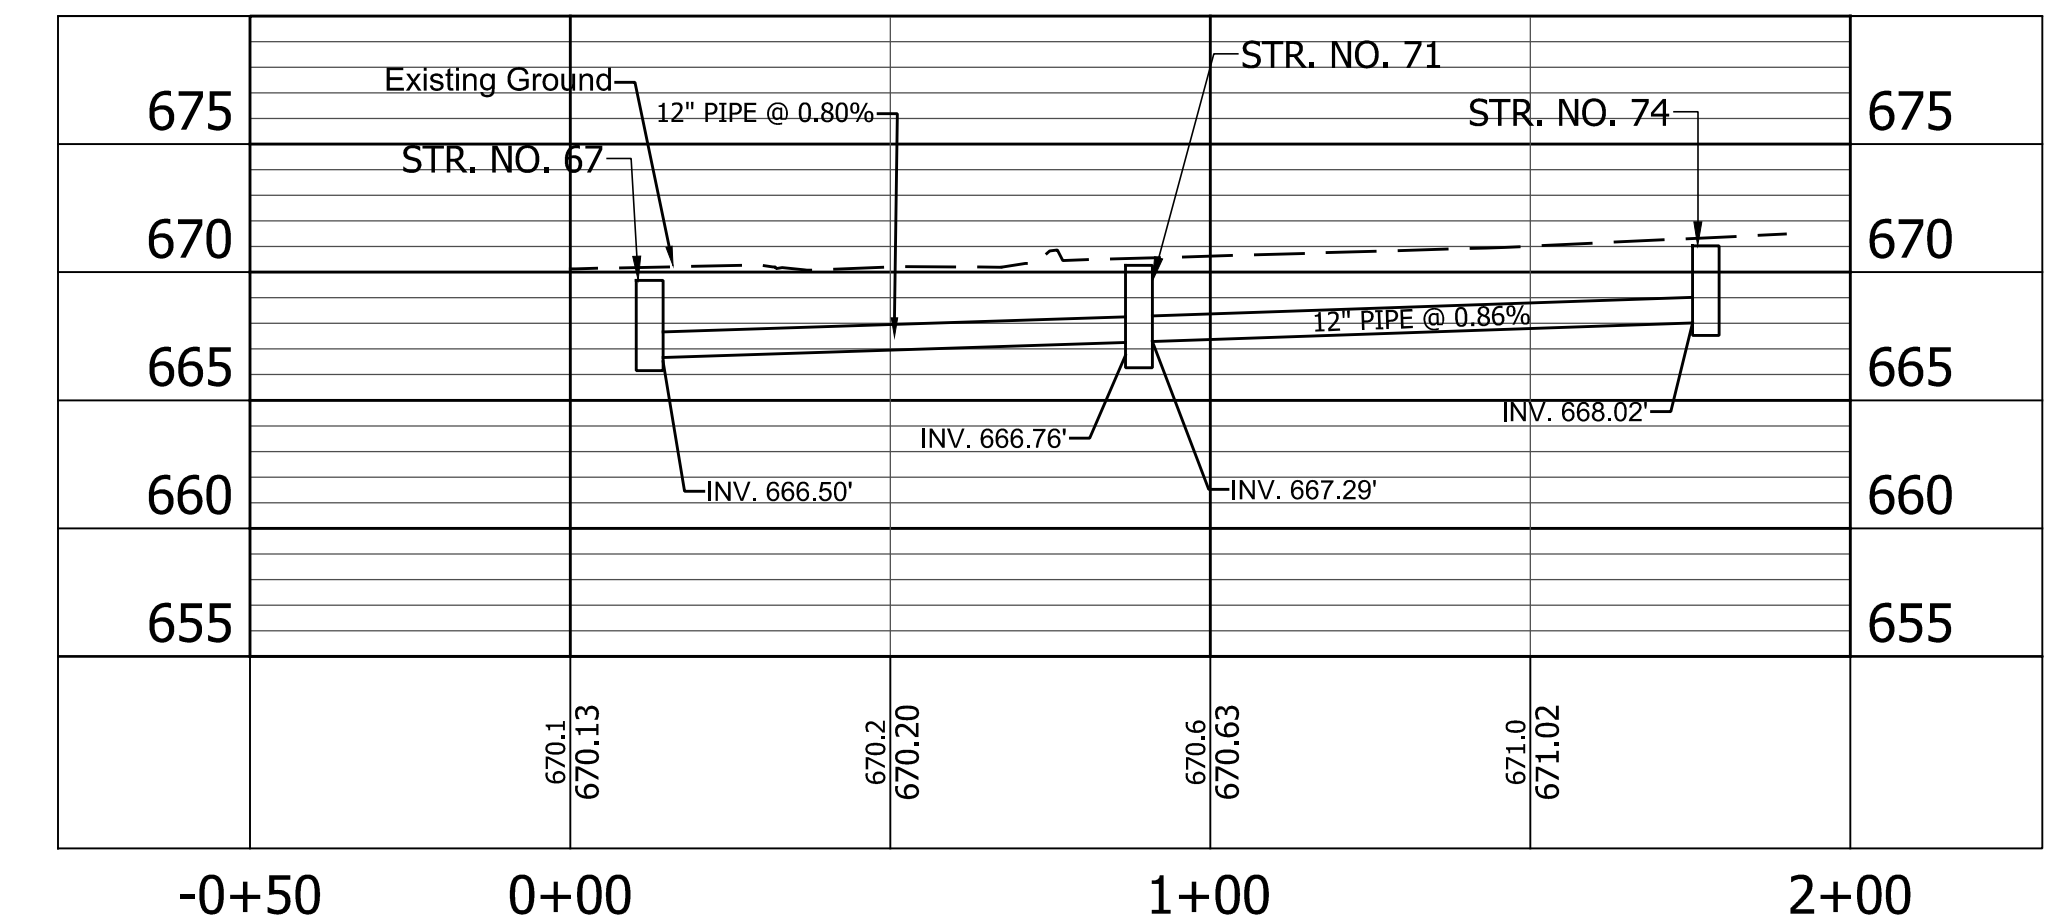


LINE "B" STR. 75 - STR. 77

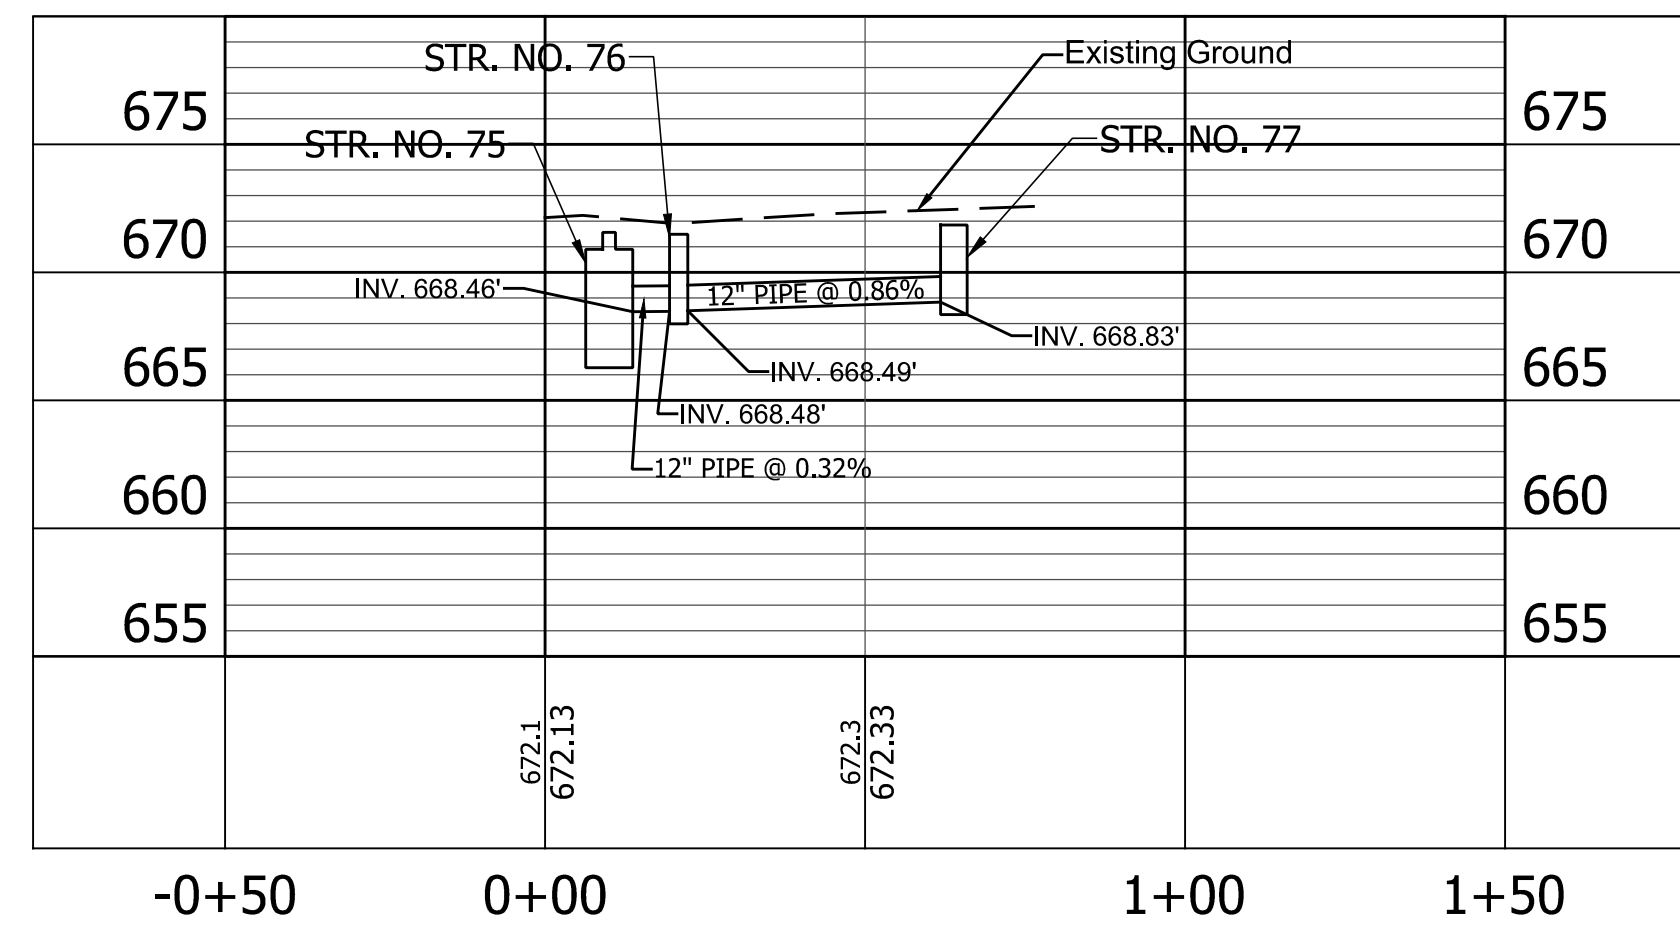

LINE "B" STR. 78 - STR. 79

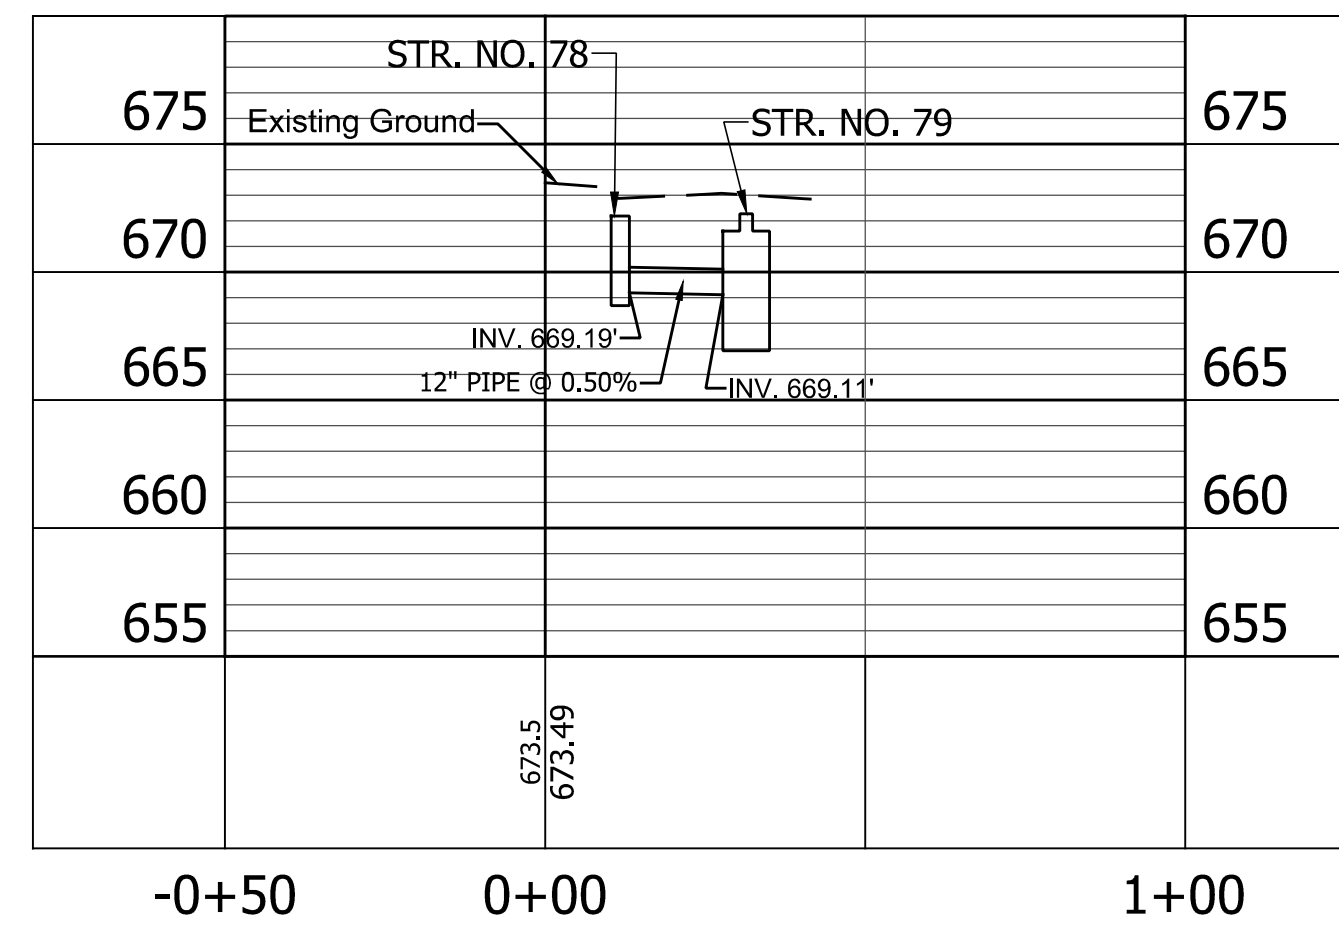

LINE "B" STR. 81 - STR. 80

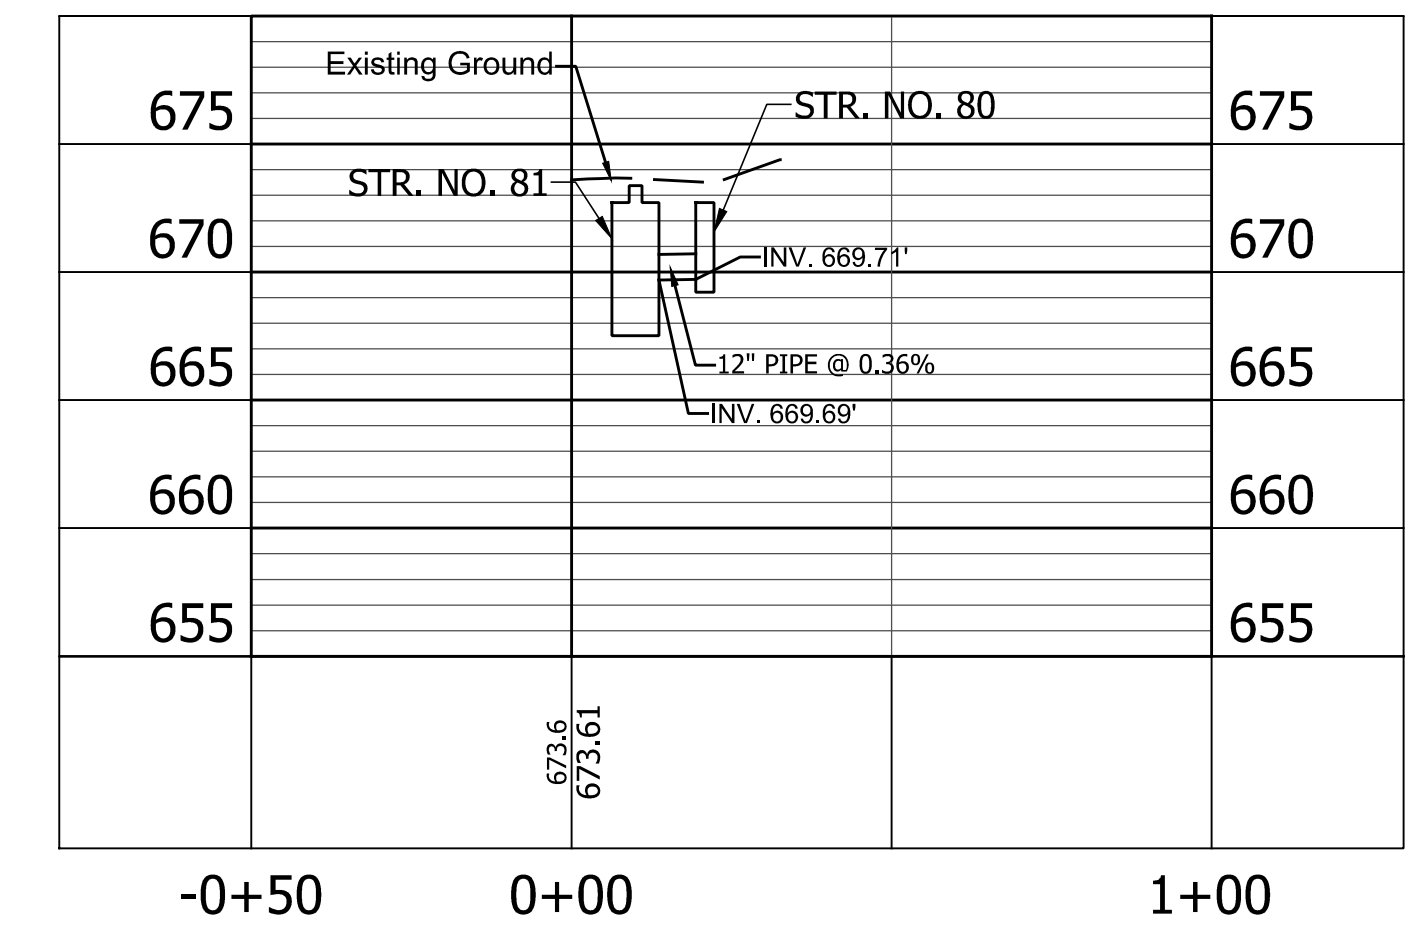

PRINT DATE: 4/5/23 PLOT SCALE: 1:1 EDIT DATE: 4/5/23 1:28 PM EDITED BY: EKOWALSKI DRAWING FILE: P:\21-500-155-1 WHITE CO PAVEMENT REPLACEMENT 21010815 ACAD\06 PLAN PROF\RD\_STORM PROFILE SHEET\_A-B\_20\_01.DWG


RECOMMENDED FOR APPROVAL		DESIGN ENGINEER	DATE
DESIGNED: <u>BLW</u>	DRAWN: <u>EJK</u>		
CHECKED: <u>DCK</u>	CHECKED: <u>DCK</u>		

INDIANA DEPARTMENT OF TRANSPORTATION


STORM SEWER LINE "B" STORM PROFILES

HORIZONTAL SCALE	BRIDGE FILE
1" = 20'	N/A
VERTICAL SCALE	DESIGNATION
1" = 5'	2001828
SURVEY BOOK	SHEET
	29 of 117
CONTRACT	PROJECT
R-43449	2001828


LINE "B" STR. 82 - STR. 84

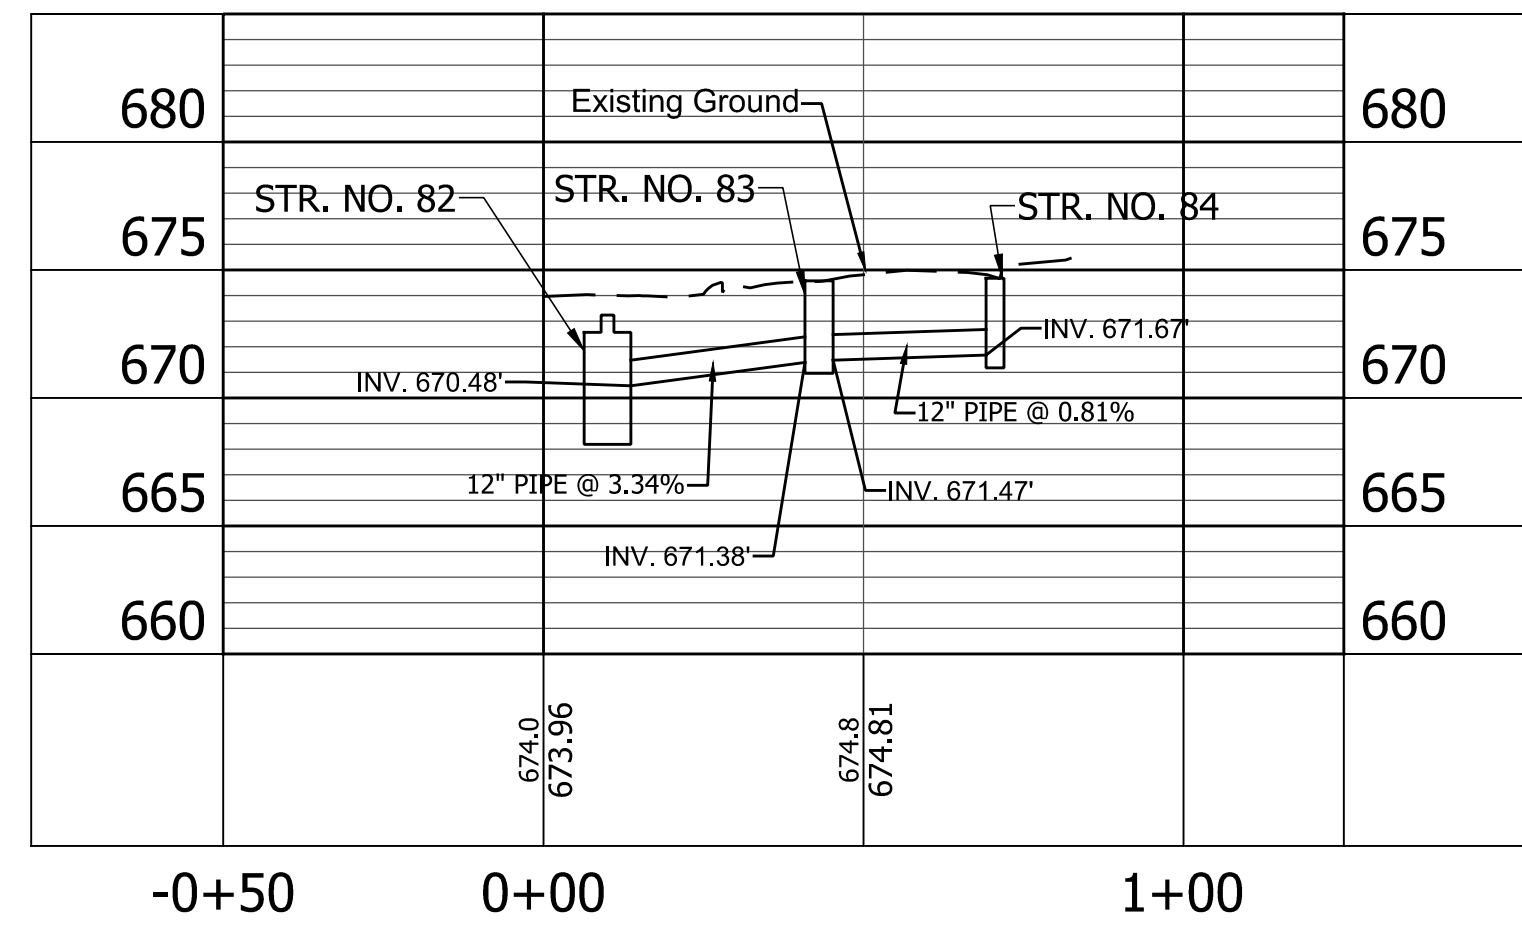


LINE "B" STR. 87 - STR. 88

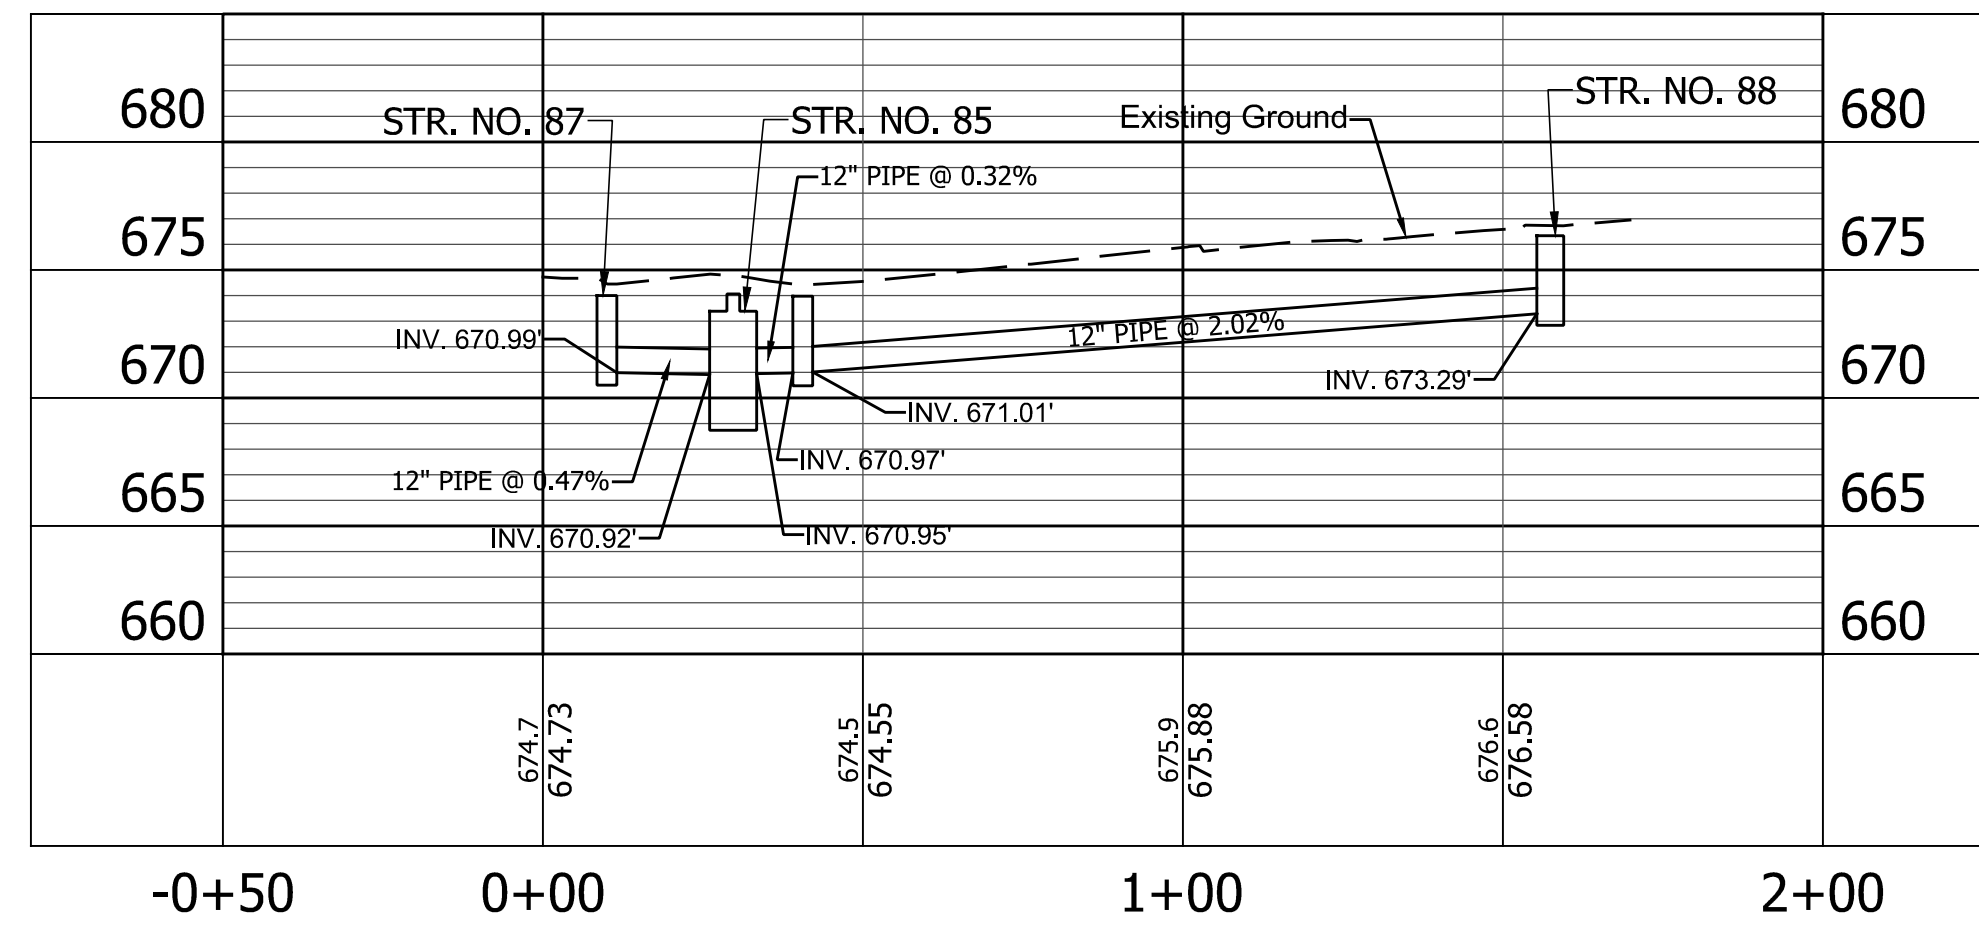


LINE "B" STR. 89 - STR. 92A

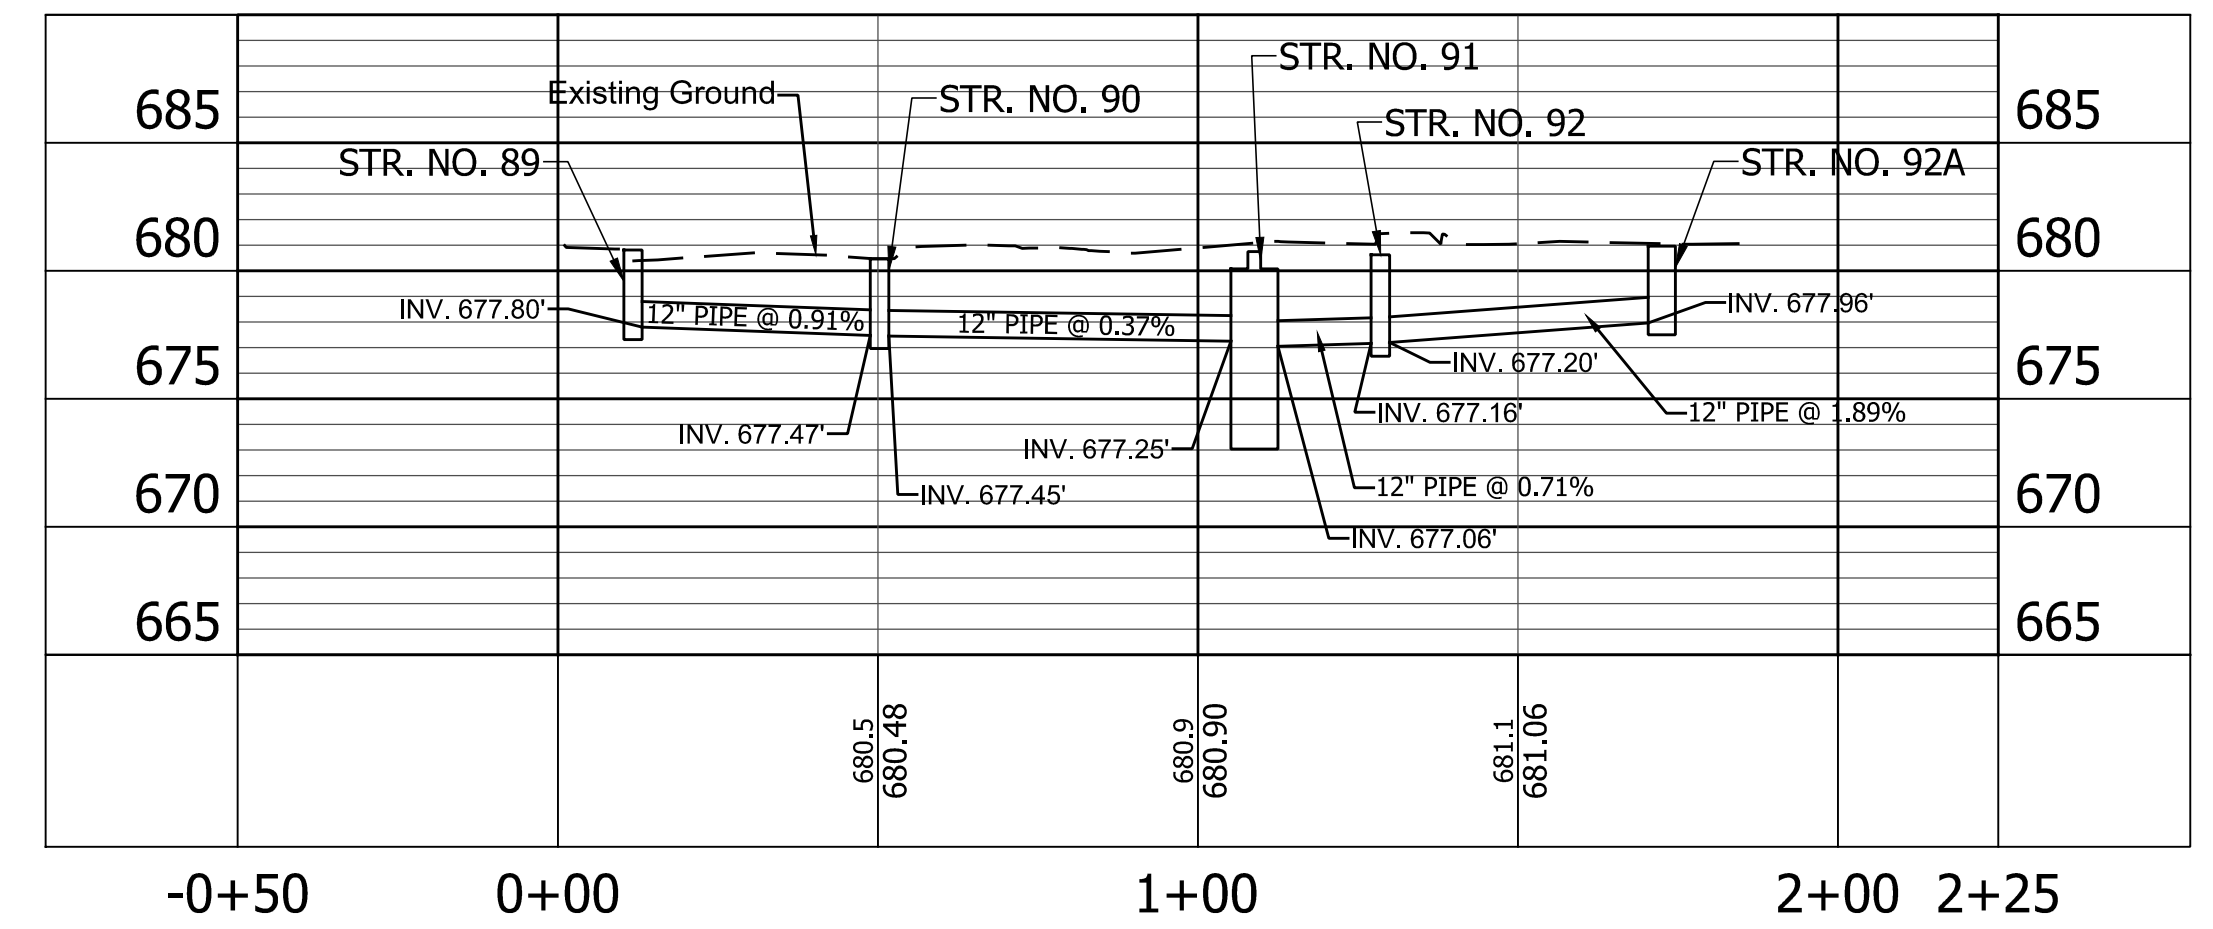


LINE "B" STR. 91 - STR. 93

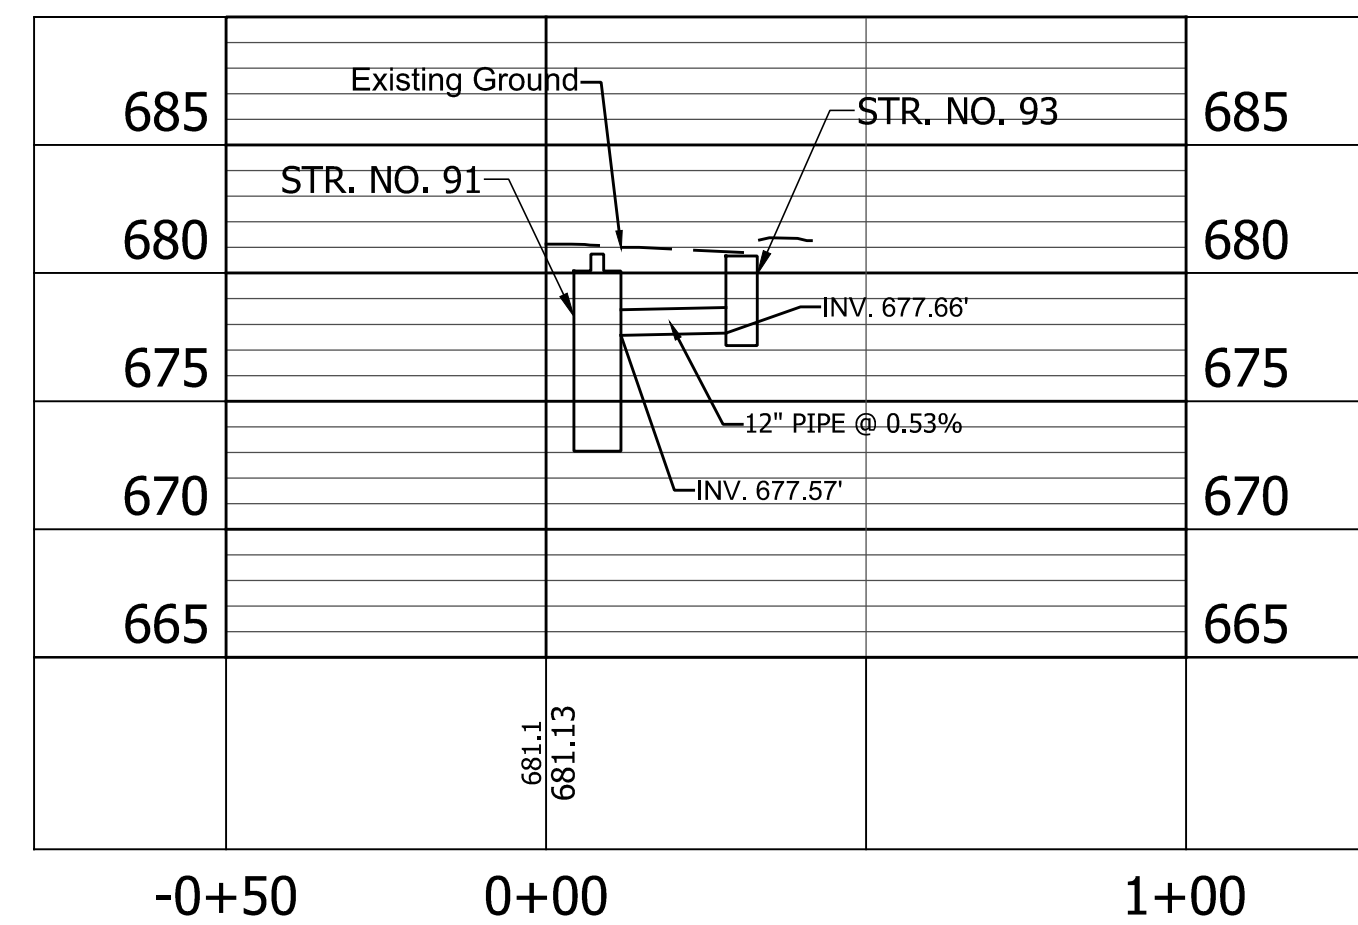


LINE "B" STR. 95 - STR. 94

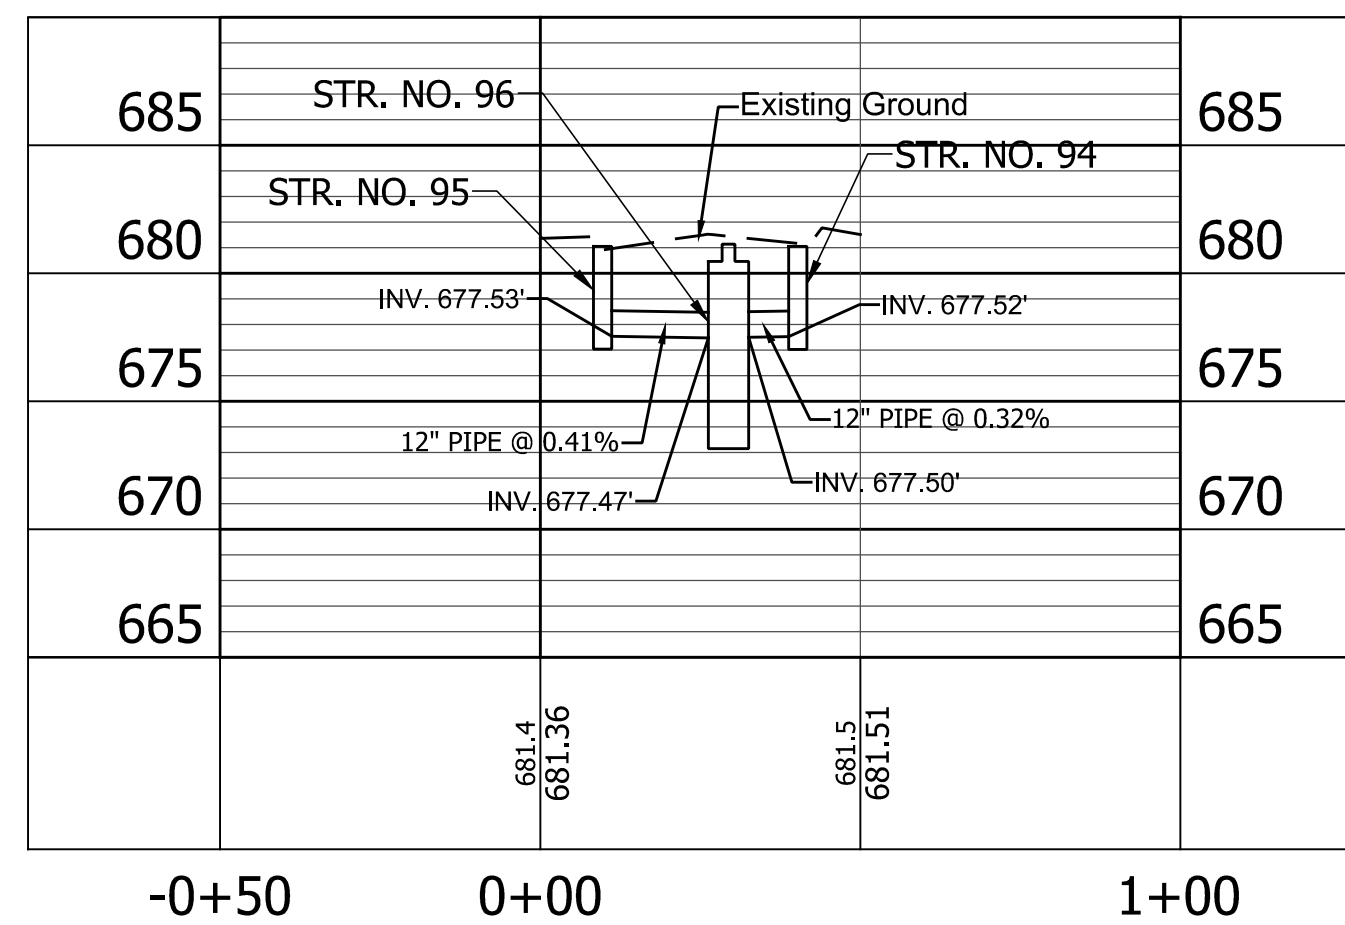


LINE "B" STR. 94 - STR. 104

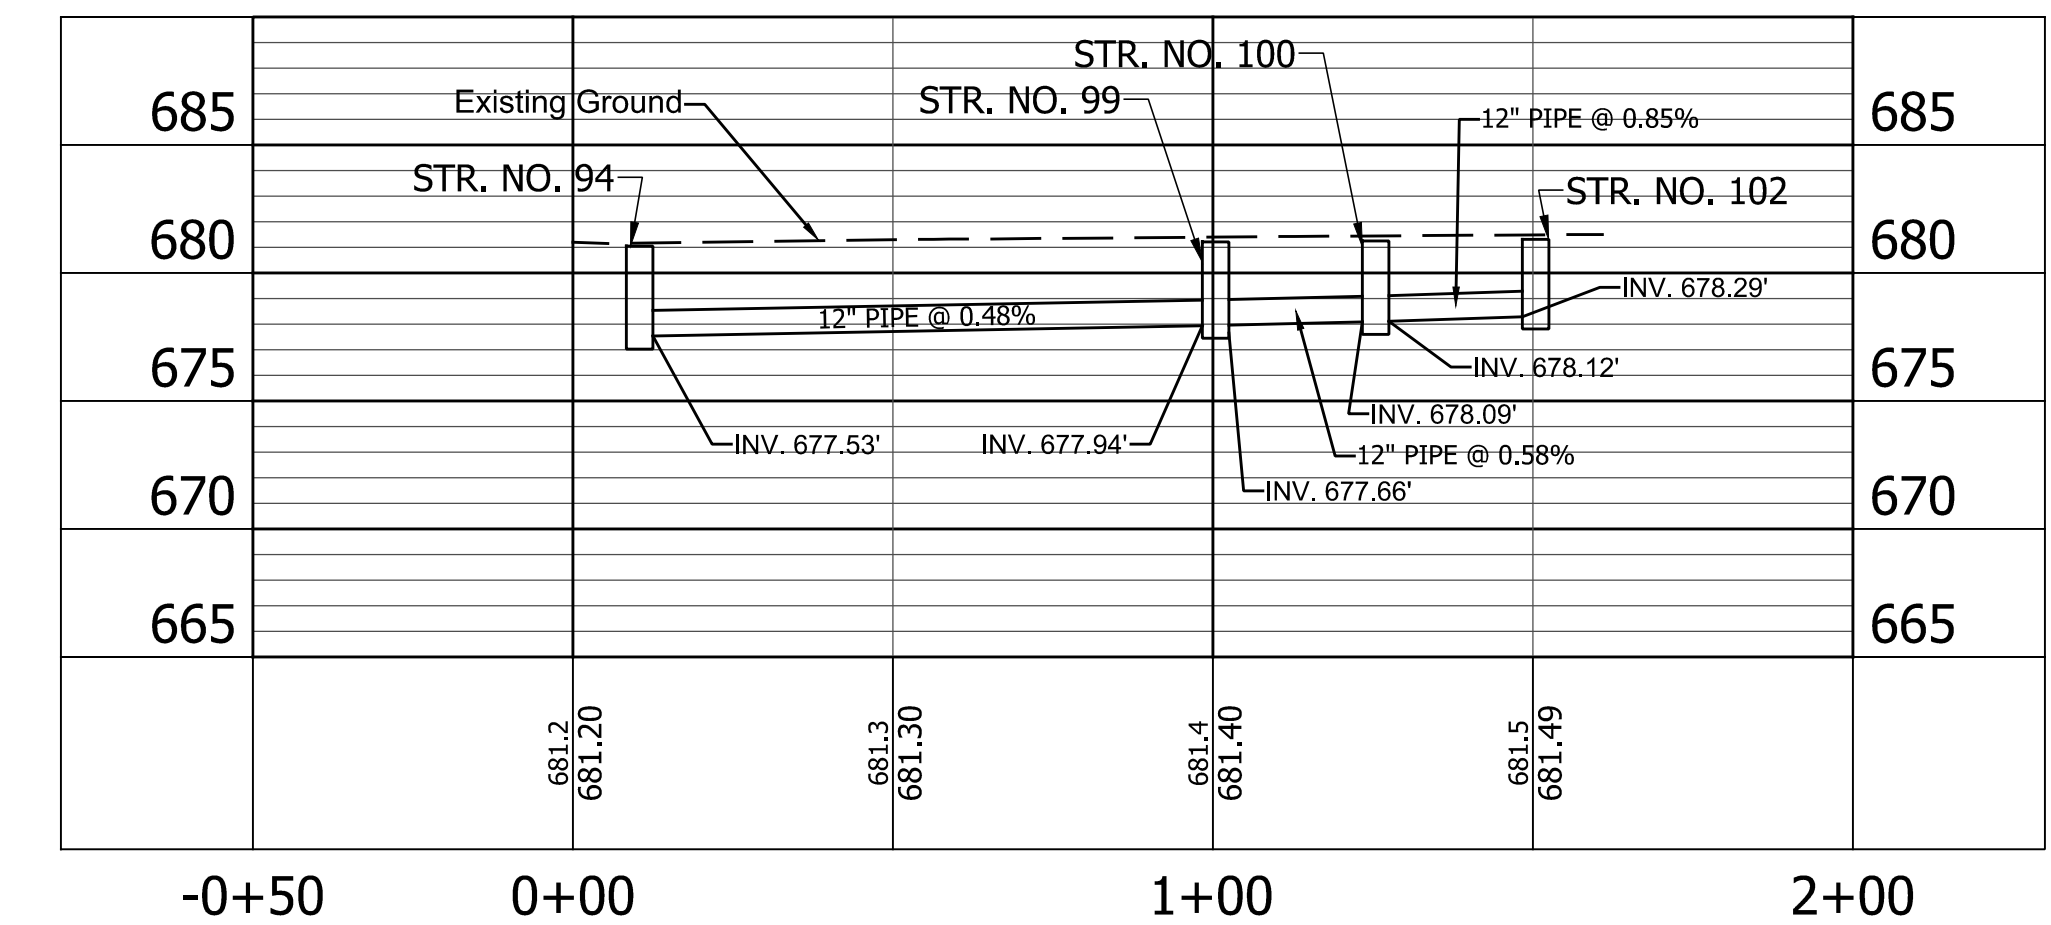


LINE "B" STR. 95 - STR. 103

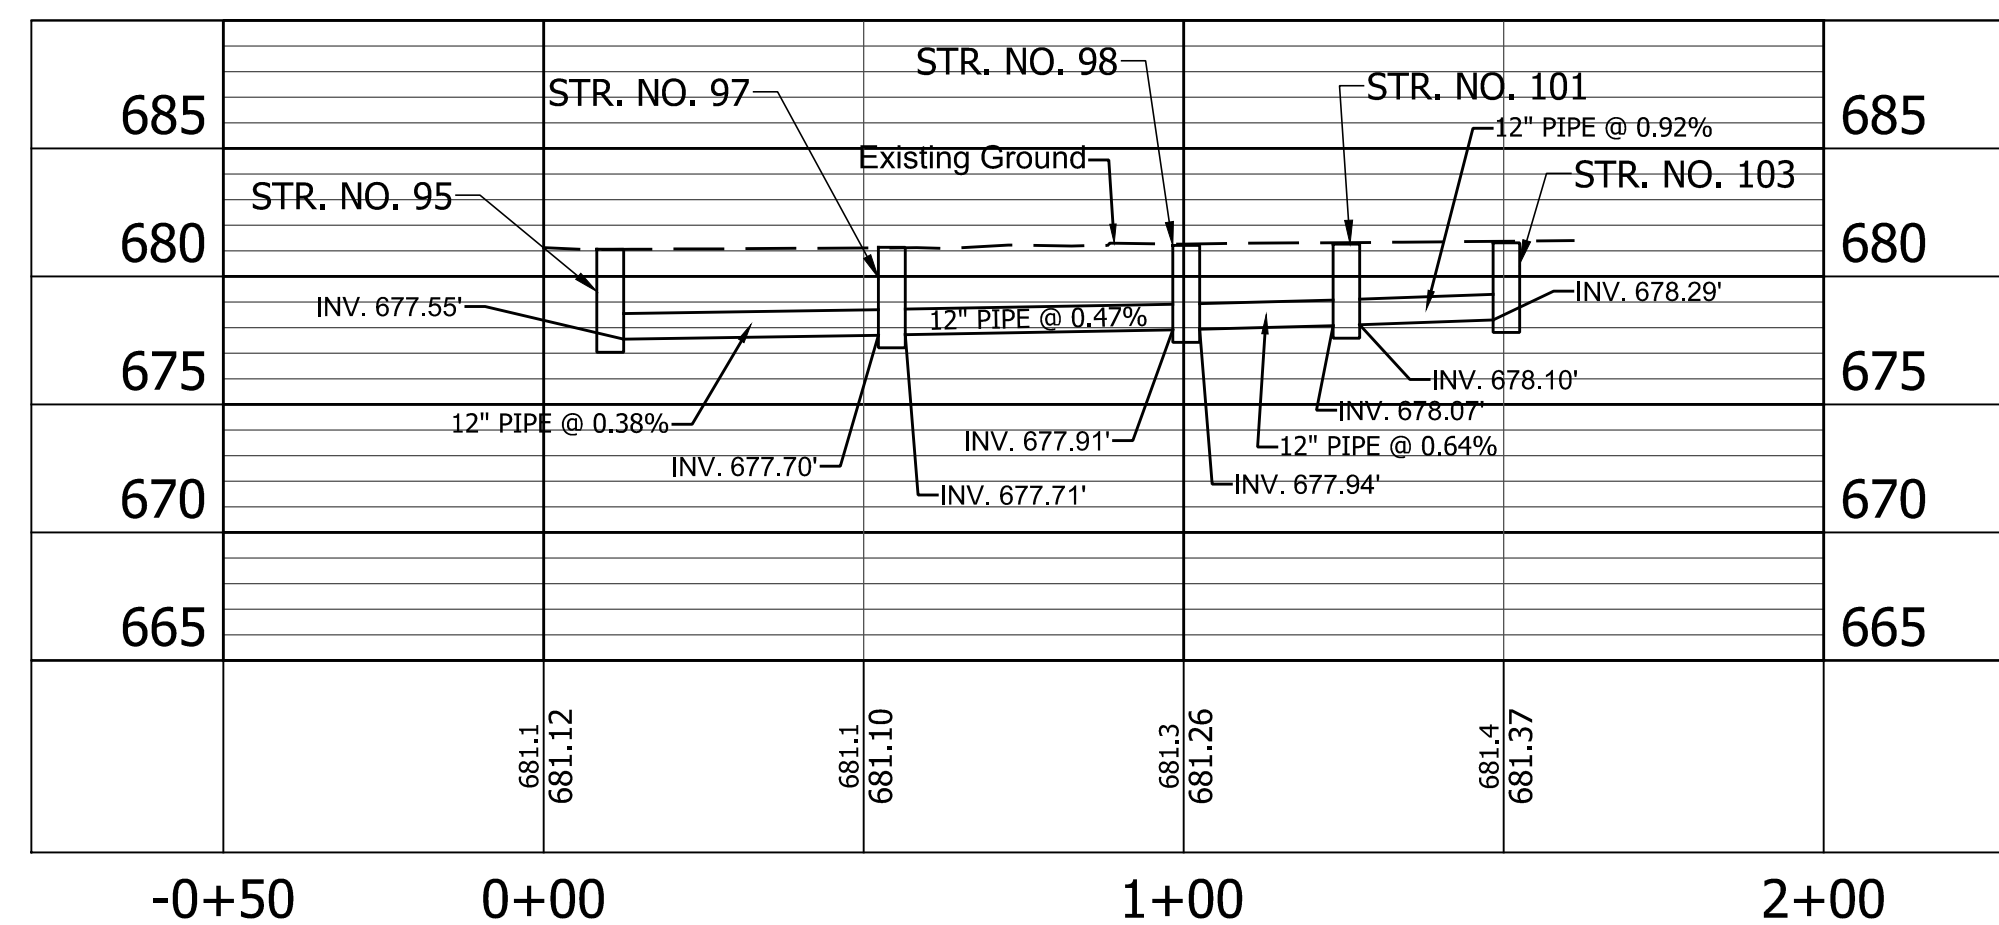

LINE "B" STR. 108 - STR. 104

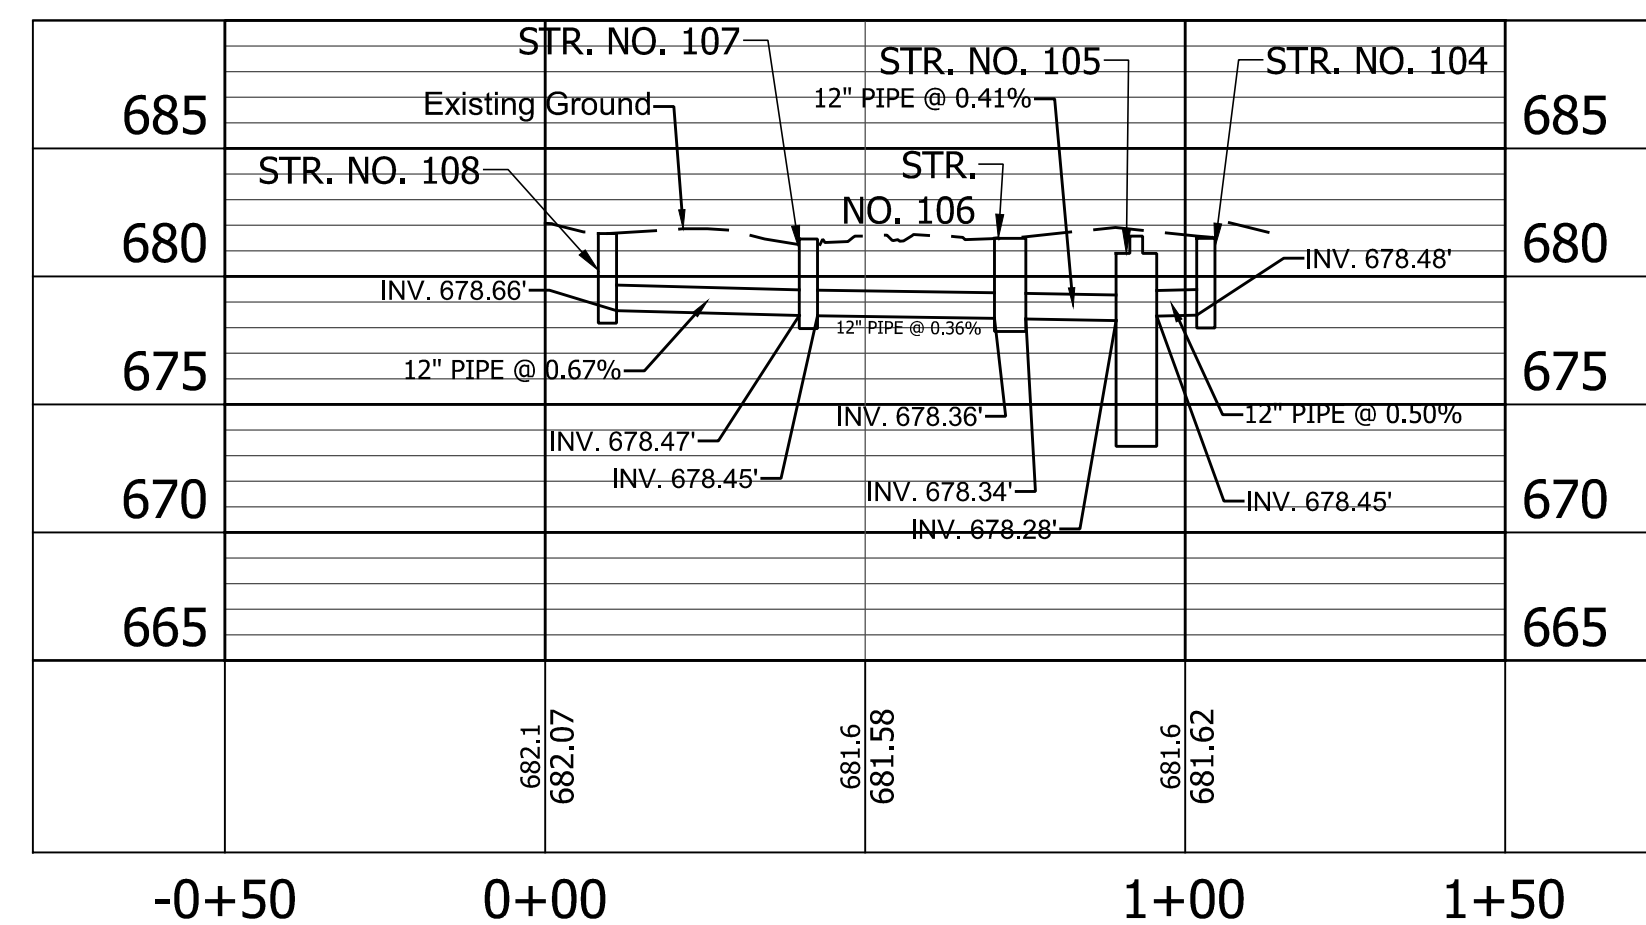

LINE "B" STR. 111 - STR. 109

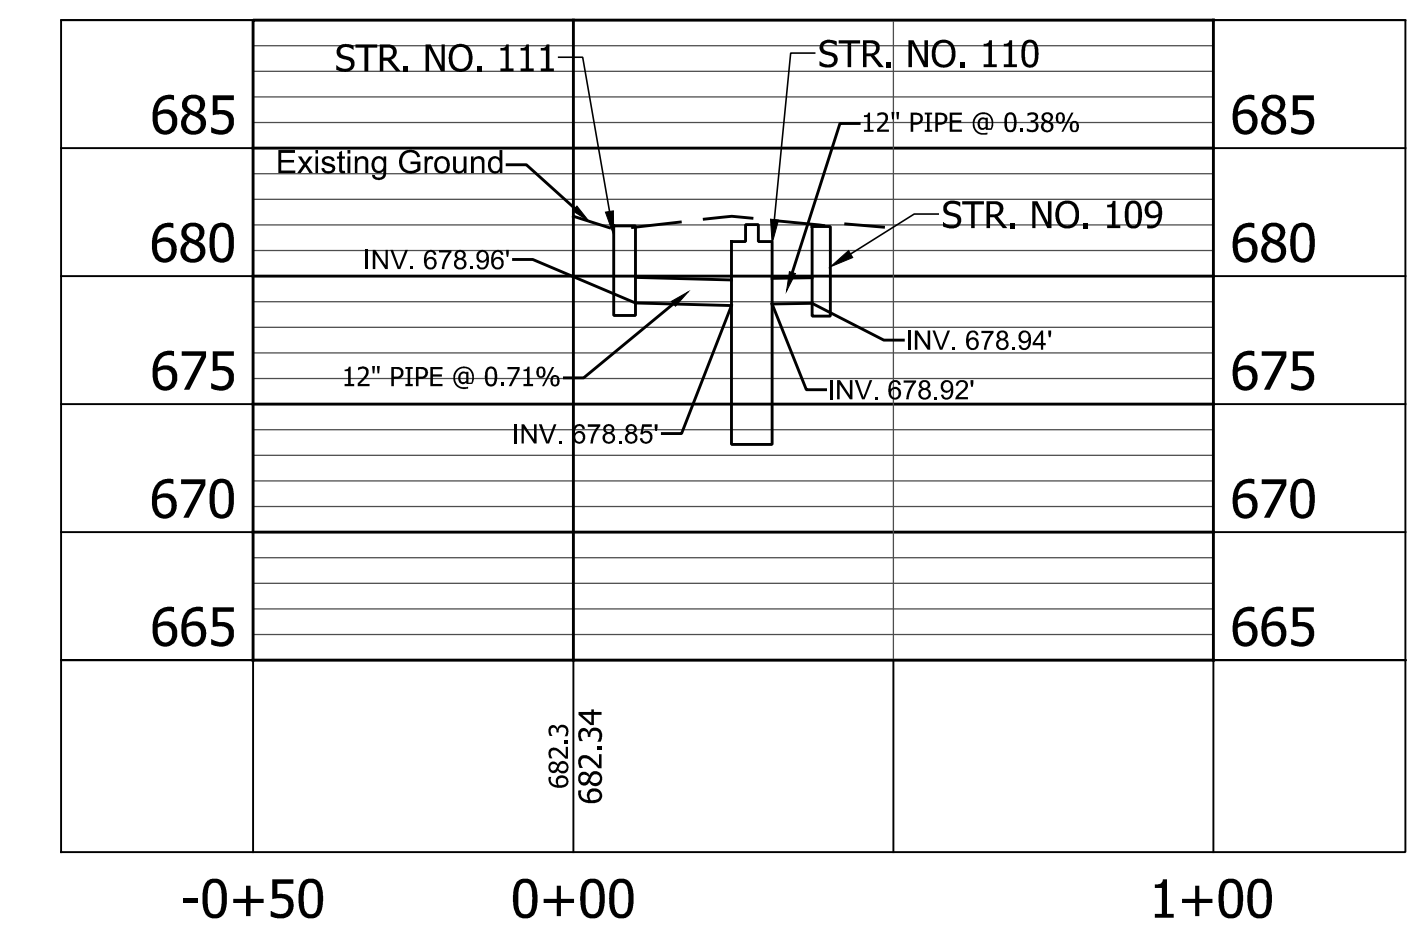

PRINT DATE: 4/5/23  
 PLOT SCALE: 1:1  
 EDIT DATE: 4/5/23 - 1:28 PM  
 EDITED BY: EKOWALSKI  
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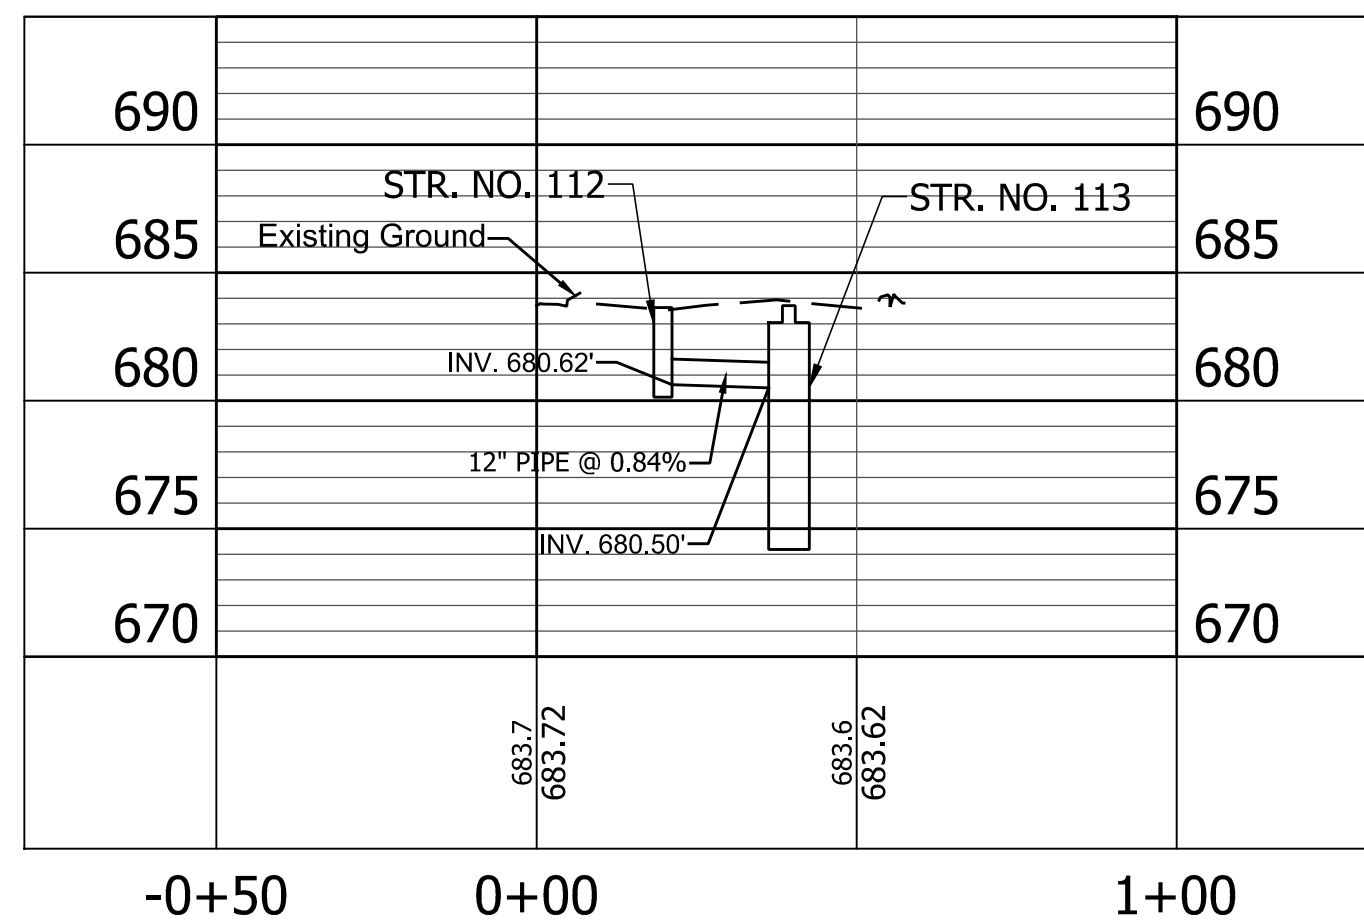
RECOMMENDED FOR APPROVAL		DESIGN ENGINEER		DATE	
DESIGNED: <u>BLW</u>	DRAWN: <u>EJK</u>				
CHECKED: <u>DCK</u>	CHECKED: <u>DCK</u>				

INDIANA  
DEPARTMENT OF TRANSPORTATION


STORM SEWER  
LINE "B" STORM PROFILES

HORIZONTAL SCALE 1" = 20'	BRIDGE FILE N/A
VERTICAL SCALE 1" = 5'	DESIGNATION 2001828
SURVEY BOOK	SHEET
	30 of 117
CONTRACT R-43449	PROJECT 2001828


LINE "B" STR. 112 - STR. 113




LINE "B" STR. 116 - STR. 114

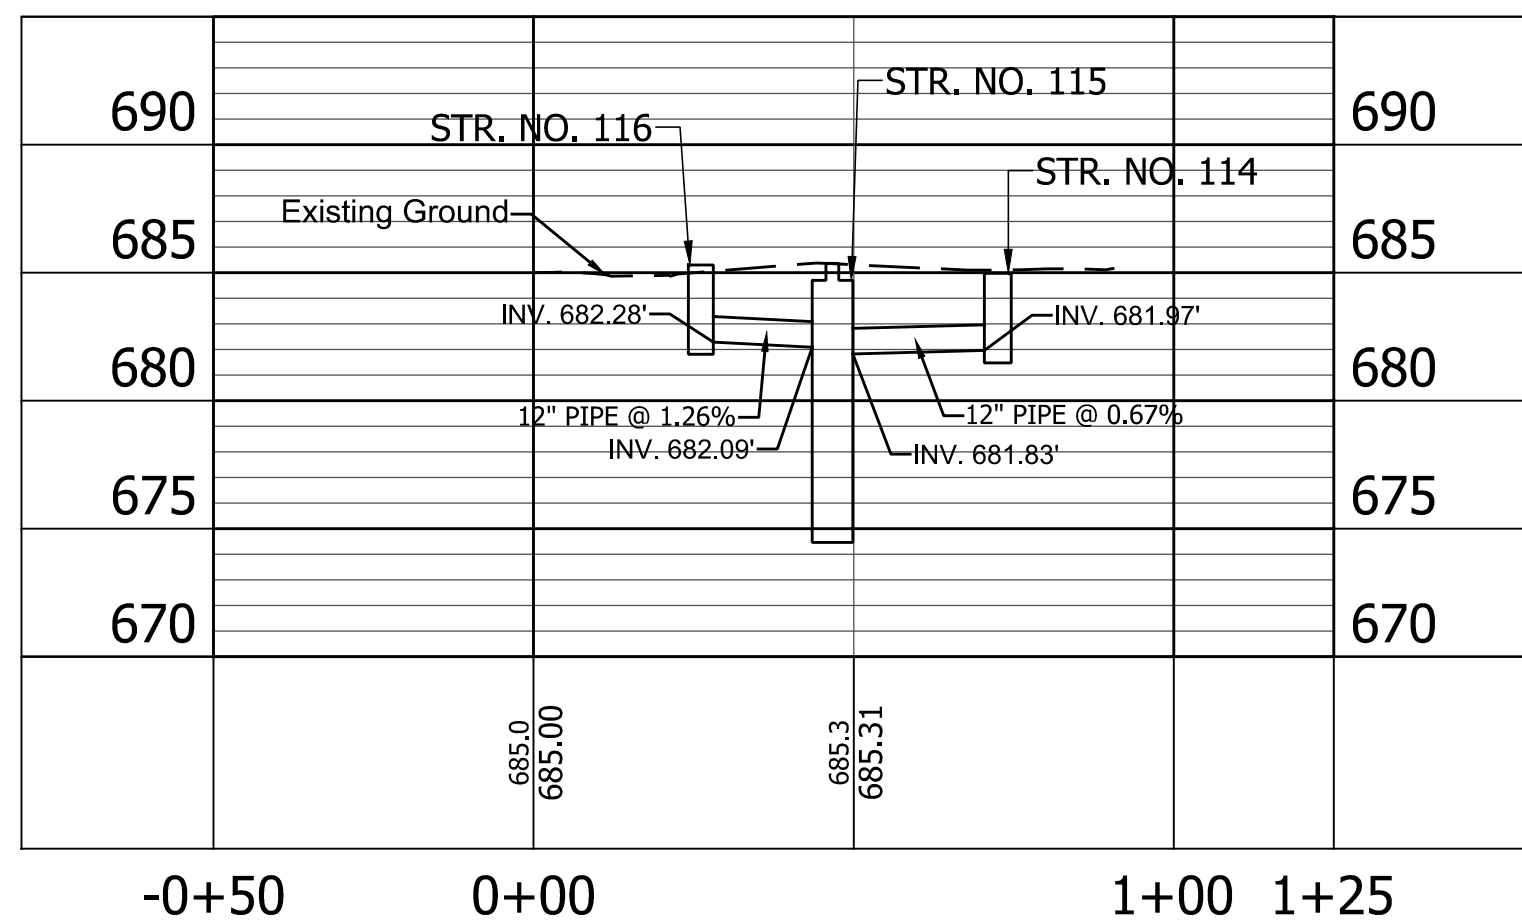


LINE "B" STR. 118 - STR. 124

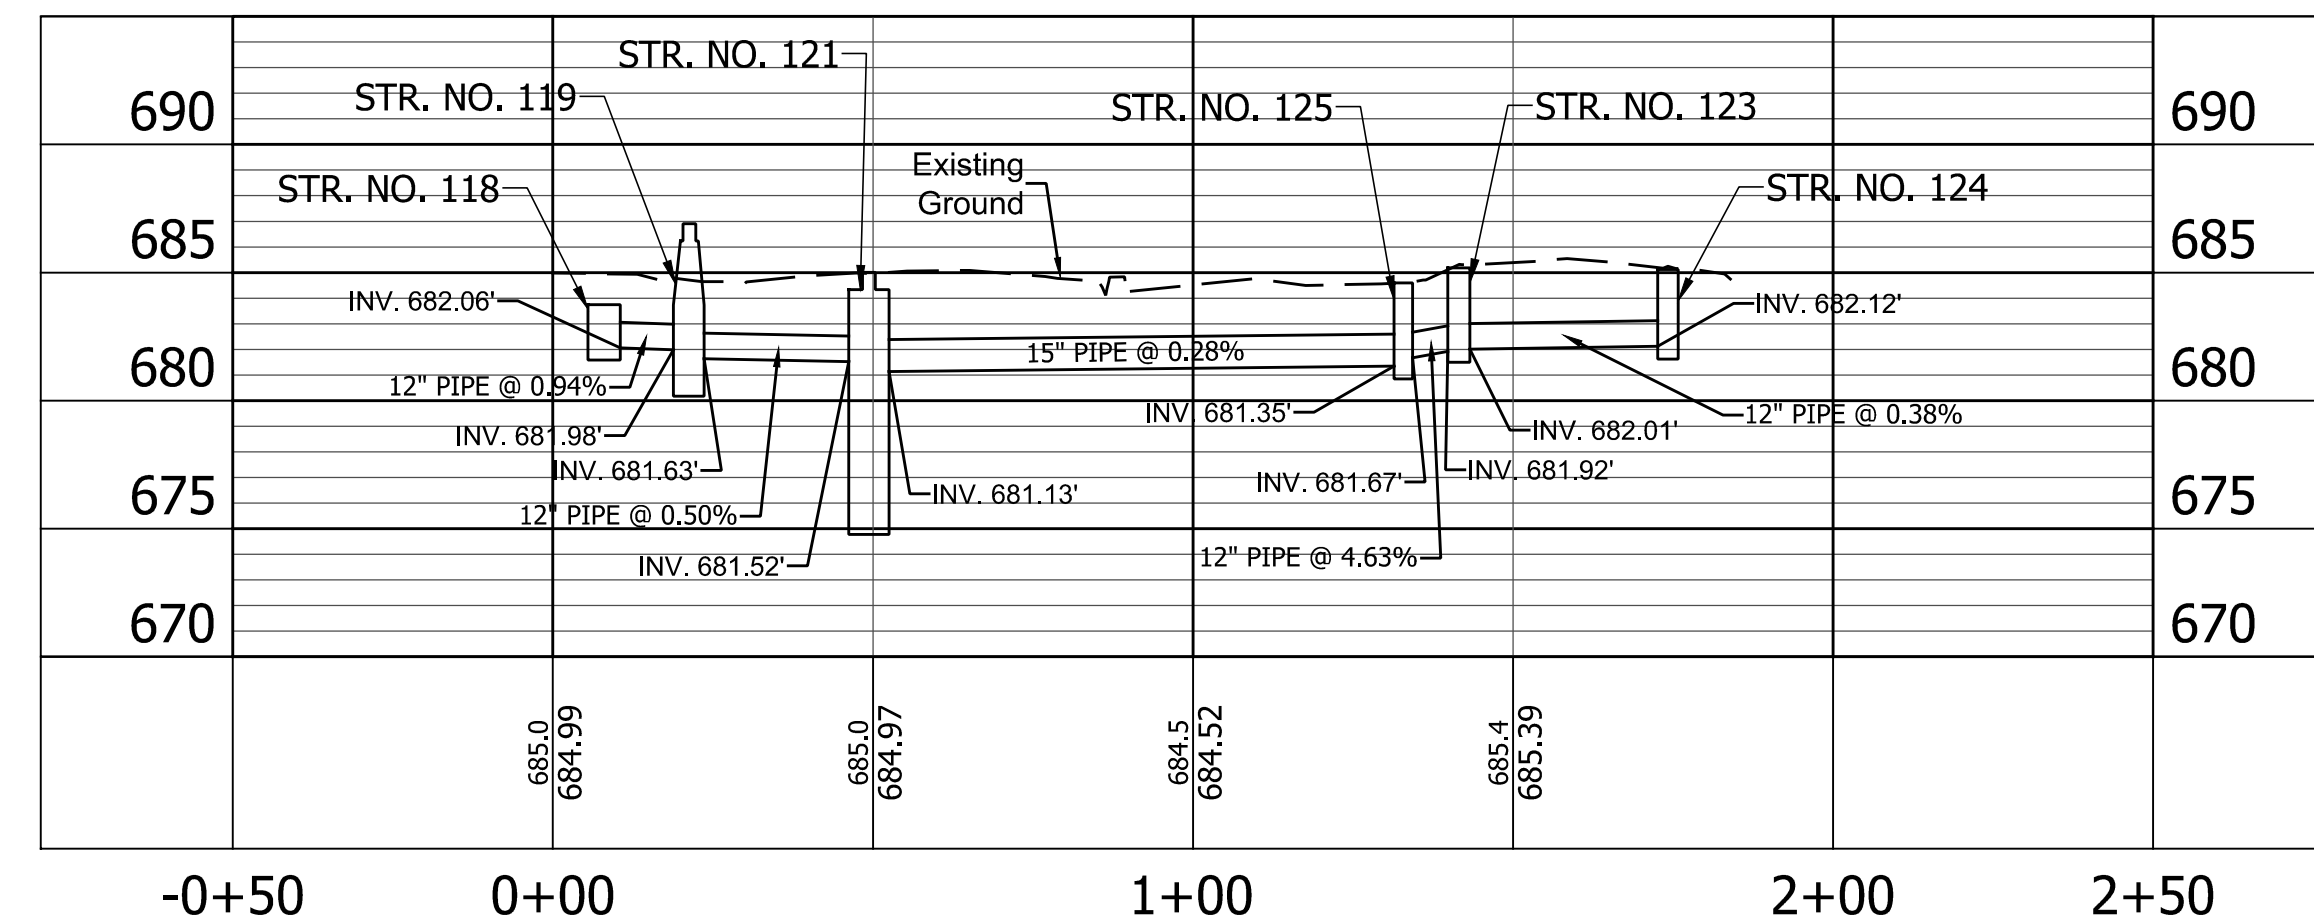

LINE "B" STR. 117 - STR. 119

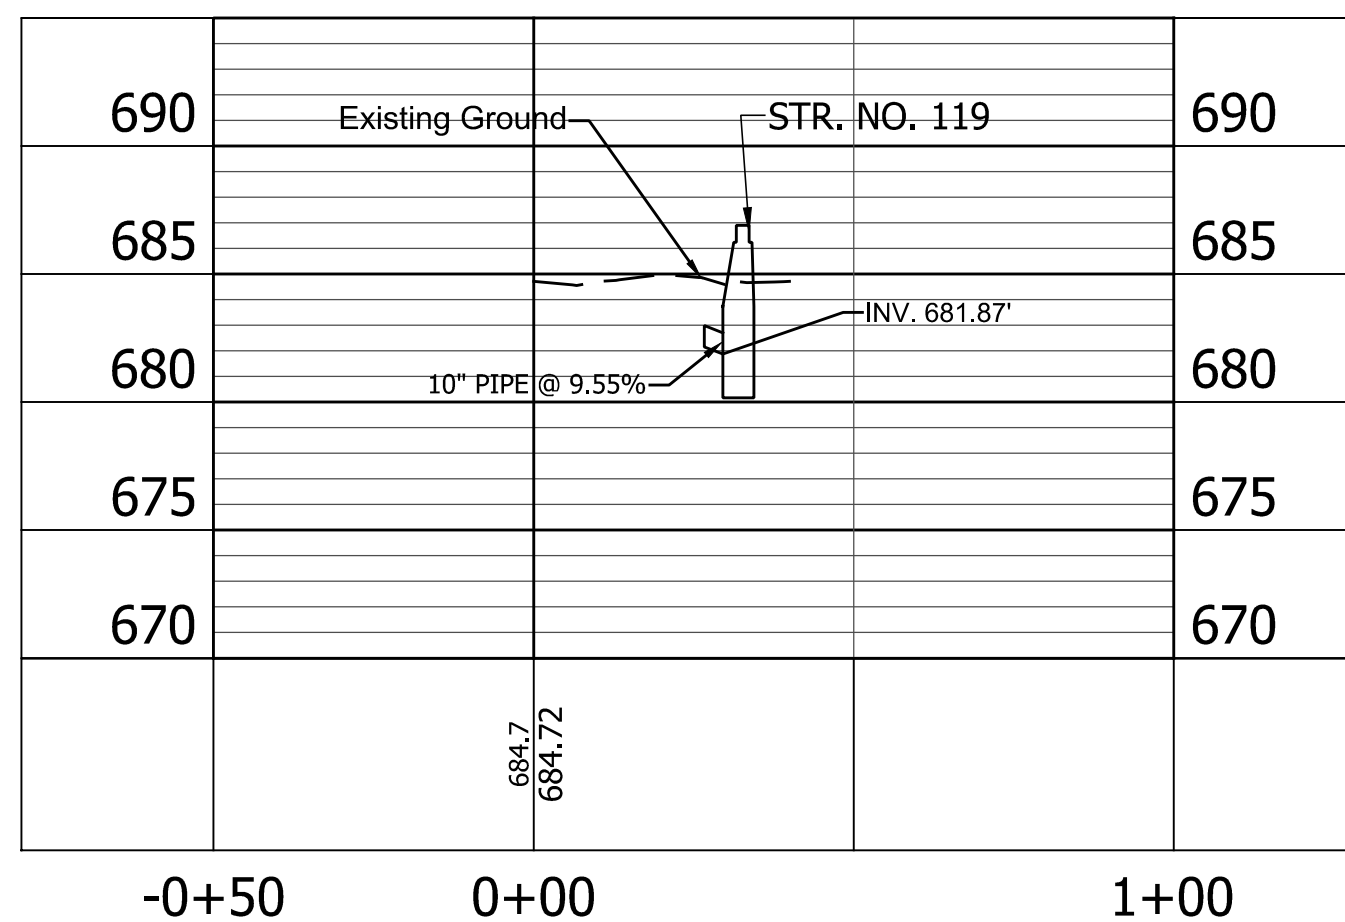

LINE "B" STR. 121 - STR. 122

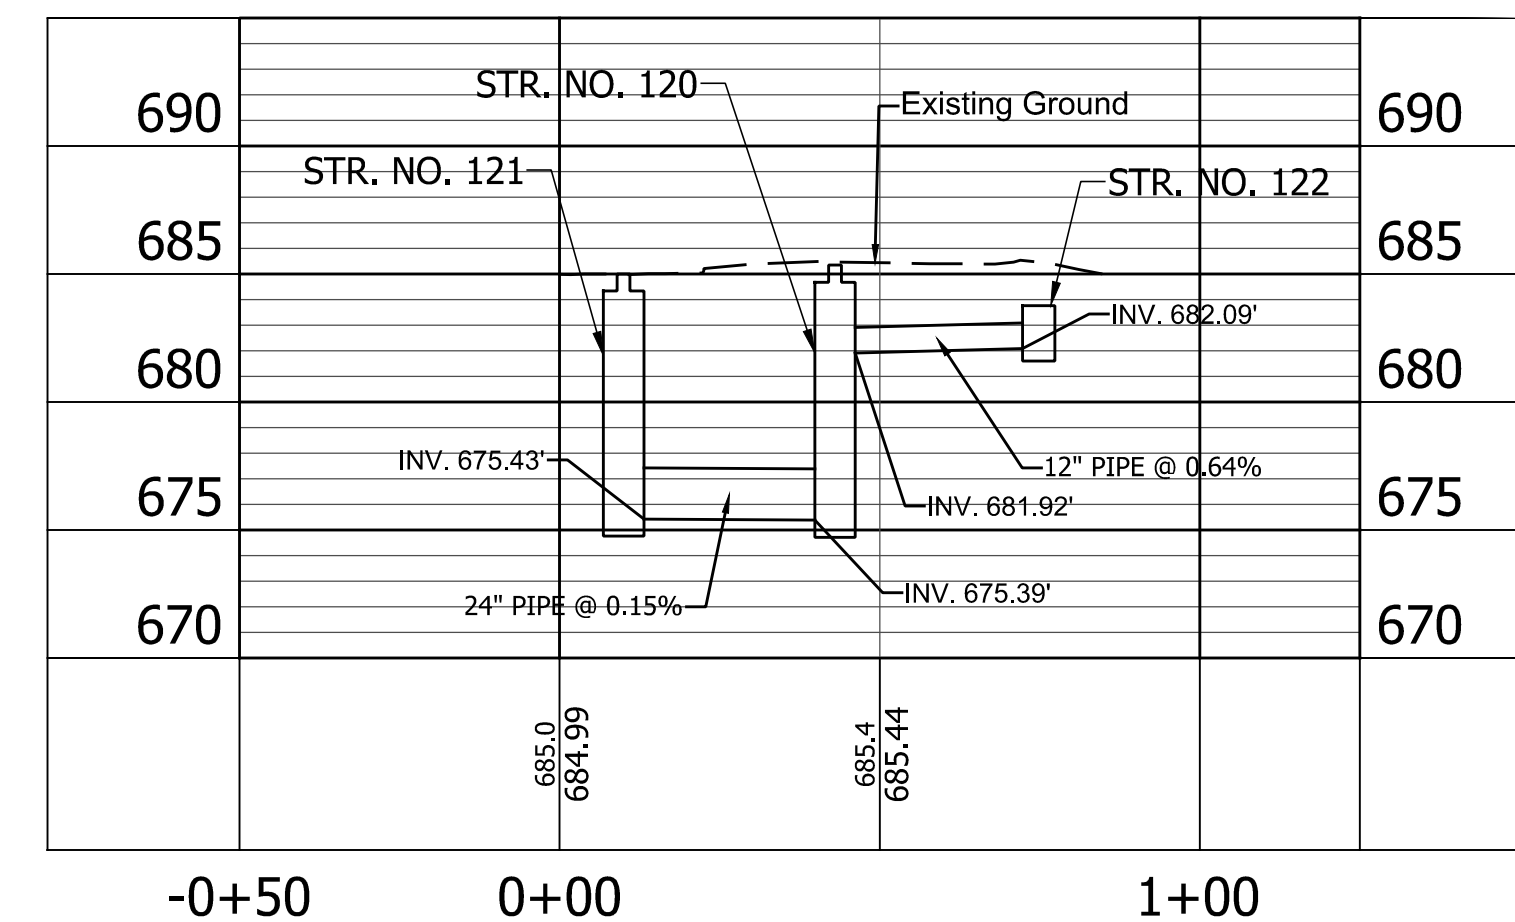

PRINT DATE: 4/5/23  
 PLOT SCALE: 1:1  
 EDIT DATE: 4/5/23 - 1:28 PM  
 EDITED BY: EKOWALSKI  
 DRAWING FILE: P:\21-500-155-1 WHITE CO PAVEMENT REPLACEMENT 210108\5 ACAD\66 PLAN PROF\RD\_STORM PROFILE SHEET\_A-B\_20\_01.DWG

RECOMMENDED FOR APPROVAL	DESIGN ENGINEER	DATE
DESIGNED: <u>BLW</u>	DRAWN: <u>EJK</u>	
CHECKED: <u>DCK</u>	CHECKED: <u>DCK</u>	

**INDIANA**  
**DEPARTMENT OF TRANSPORTATION**

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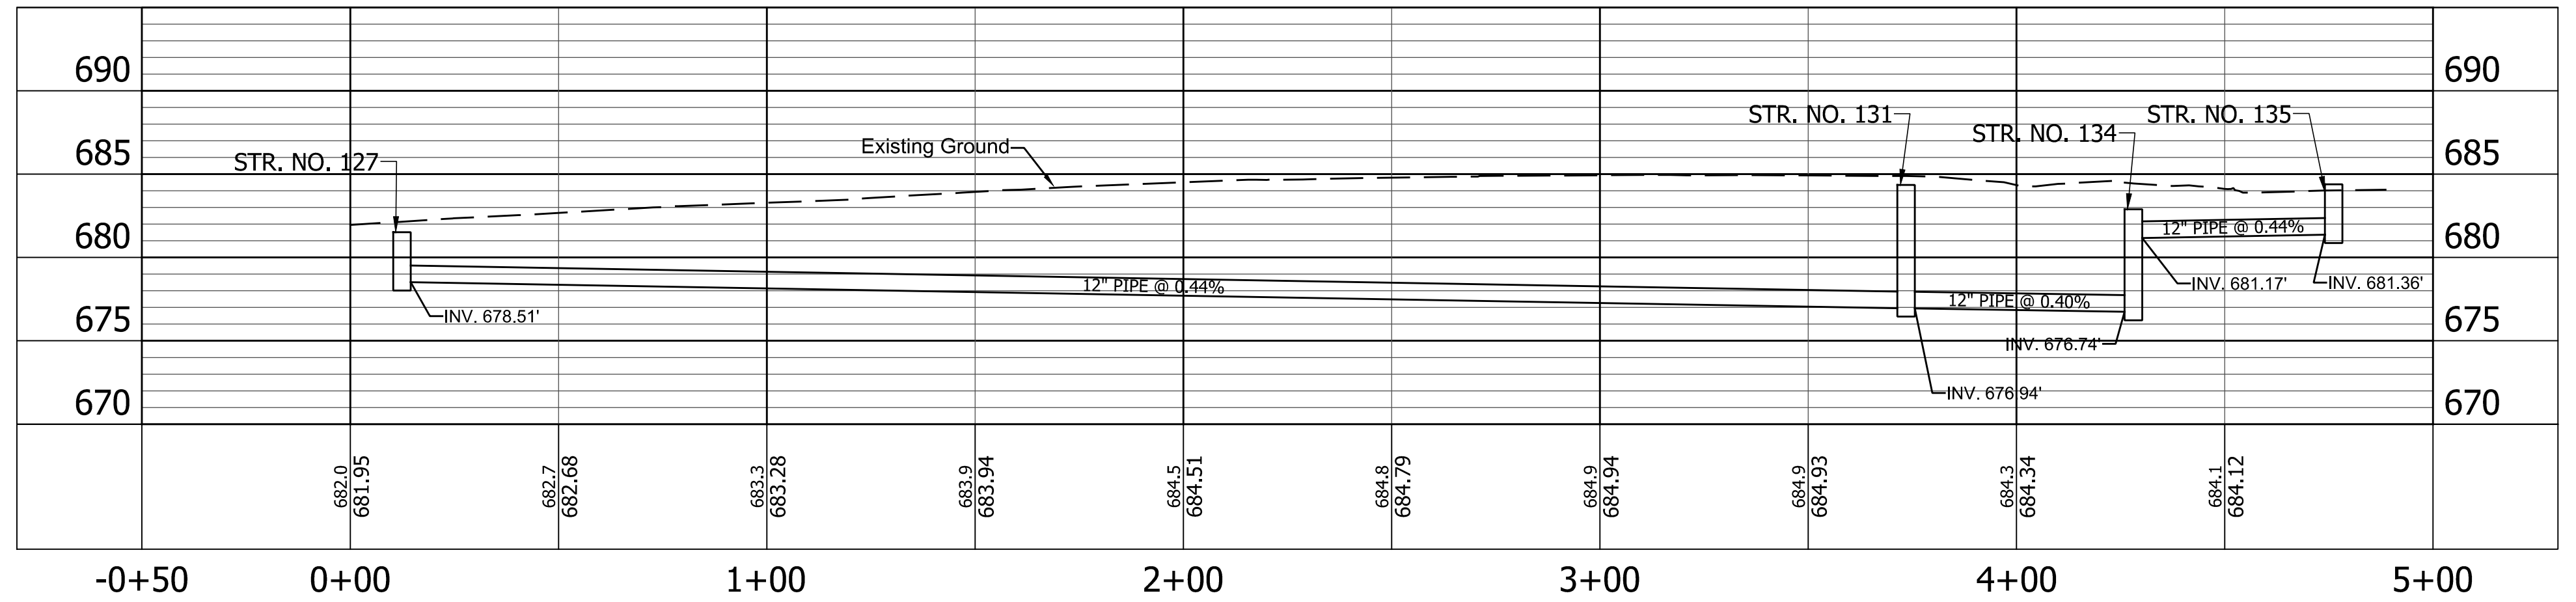
**STORM SEWER**  
**LINE "B" STORM PROFILES**

HORIZONTAL SCALE	BRIDGE FILE
1" = 20'	N/A
VERTICAL SCALE	DESIGNATION
1" = 5'	2001828
SURVEY BOOK	SHEET
	31 of 117
CONTRACT	PROJECT
R-43449	2001828




PRINT DATE: 4/5/23  
 PLOT SCALE: 1:1  
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 EDITED BY: EKOWALSKI  
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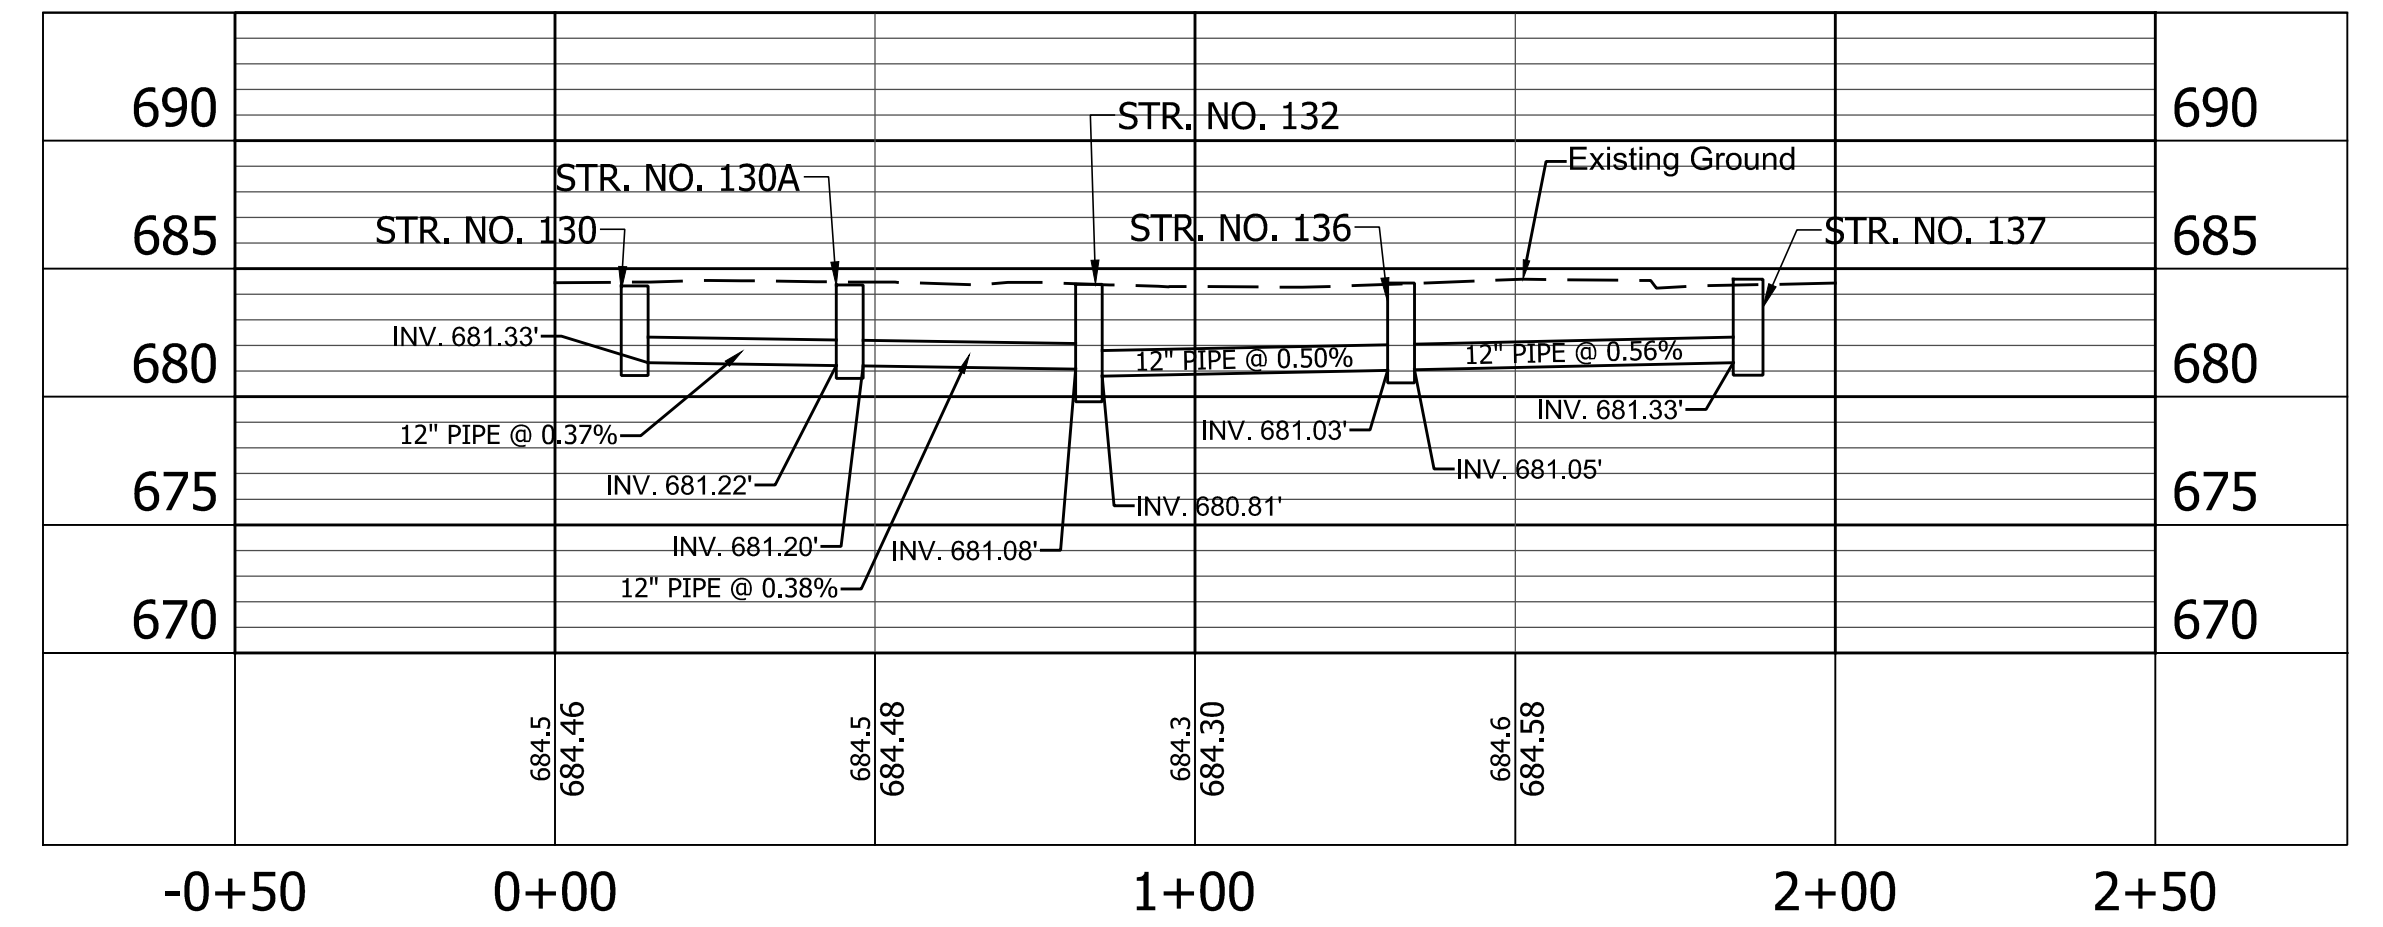
### LINE "A" STR. 127 - STR. 135



### LINE "A" STR. 134 - STR. 132

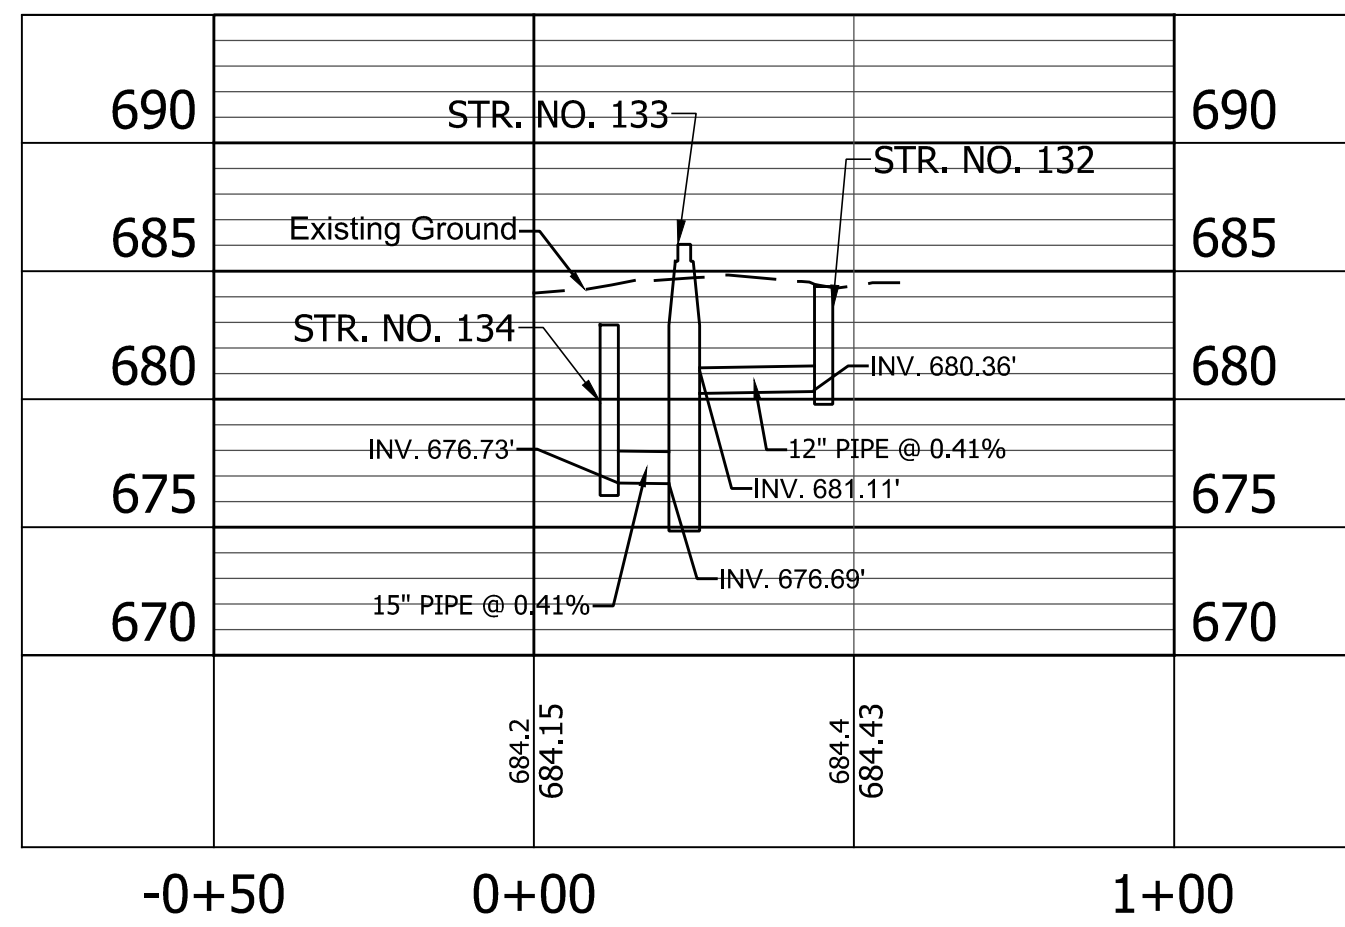

### LINE "A" STR. 130 - STR. 137



RECOMMENDED FOR APPROVAL		DESIGN ENGINEER	DATE
DESIGNED: <u>BLW</u>	DRAWN: <u>EJK</u>		
CHECKED: <u>DCK</u>	CHECKED: <u>DCK</u>		

**INDIANA**  
**DEPARTMENT OF TRANSPORTATION**

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**STORM SEWER**  
**LINE "A" STORM PROFILES**

HORIZONTAL SCALE	BRIDGE FILE
1" = 20'	N/A
VERTICAL SCALE	DESIGNATION
1" = 5'	2001828
SURVEY BOOK	SHEET
	32 of 117
CONTRACT	PROJECT
R-43449	2001828